

Community & Economic Development 420 College Street SE Lacey, Washington 98503 (360) 491-5642

COMMUNITY DEVELOPMENT DEPARTMENT PRESUBMISSION CONFERENCE AGENDA

- The following projects will be considered on **Wednesday**, **February 22**, **2023**
- VIA VIDEO CONFERENCE LINK WILL BE SENT PRIOR TO MEETING
- SPR Team Meeting will be held on the Tuesday prior to presub meeting date

Meeting Time	Assigned Staff	Project Details
R. Fant, 10:00 Planner		Case #23-0045 – "Nisqually Middle School Improvements" Address/Parcel: 8100 Steilacoom Road SE/11814130100
	T. Stiles, Public Works	Zoning: OSI-S, Open Space Institutional - School Description of Proposal: Proposed Student pick up/drop off w/covered waiting area, additional asphalt parking with 22 stalls, 425 SF asphalt bus lane & stormwater facility
11:00	S. Seymour, Planner	Case #22-0219 – "59 th & Stockton – T-Mobile" Address/Parcel: 59 th Loop SE & Stockton St SE/58440000000
	T. Stiles, Public Works	Zoning: OS-I, Open Space- Institutional Description of Proposal: Add new 10 x 15 ground equipment area to operate the antennas on the PSE pole & add 3 new antennas and mounts.
1:30	R. Fant, Planner	Case #23-0035 – "Oasis Multifamily Access" Address/Parcel: 4520 32 nd Lane SE/11829130700
	T. Stiles, Public Works	Zoning: MD, Moderate Density Description of Proposal: Oasis Multifamily – Exploring Options for Ingress/Egress
2:30		
3:30		

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FEB 14 2023

OFFICIAL USE ONLY



CITY OF LACEY BY 23-0045
Community Development Department
420 College Street SE
Lacey, WA 98503
(360) 491-5642

100		_
CASE NUMBER:		
RELATED CASE NUMBERS:	-	
PLANNER ASSIGNED:		
PW ASSIGNED:		

PRESUBMISSION CONFERENCE REQUEST FORM

ONE WEEK PRIOR TO REQUESTED DATE, SUBMIT VIA EMAIL TO PLANNING@CI.LACEY.WA.US, OR TO LACEY CITY HALL. NO FEE IS REQUIRED. SUBMISSION SHOULD INCLUDE COMPLETED APPLICATION, SITE PLAN DRAWING, VICINITY MAP, AND TRAFFIC GENERATION WORKSHEET.

APPLICANT: Dean Martinolich, North Thurston Public Schools ADDRESS: 6620 Carpenter Rd SE CITY: Lacey STATE: WA ZIP: 98503 PHONE NUMBER: (306) 412-4500 EMAIL: dmartinolich@nthurston.k12.wa.us REPRESENTATIVE: Alyssa Ardourel, Huitt-Zollars ZIP: 98101 ADDRESS: 1700 7th Ave, Suite 2075 CITY: Seattle STATE: WA EMAIL: aardourel@Huitt-Zollars.com (206) 324-5500 PHONE NUMBER: PROJECT ADDRESS: 8100 Steilacoom Rd SE, Lacey, WA 98503 ASSESSOR'S TAX PARCEL NUMBER(S): 11814130100 BRIEF DESCRIPTION OF PROJECT: Proposed student pick up/drop off w/ covered waiting area, ex Marvin Rd access improvements, additional asphalt parking w/ approx. 22 stalls, approx. 425 LF asphalt bus lane & stormwater facility. TOTAL SQ. FT OF BLDG: none proposed TOTAL ACREAGE: 28.99 OSI-S-OPEN SPACE INST ZONING: No proposed changes in land use. Will remain OSI-S PROPOSED LAND USE: () SINGLE-FAMILY () MULTI-FAMILY () INDUSTRIAL I () INDUSTRIAL DUPLEX () COMMERCIAL PROPOSED ACCESS: Marvin Rd SE Steilacoom Rd SE **EXISTING ACCESS:**


INDICATE PREFERENCE FOR A MEETING DATE AND TIME:


(MEETINGS ARE HELD THE 2ND AND 4TH WEDNESDAY OF EACH MONTH)

DATE: 2122

DATE: 2/22/23 TIME: 10:00am or 3:30pm


A presubmission conference is an opportunity for the developer and/or their representative to meet with staff to discuss preliminary studies or sketches of the proposed project. At the conference, staff will make available, pertinent information relating to the proposed development. The intent is to identify and/or eliminate as many potential problems as possible in order for the project to be processed without delay. The conference should take place prior to detailed work by an engineer or surveyor; however, the site drawing submitted, should have sufficient information to allow for staff review. Discussion topics will include such things as Comprehensive Plan, Street Plan, Storm Run Off & Retention, Shoreline Master Program, Zoning, Availability of Water/Sewer, Development Concepts, other requirements and permits, and the environmental impact. If the applicant owns adjacent land, the possibilities of future development will be discussed. Written information regarding process, specific requirements & related issues, will be furnished at the meeting. Staff will typically visit the site prior to the meeting and may enter the property if deemed necessary to gain a full understanding of the project.

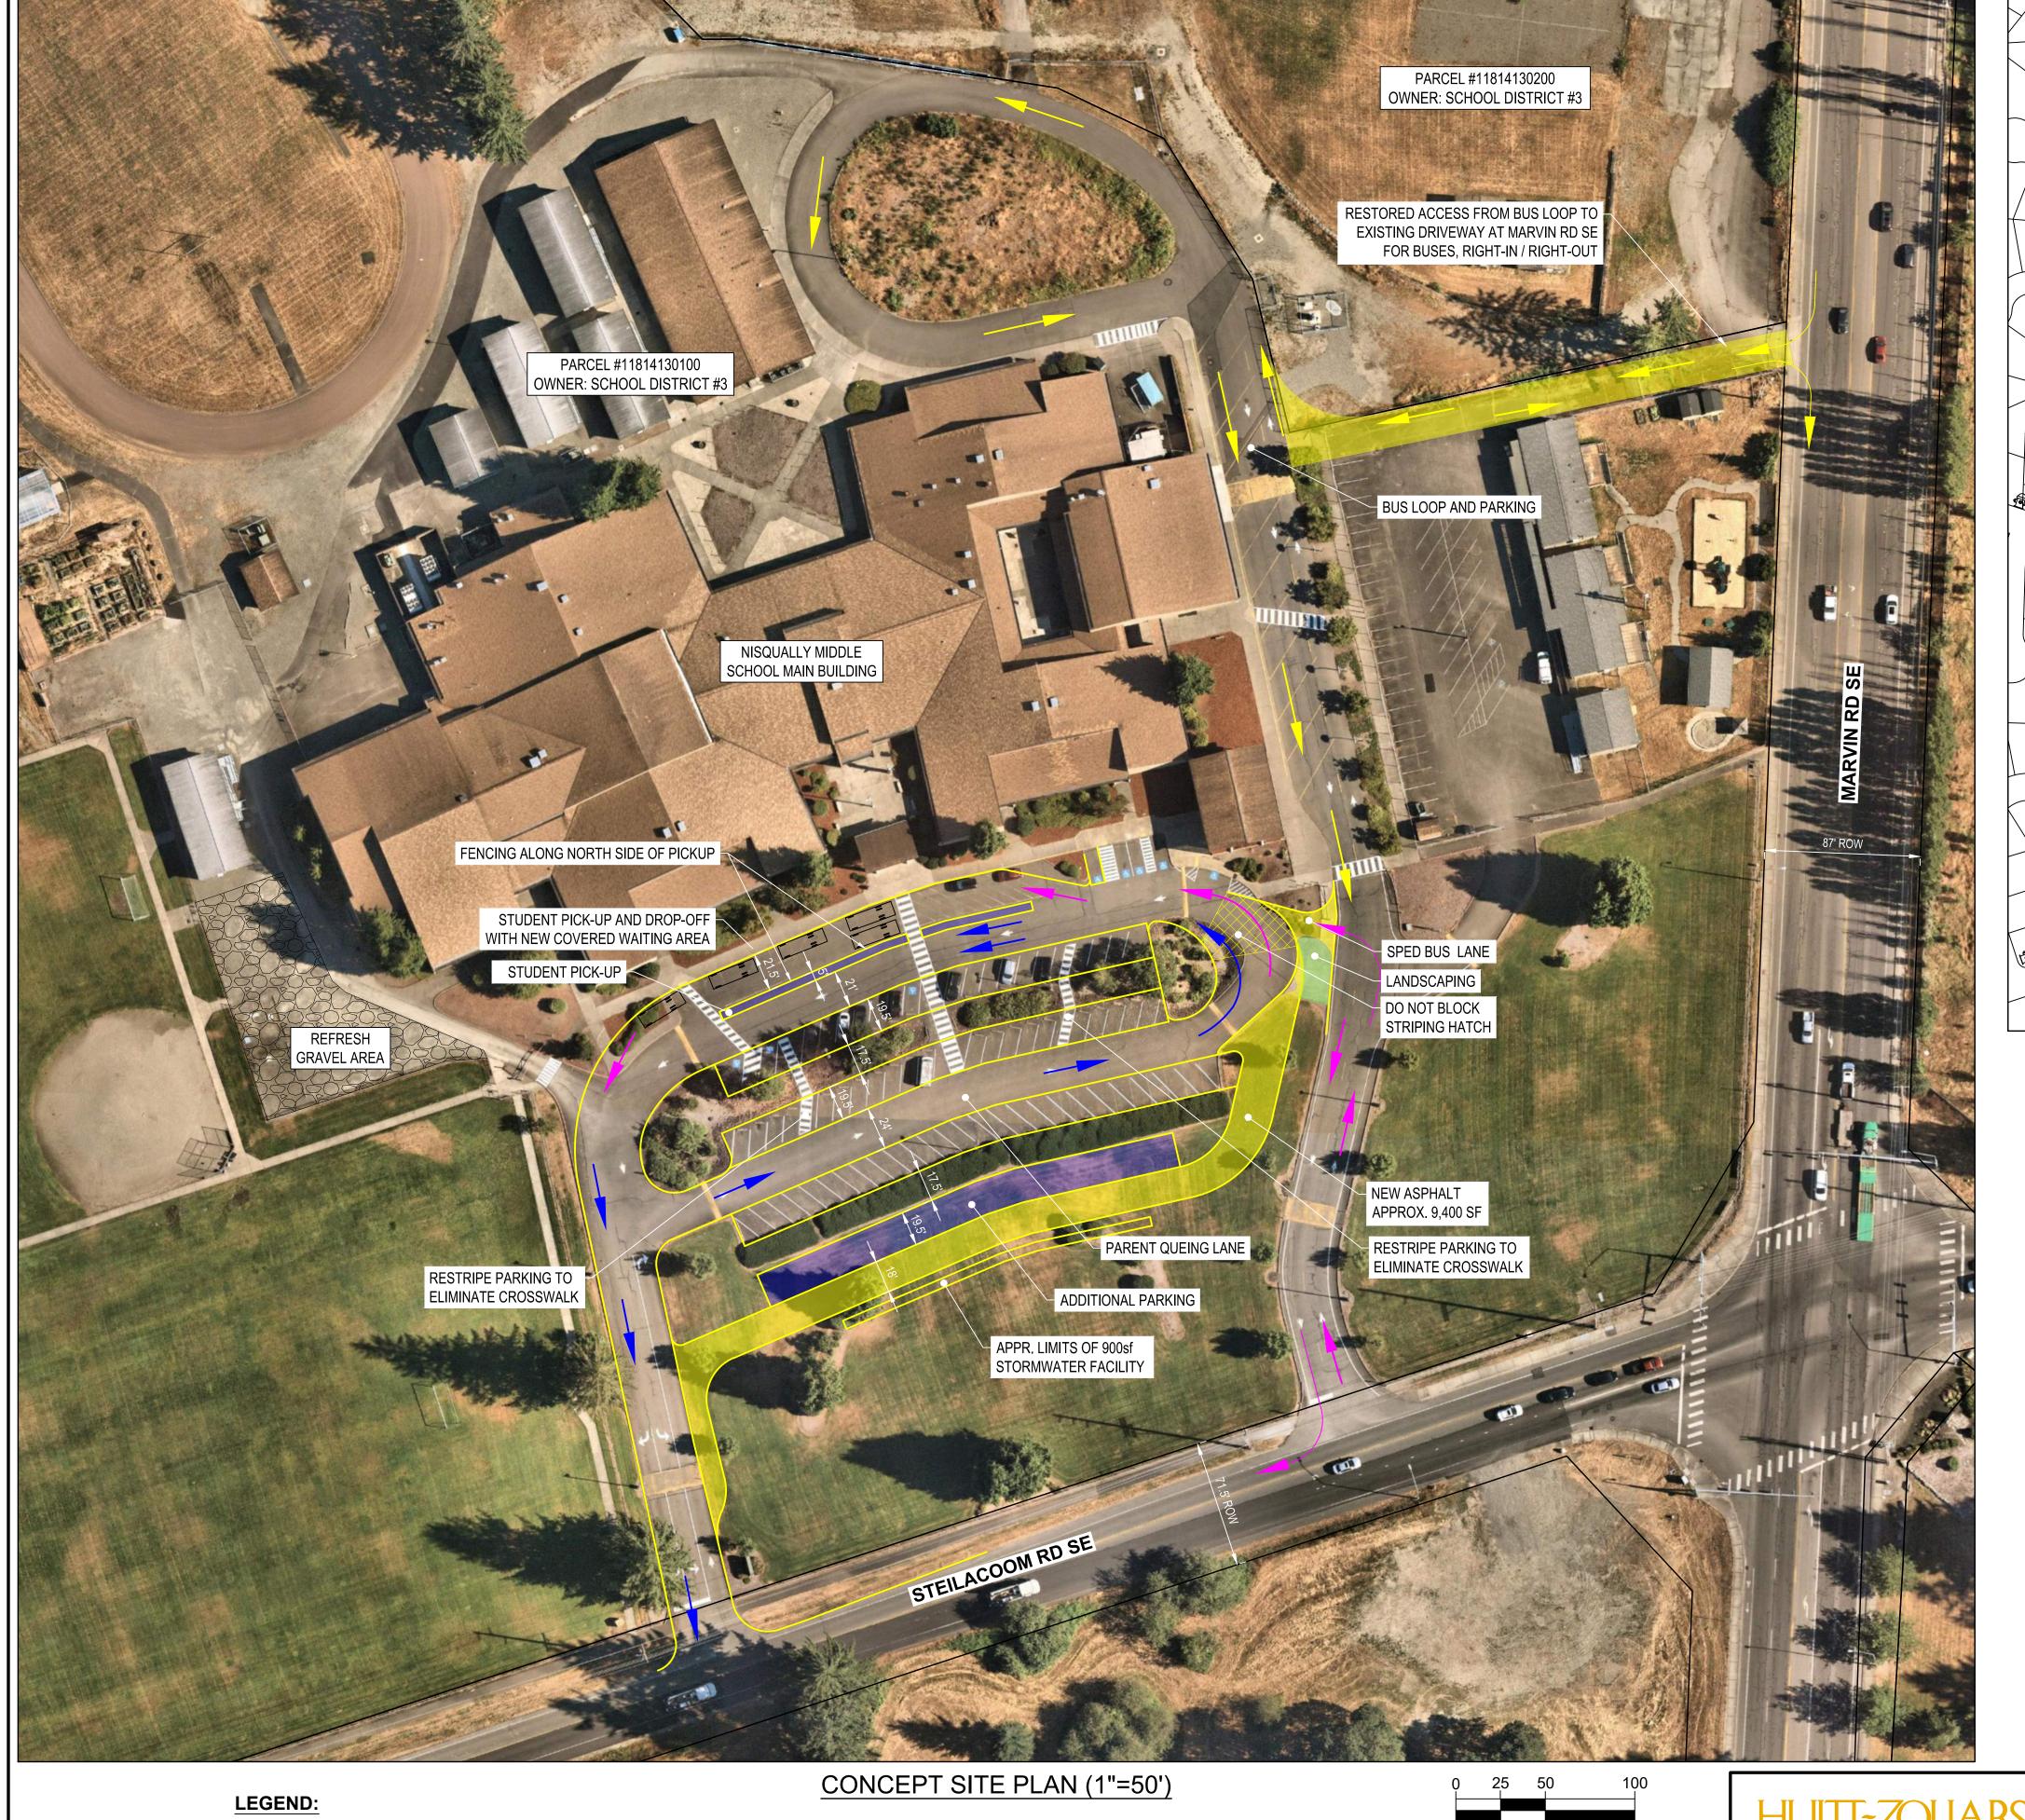

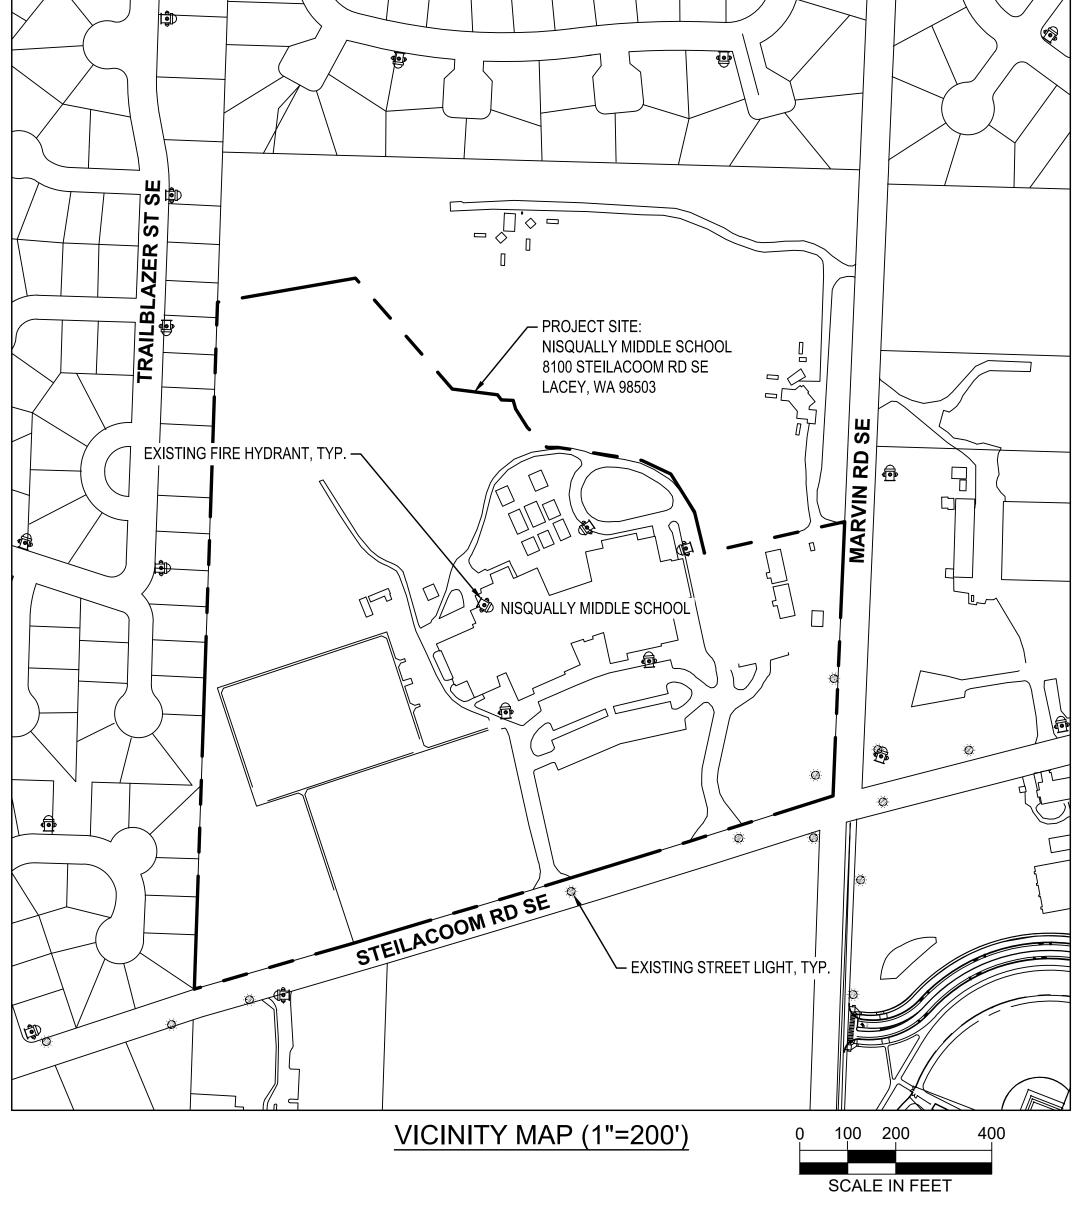

DRAFT

SPED BUSES STANDARD BUSES PARENT VEHICLES

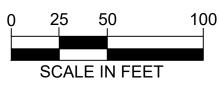

HUITT-ZOLIARS

1700 7TH AVENUE, SUITE 2075 SEATTLE, WASHINGTON, 98101 206-324-5500 www.huitt-zollars.com ADVANCE**DESIGN**™

PRELIMINARY CONCEPT SITE PLAN AND VICINITY MAP

NISQUALLY MIDDLE SCHOOL SAFETY AND SEPARATION

8100 STEILACOOM RD SE LACEY, WA 98503

NORTH THURSTON PUBLIC SCHOOLS 6620 CARPENTER RD SE LACEY, WA 98503

	HZ PROJECT NO.:	R316039.01
	ISSUE DATE:	FEBRUARY 15, 2023
	DRAWN BY:	GNW
_	REVIEWED BY:	ADA
	4	4
	SHEET	OF



School hours: 9:20 am - 3:50 pm.

FORM: CTRAFF-2

City of Lacey DEPARTMENT OF PUBLIC WORKS 420 College Street S.E. Lacey, WA 98503-1238 (360) 491-5600

COMMERCIAL TRAFFIC GENERATION WORKSHEET

Date: 2/15/2023	Project No.: <u>R316039.01</u>			
Project Name: Nisqually MS Safety & Separation	Parcel No.: 11814130100			
Project Address: 8100 Steilacoom Rd SE, Lacey, WA 9850	3			
Applicant's Name: Dean Martinolich	Phone: <u>(360) 412-4500</u>			
Applicant's Address: 6620 Carpenter Rd SE, Lacey, WA 985	503			
Existing Use				
Is there an existing use on the proposed project site:				
Has the existing use been vacant for more than 18 months?	Yes X No			
Will any of the existing buildings be demolished?	Yes No			
Please explain the current use, if any (type of business; business license number, if available; size in gross square feet; number of employees; hours of operation, etc.):				
Current use is an existing middle school within the 28.99 acre (1,262,623 SF) property.				
Gross square footage of existing buildings is approximately 117,000 SF.				
Currently, there are 86 staff and 849 students. Historically, the highest student count was 928 students with staff counts remaining approximately consistent.				

Proposed Use (Include Site Plan)

Commercial projects can cover a wide variety of land uses, not all uses are covered in the Trip Generation Manual. A private traffic engineer may be required for exceptional proposals. Please provide as much information as possible, if applicable to your development:

Project Site Gross Acres: 28.99 Acres

Number of Gas Pumps / Fueling Positions: N/A

Building Size Gross Square Feet: N/A

Number of Drive-through Windows: N/A

Number of Employees: 86 staff (current)

Number of Service Bays: N/A

Number of Parking Stalls: 22 new stalls

Number of Students / Children: 849 students (current)

Number of Seats (Theaters, etc.): N/A

Please explain the proposed use (type of business and all other information not provided above that you feel is relevant in determining traffic generation):

Number of Courts / Fields / Tees: N/A

The proposed use will remain as OSI-S (Open Space Institutional), a middle school. The project makes safety and circulation improvements and includes, but not limited to, a new student pick up/drop off with covered waiting area, additional asphalt parking area with 22 stalls, existing Marvin Rd SE access improvements, an approximately 425 LF asphalt bus lane and a stormwater facility.

I declare that I have completed this form and to the best of my knowledge and belief the above information is true and correct. I understand the City is relying on this information to accurately determine the traffic impacts from my development.

1 1

Signature	the	sser thouse	Date: 02/15/2023
Ü	on behalf of	North Thurston Public Schools	

For Official Use Only:	Approved for Traffic Division By:
HTE Number:	Approved for Traine Division by.
Development Reviewer:	Planner:
Land Use Code:	Discounts Applied:
Total PM Peak Hour Trips:	New PM Peak Hour Trips:
Comments:	

Number of Rooms (Hotels, etc.): N/A

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RECEIVED



FFB 0 9 2023 **CITY OF LACEY**

Community Development Department 22-0219 420 College Street 52

Lacey, WA 98503 (360) 491-5642

OFFICIAL USE ONLY

CASE NUMBER:

RELATED CASE NUMBERS:

PLANNER ASSIGNED:

PW ASSIGNED:

PRESUBMISSION CONFERENCE REQUEST FORM

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APPLICANT: Lynx Consulting on behalf of T-Mobile - contact: Marianne Boring

17311 135th Ave NE, Suite A-100 ADDRESS:

CITY: Woodinville STATE: WA

ZIP: 98072

PHONE NUMBER: 509.531.5475

EMAIL: marianne.boring1@gmail.com

REPRESENTATIVE: Lynx Consulting on behalf of T-Mobile - contact: Marianne Boring

ADDRESS: 17311 135th Ave NE, Suite A-100

CITY: Woodinville STATE: WA

ZIP. 98072

PHONE NUMBER:

509.531.5475

EMAIL: marianne.boring1@gmail.com

PROJECT ADDRESS: 59th Lp SE & Stockton St SE

ASSESSOR'S TAX PARCEL NUMBER(S): 5844000000

BRIEF DESCRIPTION OF PROJECT: T-Mobile is proposing to add new 10' x 15' ground equipment area to operate

the antennas on the PSE pole as well as add (3) new antennas and mounts.

TOTAL ACREAGE: 19.59 (parcel TOTAL SQ. FT OF BLDG: 150' (pad area

ZONING:

OS-1

PROPOSED LAND USE: () SINGLE-FAMILY () MULTI-FAMILY () INDUSTRIAL DUPLEX () COMMERCIAL

() M.H. PARK

EXISTING ACCESS: Stockton St SE

PROPOSED ACCESS: Unchanged

INDICATE PREFERENCE FOR A MEETING DATE AND TIME:

(MEETINGS ARE HELD THE 2ND AND 4TH WEDNESDAY OF EACH MONTH)

A presubmission conference is an opportunity for the developer and/or their representative to meet with staff to discuss preliminary studies or sketches of the proposed project. At the conference, staff will make available, pertinent information relating to the proposed development. The intent is to identify and/or eliminate as many potential problems as possible in order for the project to be processed without delay. The conference should take place prior to detailed work by an engineer or surveyor; however, the site drawing submitted, should have sufficient information to allow for staff review. Discussion topics will include such things as Comprehensive Plan, Street Plan, Storm Run Off & Retention, Shoreline Master Program, Zoning, Availability of Water/Sewer, Development Concepts, other requirements and permits, and the environmental impact. If the applicant owns adjacent land, the possibilities of future development will be discussed. Written information regarding process, specific requirements & related issues, will be furnished at the meeting. Staff will typically visit the site prior to the meeting and may enter the property if deemed necessary to gain a full understanding of the project.

T--Mobile-


OLYMPIA LACEY AMTRAK/PSE/LP HOA

59TH LP SE & STOCKTON ST SE LACEY, WA 98513

RFDS: VER: 3
PROJECT: ANCHOR

SITE NUMBER: SE05317B

LATITUDE 46° 59' 45.9702" N (46.996103) LONGITUDE 122° 47' 39.7716" W (-122.794381) PROJECT: ANCHOR

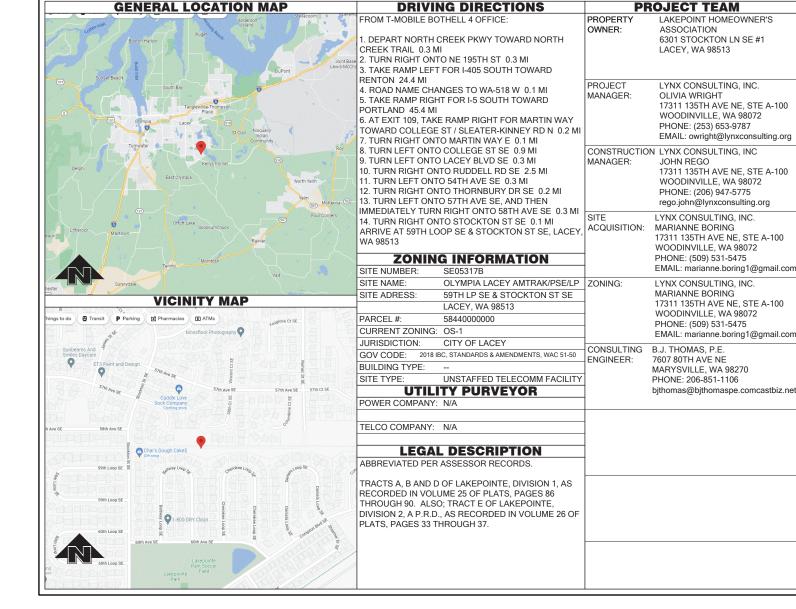

PROJECT DESCRIPTION T-MOBILE PROPOSES TO MODIFY AN EXISTING WIRELESS FACILITY WITH THE FOLLOWING SCOPE OF WORK: SOW @ ANTENNAS:

KEEP (3) #FFHH-65C-R3 ANTENNAS. KEEP (3) AHLOA.
REMOVE (3) FHFB, (3) FRIG, (12) DIPLEXERS & (1)
COVP. REMOVE ALL UNUSED RING MOUNTS. KEEP (2)
UNIVERSAL RING MOUNTS. INSTALL (6) #DSM2
STANDOFF MOUNTS (2 PER SECTOR). INSTALL (3)
#AEHC ANTENNAS (1 PER SECTOR). INSTALL (3)
AHFIG (1 PER SECTOR). MOUNT AHLOA & AHFIG BACK
TO BACK BEHIND ANTENNA. INSTALL (2) HCS 2.0
PENDANTS BELOW ANTENNAS ON WOOD POLE. ADD
A-4 TO A-8 GENEI
(1) 125' HCS 2.0 HYBRID TRUNK CABLES.

SOW @ GROUND LEVEL: REMOVE (2) AMOBS ON POLE. REMOVE FLX16-3030 CABINET & (1) COVP.

INSTALL NEW 15' x 10' WOOD FENCED COMPOUND.
ADD (1) HPL3 600A LARGE SITE SUPPORT CABINET, (1)
LB3 BATTERY CABINET, (2) HCS 2.0 TOWER JUNCTION
BOXES. ADD (1) 200A EMERSON PANEL, 200A METER
BASE, AAV CUBE & LED TECH LIGHT ON NEW
UNISTRUT H-FRAME. INSTALL 2' x 14' ICE BRIDGE FOR
CABLE ROUTING. ADD 8' x 11' CONCRETE PAD.

CODE COMPLIANCE

ALL WORK AND MATERIALS SHALL BE PERFORMED AND INSTALLED IN ACCORDANCE WITH THE CURRENT EDITIONS OF THE FOLLOWING CODES AS ADOPTED BY THE LOCAL GOVERNING AUTHORITIES. NOTHING ON THESE PLANS IS TO BE CONSTRUCTED TO PERMIT WORK NOT CONFORMING TO THESE CODES:

2018 IBC, STANDARDS & AMENDMENTS, WAC 51-50
2018 IMC, STANDARDS & AMENDMENTS, WAC 51-52
2018 IFC, STANDARDS & AMENDMENTS, WAC 51-54
2020 NFPA 54 - NATIONAL FUEL GAS CODE
(PROPANE INSTALLATIONS ONLY)
2020 NFPA 58 - LIQUEFIED PETROLEUM GAS CODE
(PROPANE INSTALLATIONS ONLY)
2018 INTERNATIONAL FIRE CODE

2018 INTERNATIONAL FIRE CODE
2018 UPC, STANDARDS & AMENDMENTS, WAC 51-56,
51-57
2020 NATIONAL ELECTRICAL CODE
2017 NATIONAL ELECTRIC SAFETY CODE
LOCAL BUILDING CODE ORDINANCES

ANSI / TIA / EIA - 222 - H - 2017 NFPA-101 - LIFE SAFETY CODE

TITLE SHEET & PROJECT DATA G-1 GENERAL NOTES A-1 OVERALL SITE PLAN A-1.1 EXISTING ENLARGED SITE PLAN A-1.2 PROPOSED ENLARGED SITE PLAN A-2 EXISTING & PROPOSED SITE ELEVATION RF-1 1 SEP DETAILS RF-2 RF DETAILS A-3 BTS EQUIPMENT DETAILS A-3.1 BTS EQUIPMENT DETAILS A-4 TO A-8 GENERAL DETAILS A-9 ANTENNA MOLINT DETAILS E-1 ELECTRICAL SITE PLAN E-1.1 ELECTRICAL DETAILS E-1.2 ELECTRICAL DIAGRAMS E-1.3 ELECTRICAL DIAGRAMS E-2 ELECTRICAL GROUNDING PLAN

DRAWING INDEX

PROJECT INFORMATION

THIS IS UNSTAFFED AND RESTRICTED EQUIPMENT AND WILL BE USED FOR THE TRANSMISSION OF RADIO SIGNALS FOR THE PURPOSE OF PROVIDING PUBLIC CELLULAR SERVICE.

T-MOBILE CERTIFIES THAT THIS TELEPHONE EQUIPMENT FACILITY WILL BE SERVICED ONLY BY T-MOBILE EMPLOYEES AND THE WORK ASSOCIATED WITH ANY EQUIPMENT CANNOT BE PERFORMED BY HANDICAPPED PERSONS. THIS FACILITY WILL BE FREQUENTED ONLY BY SERVICE PERSONNEL FOR REPAIR PURPOSES. PURSUANT TO THE AMERICANS WITH DISABILITIES ACT (ADA), APPENDIX B SECTION 4.11. (5)(b), THIS FACILITY IS EXEMPT FROM THAT ACT.

NO POTABLE WATER SUPPLY IS TO BE PROVIDED AT THIS LOCATION. NO WASTE WATER OR SOLID WASTE WILL BE GENERATED AT THIS LOCATION.

T-MOBILE MAINTENANCE CREW (ONE PERSON) WILL MAKE AN AVERAGE OF ONE TRIP PER MONTH AT ONE HOUR PER TRIP.

APPROVAL/SIGN OFF OF CONST DRAWINGS

REVIEWERS SHALL CLEARLY PLACE INITIALS ADJACENT TO EACH
REDLINE NOTE AS DRAWINGS ARE BEING REVIEWED.

CONSULTANT GROUP SIGN OFF

LANDLORD'S REPRESENTATIVE:	DATE:
CONSTRUCTION MANAGER:	DATE:
CONSTRUCTION PROJECT MANAGER:	DATE:
PROJECT MANAGER:	DATE:
SITE ACQUISITION:	DATE:
ZONING:	DATE:
RF ENGINEER:	DATE:

T - - Mobile-

=PROJECT INFORMATION:=

OLYMPIA LACEY AMTRAK/PSE/LP HOA SE05317B

59TH LP SE & STOCKTON ST SE LACEY. WA 98513

=ISSUED FOR:=

REVISION HISTORY:

BUILDING PERMIT

NO. DATE:		DESCRIPTION:	BY:
3	12/7/2022	MINOR REV	BJT
2	12/6/2022	REVISED PER REDLINES	BJT
1	11/15/2022	ISSUED DESIGN REVIEW	BJT

PLANS PREPARED BY:

B. J. THOMAS, P.E. 7607 80TH AVE NE MARYSVILLE, WA 98270 206-851-1106

BJ

DRAWN BY	/:	=снк.	BY:

=LICENSURE:=



DRAWING INFORMATION:=

DO NOT SCALE DRAWINGS. CONTRACTOR MUST VERIFY ALL DIMENSIONS AND ADVISE CONSULTANTS OF ANY ERRORS AND OMISSIONS. ALL PREVIOUS ISSUES OF THIS DRAWING ARE SUPERSEDED BY THE LATEST REVISION. THE INFORMATION CONTAINED IN THIS SET OF DOCUMENTS IS PROPRIETARY BY NATURE. ANY USE OR DISCLOSURE OTHER THAN WHICH IS RELATED TO NAMED CLIENT IS STRICTLY PROHIBITED.

=DRAWING TITLE:===

TITLE SHEET

DRAWING NUMBER:

T-1

GENERAL NOTES:

- 1. DRAWINGS ARE NOT TO BE SCALED, WRITTEN DIMENSIONS TAKE PRECEDENCE, THIS SET OF DOCUMENTS IS INTENDED TO BE USED FOR DIAGRAMMATIC PURPOSED ONLY. UNLESS NOTED OTHERWISE. THE GENERAL CONTRACTOR'S SCOPE OF WORK SHALL INCLUDE FURNISHING ALL MATERIALS, EQUIPMENT, LABOR AND ANY REQUIREMENTS DEEMED NECESSARY TO COMPLETE INSTALLATION AS DESCRIBED IN THE DRAWINGS AND OWNER'S PROJECT MANUAL
- 2. THE CONTRACTOR IS RESPONSIBLE FOR ALL DIMENSIONS AND STANDARDIZED DETAILS THAT REQUIRE MODIFICATIONS DUE TO ACTUAL FIELD CONDITIONS AND REQUIREMENTS MUST BE SUBMITTED TO AND APPROVED BY, T-MOBILE WIRELESS REPRESENTATIVE PRIOR TO START OF WORK.
- 3. PRIOR TO THE SUBMISSION OF BIDS, CONTRACTORS INVOLVED SHALL VISIT THE JOB SITE TO FAMILIARIZE THEMSELVES WITH ALL CONDITIONS AFFECTING THE PROPOSED PROJECT. CONTRACTORS SHALL VISIT THE CONSTRUCTION SITE WITH THE CONSTRUCTION/CONTRACT DOCUMENTS TO VERIEY FIELD CONDITIONS AND CONFIRM THAT THE PROJECT WILL BE ACCOMPLISHED. AS SHOWN PRIOR TO PROCEEDING WITH CONSTRUCTION ANY ERRORS OMISSIONS OR DISCREPANCIES SHALL BE BROUGHT TO THE ATTENTION OF THE ARCHITECT/ENGINEER VERBALLY AND IN WRITING.
- 4. THE GENERAL CONTRACTOR SHALL RECEIVE WRITTEN AUTHORIZATION TO PROCEED WITH CONSTRUCTION PRIOR TO STARTING WORK ON ANY ITEM NOT CLEARLY DEFINED BY THE CONSTRUCTION DRAWINGS/CONTRACT DOCUMENTS
- 5. THE CONTRACTOR SHALL SUPERVISE AND DIRECT THE PROJECT DESCRIBED IN THE CONTRACT DOCUMENTS. THE CONTRACTOR SHALL BE SOLELY RESPONSIBLE FOR ALL CONSTRUCTION MEANS, METHODS, TECHNIQUES, SEQUENCES, SAFETY, AND PROCEDURES FOR COORDINATING ALL PORTIONS OF THE WORK UNDER THE CONTRACT.
- 6. THE CONTRACTOR SHALL INSTALL ALL EQUIPMENT AND MATERIALS ACCORDING TO MANUFACTURER'S/VENDOR'S SPECIFICATIONS UNLESS NOTED OTHERWISE OR WHERE LOCAL CODES OR ORDINANCES TAKE PRECEDENCE.
- 7. ALL WORK PERFORMED ON THE PROJECT AND MATERIALS INSTALLED SHALL BE IN STRICT ACCORDANCE WITH ALL APPLICABLE CODES, REGULATIONS, AND ORDINANCES. CONTRACTOR SHALL GIVE ALL NOTICES AND COMPLY WITH ALL LAWS, ORDINANCES, RULES, REGULATIONS AND LAWFUL ORDERS OF ANY PUBLIC AUTHORITY, MUNICIPAL AND UTILITY, COMPANY SPECIFICATIONS, AND LOCAL AND STATE JURISDICTIONAL CODES BEARING ON THE PERFORMANCE OF THE WORK
- 8. GENERAL CONTRACTOR SHALL PROVIDE, AT THE PROJECT SITE, A FULL SET OF CONSTRUCTION DOCUMENTS UPDATED WITH THE LATEST REVISIONS INVOLVED WITH THE PROJECT. THIS SET IS A VALID CONTRACT DOCUMENT ONLY IF THE TITLE SHEET IS STAMPED IN RED INK "FOR CONSTRUCTION" AND EACH SUCCESSIVE SHEET BEARS THE ARCHITECT'S/ENGINEER'S SIGNED WET STAMP
- 9. THE CONTRACTOR IS RESPONSIBLE FOR ADEQUATELY BRACING AND PROTECTING ALL WORK DURING CONSTRUCTION AGAINST DAMAGE, BREAKAGE, COLLAPSE, ETC. ACCORDING TO APPLICABLE CODES, STANDARDS, AND GOOD CONSTRUCTION PRACTICES
- 10. THE CONTRACTOR SHALL MEET ALL OSHA REQUIREMENTS FOR ALL INSTALLATIONS.
- 11. THE CONTRACTOR SHALL BE RESPONSIBLE FOR ALL DAMAGES TO THE EXISTING CONSTRUCTION AND REPAIR ALL DAMAGES TO BETTER THAN NEW CONSTRUCTION. THE CONTRACTOR SHALL NOTIFY THE CONSULTANT OF ANY DAMAGE TO THE BUILDING SITE OR ANY ADJACENT STRUCTURES AROUND THE PROJECT. THE T-MOBILE REPRESENTATIVE SHALL BE SOLE AND FINAL JUDGE AS TO THE QUALITY OF THE REPAIRED CONSTRUCTION. ANY ADDITIONAL MODIFICATIONS WHICH MUST BE MADE SHALL BE MADE AT THE CONTRACTOR'S EXPENSE
- 12. WHERE NEW PAVING, CONCRETE SIDEWALKS OR PATHS MEET EXISTING CONSTRUCTION, THE CONTRACTOR SHALL MATCH THE EXISTING PITCH, GRADE, AND ELEVATION SO THE ENTIRE STRUCTURE SHALL HAVE A SMOOTH TRANSITION.
- 13. THE CONTRACTOR SHALL MODIFY THE EXISTING FLOORS, WALL, CEILING, OR OTHER CONSTRUCTION AS REQUIRED TO GAIN ACCESS TO AREAS FOR ALL MECHANICAL, PLUMBING, ELECTRICAL, OR STRUCTURAL MODIFICATIONS. WHERE THE EXISTING CONSTRUCTION DOORS. PARTITIONS, CEILING, ETC., ARE TO BE REMOVED, MODIFIED, OR REARRANGED OR WHERE THE EXPOSED OR HIDDEN MECHANICAL, ELECTRICAL, SYSTEMS ARE ADDED OR MODIFIED, THE GENERAL CONTRACTOR SHALL REPAIR, PATCH AND MATCH ALL EXISTING CONSTRUCTION AND FINISHES OF ALL FLOORS WALLS AND CEILINGS. WHERE CONCRETE MASONRY CONSTRUCTION IS MODIFIED, THE CONTRACTOR SHALL TOOTH IN ALL NEW CONSTRUCTION TO MATCH THE EXISTING BOND. WHERE CONCRETE CONSTRUCTION IS MODIFIED, THE CONTRACTOR SHALL VERIFY THE EXACT DETAILS TO BE USED FOR CONSTRUCTION. ALL WORK SHALL BE COVERED UNDER THE GENERAL CONTRACT
- 14. IF CONTRACTOR OR SUBCONTRACTOR FIND IT NECESSARY TO DEVIATE FROM ORIGINAL APPROVED PLANS. THEN IT IS THE CONTRACTOR'S AND THE SUBCONTRACTOR'S RESPONSIBILITY TO PROVIDE THE CONSULTANT WITH 4 COPIES OF THE PROPOSED CHANGES FOR HIS APPROVAL BEFORE PROCEEDING WITH THE WORK. IN ADDITION THE CONTRACTOR AND SUBCONTRACTORS SHALL BE RESPONSIBLE FOR PROCURING ALL NECESSARY APPROVALS FROM THE BUILDING AUTHORITIES FOR THE PROPOSED CHANGES BEFORE PROCEEDING WITH THE WORK. THE CONTRACTOR AND SUBCONTRACTORS SHALL BE RESPONSIBLE FOR PROCURING ALL NECESSARY INSPECTIONS AND APPROVALS FROM BUILDING AUTHORITIES DURING THE EXECUTION OF THE WORK.
- 15. CONTRACTOR TO PROVIDE A PORTABLE FIRE EXTINGUISHER WITH A RATING OF NOT LESS THAN 2-A OR 2-A10BC WITHIN 75 FEET TRAVEL DISTANCE TO ALL PORTIONS OF PROJECT AREA DURING
- 16. THE CONTRACTOR SHALL PERFORM WORK DURING OWNER'S PREFERRED HOURS TO AVOID DISTURBING NORMAL BUSINESS
- 17. SEAL ALL PENETRATIONS THROUGH FIRE-RATED AREAS WITH U.L. LISTED OR FIRE MARSHAL APPROVED MATERIALS AS APPLICABLE TO THIS FACILITY AND OR PROJECT SITE.
- 18. CONTRACTOR SHALL BE RESPONSIBLE FOR UTILITY LOCATES, SCHEDULING, COORDINATING SPECIAL AND BUILDING DEPARTMENT INSPECTIONS
- 19. CONTRACTOR SHALL BE RESPONSIBLE FOR CONTACTING AND UTILIZING ORIGINAL ROOFING CONTRACTOR AS REQUIRED TO MAINTAIN ANY EXISTING ROOFING WARRANTY.
- 20. ROUTING OF ALL CONDUITS, CABLES, CABLE TRAYS ETC ARE INDICATED AS PROPOSED LOCATION ONLY. CONFIRM THE EXACT LOCATION AND ROUTING WITH THE ON SITE T-MOBILE CONSTRUCTION MANAGER PRIOR TO STARTING WORK

ABBREVIATIONS

	AC AFF AFG AFS ALUM	AIR CONDITIONER ABOVE FINISHED FLOOR ABOVE FINISHED GRADE ABOVE FINISHED SLAB ALUMINUM ANCHOR BOLT	JT LAM LF MANUF MAX MECH	JOINT LAMINATED LINEAL FOOT MANUFACTURER MAXIMUM MECHANICAL
	ARCH BTS BLDG BM BOT B.O. BOC BOS	ANGLE ARCHITECTURAL BASE TRANSMISSION SYSTEM BUILDING BEAM BOTTOM BOTTOM OF BOTTOM OF CONCRETE BOTTOM OF STEEL CONTROL JOINT CENTER LINE CELLING	MH MM MIN MISC MPH MTL NIC NOM NTS	MANHOLE MILLIMETER MINIMUM MISCELLANEOUS MILES PER HOUR METAL NOT IN CONTRACT NOMINAL NOT TO SCALE ON CENTER
	CMU COL CONC CONST CONT	CONCRETE MASONRY UNIT COLUMN CONCRETE CONSTRUCTION CONTINUOUS	OC OD OH OPNG OPP (P) PCS PR PSI	OUTSIDE DIAMETER OVERHEAD OPENING OPPOSITE PROPOSED PERSONAL COMMUNICATION SYSTEM PLATE PAIR
	CTR DIA / Ø DTL EA ELEC	CENTER DIAMETER DETAIL EXISTING EACH EXPANSION JOINT ELECTRIC/ELECTRICAL ELEVATION	PSI PSF PT RAD RD REINF REQ'D RM	POUNDS PER SQUARE INCH POUNDS PER SQUARE FOOT PRESSURE TREATED RADIUS ROOF DRAIN REINFORCED/REINFORCING REQUIRED ROOM
,	EQ EW EXP EXT	EQUAL EACH WAY EXPANSION EXTERIOR FLOOR DRAIN FINISH FINISH FINISH FLOOR	R/W SCHED SECT SF SIM SQ FT	RIGHT OF WAY SCHEDULE SECTION SQUARE FOOT SIMILAR SQUARE FOOT STAINLESS STEEL
	FINFLR FLR FTG GALV GALV GB HM HOR HR	FLOOR FOOTING GAUGE GALVANIZED GYPSUM GYPSUM BOARD HOLLOW METAL HORIZONTAL	STD STL STRUC TEMP THK T.O. TOS TOC	STANDARD STEEL STRUCTURAL TEMPORARY THICK TOP OF TOP OF STEEL TOP OF CONCRETE
	HVAC INSUL INT	HOUR HEIGHT HEATING VENTILATION AIR CONDITIONING INSULATION INTERIOR	TYP UNO VCT VERT W/ WWM	TYPICAL UNLESS NOTED OTHERWISE VINYL COMPOSITION TILE VERTICAL WITH WELDED WIRE MESH

LEGENDS & SYMBOLS

CHAIN LINK FENCE

EDAR FENCE	
OWER	- P — P — P — P — P — P — P
ELCO	$ _{\rm T}$
OWER/TELCO	- P — T — P — T — P — T — P — T
OAX	- COAX — COAX — COAX — COAX
VERHEAD POWER	—ОН——ОН——ОН——ОН——ОН——
ENTERLINE	
EVISION BUG	1
	DETAIL NUMBER
LEVATION VIEW BUG	
LEVATION VIEW BOG	
	SHEET NUMBER
LEVATION VIEW BUG	TOP OF XXXXX
LLVATION VIEW BOG	XXX'-X" AGL
ETAIL BUG	DETAIL NUMBER
	SHEET NUMBER
	DETAIL NUMBER
=0=1011 B110	
ECTION BUG	
	SHEET NUMBER

SPECIAL INSPECTIONS:

SPECIAL INSPECTIONS IN ACCORDANCE WITH IBC 2018 SECTION 1704.

SOILS/GEOTECHNICAL:

- ☐ SHORING INSTALLATION AND MONITORING
- ☐ OBSERVE AND MONITOR EXCAVATION
- □ VERIFY SOIL BEARING psf BEARING
- ☐ SUBSURFACE DRAINAGE PLACEMENT
- □ VERIFY FILL MATERIAL AND COMPACTION
- □ VERIFY CONDITIONS AS ANTICIPATED ☐ PILE PLACEMENT (AUGER CAST/DRIVEN PILE)
- □ OTHER

REINFORCED CONCRETE:

- ☐ REINFORCING STEEL AND CONCRETE PLACEMENT
- □ PRESTRESSED/PRECAST CONCRETE FABRICATION AND ERECTION
- ☐ BATCH PLANT INSPECTION
- □ SHOTCRETE
- □ GROUTING
- □ OTHER

STRUCTURAL STEEL:

- ☐ FABRICATION AND SHOP WELDS
- ☐ ERECTION AND FIELD WELDS AND BOLTING
- □ OTHER:

STRUCTURAL ALUMINUM:

- ☐ FABRICATION AND SHOP WELDS
- ☐ ERECTION AND FIELD WELDS AND BOLTING
- □ OTHER:

STRUCTURAL MASONRY:

- □ PERIODIC
- □ OTHER:

MISCELLANEOUS

□ OTHER

ANCHORING TO CONCRETE:

- ☐ BOLTS INSTALLED IN CONCRETE
- ☐ POST-INSTALLATION ADHESIVE ANCHORS
- ☐ POST-INSTALLATION MECHANICAL ANCHORS

=PROJECT INFORMATION:=

OLYMPIA LACEY AMTRAK/PSE/LP HOA SE05317B

59TH LP SE & STOCKTON ST SE LACEY, WA 98513

SSUFD FOR:=

BUILDING PERMIT

REVISION HISTORI.			CH
NO.	DATE:	DESCRIPTION:	В

BJT

=PLANS PREPARED BY:=

12/6/2022

12/7/2022 MINOR REV

B. J. THOMAS, P.E. **7607 80TH AVE NE MARYSVILLE, WA 98270** 206-851-1106

REVISED PER REDI INES

RAWN	RV:	СНК.	R
DATE	D	——Unik.	•

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=LICENSURE:=



=DRAWING INFORMATION:=

DO NOT SCALE DRAWINGS. CONTRACTOR MUST VERIEY ALL DIMENSIONS AND ADVISE CONSULTANTS OF ANY ARE DIMENSIONS AND ADVISE CONSULTANTS OF ANY ERRORS AND OMISSIONS. ALL PREVIOUS ISSUES OF THIS DRAWING ARE SUPERSEDED BY THE LATEST REVISION. THE INFORMATION CONTAINED IN THIS SET OF DOCUMENTS IS PROPRIETARY BY NATURE. ANY USE OR DISCLOSURE OTHER THAN WHICH IS RELATED TO NAMED CLIENT IS STRICTLY PROHIBITED.

DRAWING TITLE:

GENERAL NOTES

=DRAWING NUMBER:=====


CALL TWO WORKING DAYS BEFORE YOU DIG WITH CURRENT OSHA STANDARDS

SAFETY PRECAUTION SHALL
BE IMPLEMENTED BY
CONTRACTOR(S) AT ALL
FRENCHING IN ACCORDANCE

NATIONAL UTILITIES UNDERGROUND LOCATE ELECTRIC - RED SEWER - GREEN GAS/OIL - YELLOW SURVEY - PINK

TEL/CATV - ORANGE PROPOSED - WHITE WATER - BLUE

811

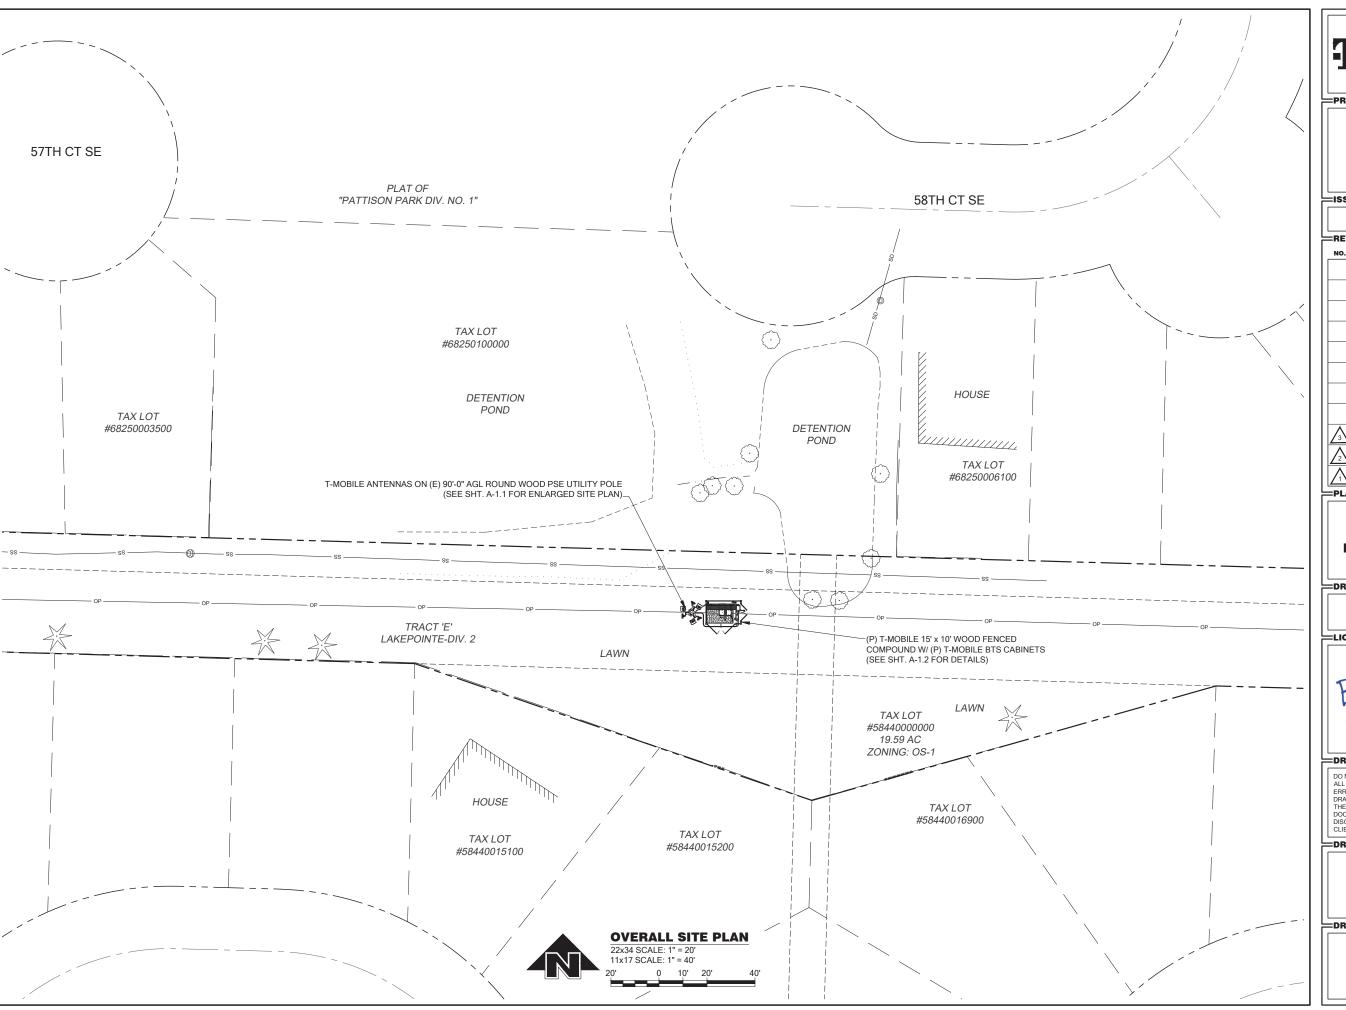

PROJECT INFORMATION:

OLYMPIA LACEY AMTRAK/PSE/LP HOA SE05317B

59TH LP SE & STOCKTON ST SE LACEY, WA 98513

SSUED FOR:=

BUILDING PERMIT

REVISION HISTORY:

NO. DATE: DESCRIPTION:

$\sqrt{3}$	12/7/2022	MINOR REV	BJT
2	12/6/2022	REVISED PER REDLINES	BJT
$\overline{\Lambda}$	11/15/2022	ISSUED DESIGN REVIEW	BJT

PLANS PREPARED BY:

B. J. THOMAS, P.E. 7607 80TH AVE NE MARYSVILLE, WA 98270 206-851-1106

DRAWN BY: CHK. BY:

BJ

LICENSURE:



DRAWING INFORMATION:


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DRAWING TITLE:

OVERALL SITE PLAN

DRAWING NUMBER:

A-1



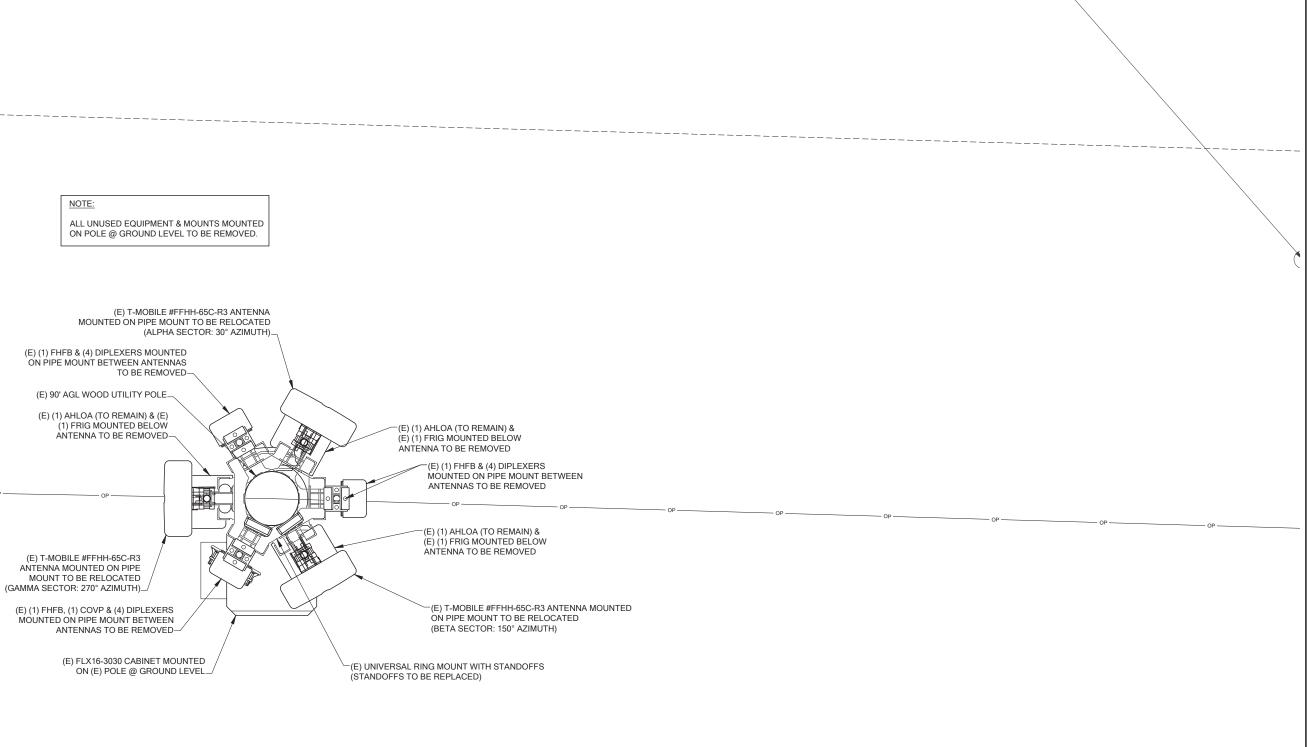

PROJECT INFORMATION:

OLYMPIA LACEY AMTRAK/PSE/LP HOA SE05317B

59TH LP SE & STOCKTON ST SE LACEY, WA 98513

ISSUED FOR:=

BUILDING PERMIT

=REVISION HISTORY:=====						
NO.	. DATE: DESCRIPTION:					
			+			
Λ	12/7/2022	MINOR REV	BJT			
<u>/3\</u>	12///2022	MINOR REV	BJI			
$\sqrt{2}$	12/6/2022	REVISED PER REDLINES	BJT			
/_			-			
Λ	11/15/2022	ISSUED DESIGN REVIEW	BJT			

PLANS PREPARED BY:

B. J. THOMAS, P.E. 7607 80TH AVE NE MARYSVILLE, WA 98270 206-851-1106

JL BJ

LICENSURE:



DRAWING INFORMATION:


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DRAWING TITLE:

EXISTING ENLARGED SITE PLAN

DRAWING NUMBER:

A-1.1

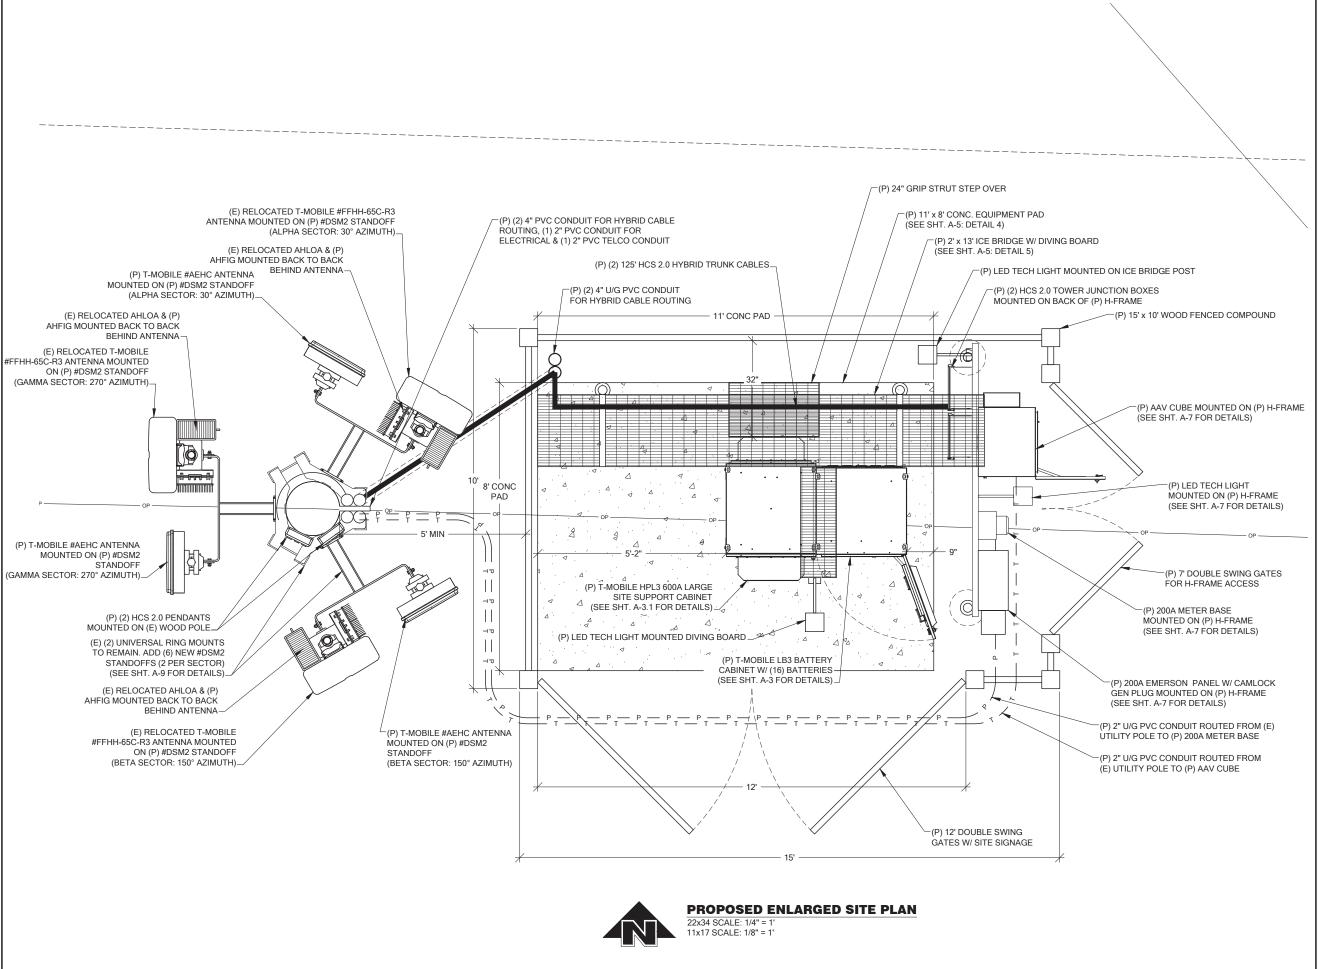

PROJECT INFORMATION:

OLYMPIA LACEY AMTRAK/PSE/LP HOA SE05317B

59TH LP SE & STOCKTON ST SE LACEY, WA 98513

=ISSUED FOR:=

BUILDING PERMIT

NO.	DATE:	DATE: DESCRIPTION:			
110.	DATE.	DESCRIPTION.	BY:		
$\sqrt{3}$	12/7/2022	MINOR REV	BJT		
2	12/6/2022	REVISED PER REDLINES	BJT		
Λ	11/15/2022	ISSUED DESIGN REVIEW	BJT		

PLANS PREPARED BY:

B. J. THOMAS, P.E. **7607 80TH AVE NE MARYSVILLE, WA 98270** 206-851-1106

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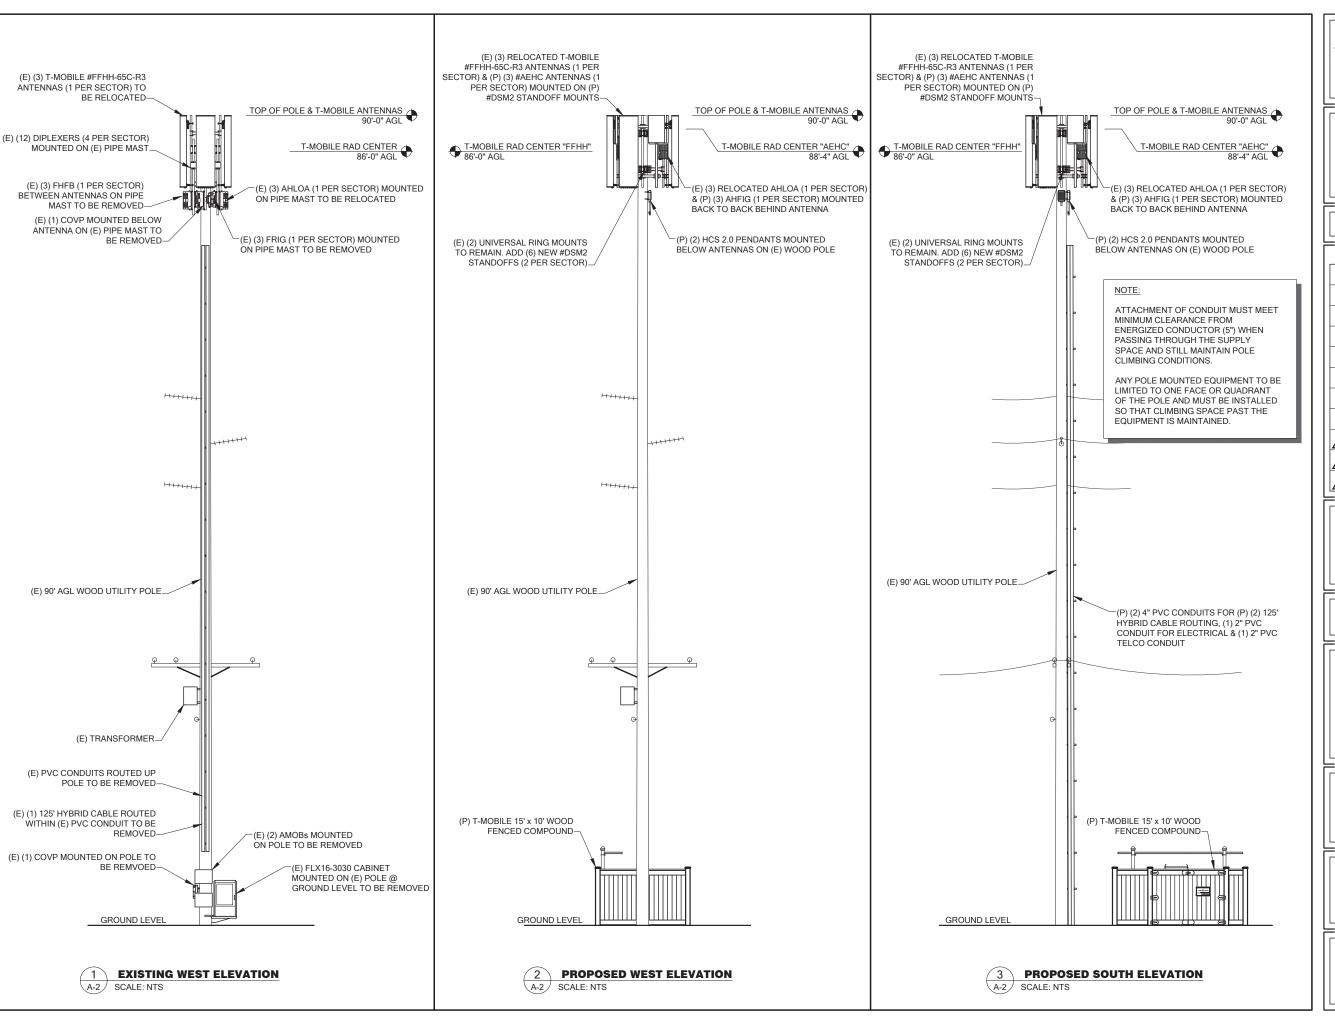


=DRAWING INFORMATION:=

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DRAWING TITLE:

PROPOSED ENLARGED SITE PLAN



PROJECT INFORMATION:

OLYMPIA LACEY AMTRAK/PSE/LP HOA SE05317B

59TH LP SE & STOCKTON ST SE LACEY, WA 98513

=ISSUED FOR:=

BUILDING PERMIT

REVISION HISTORY:

NO. DATE: DESCRIPTION:

	$\sqrt{3}$	12/7/2022	MINOR REV	BJT
	2	12/6/2022	REVISED PER REDLINES	BJT
	Λ	11/15/2022	ISSUED DESIGN REVIEW	BJT
느	=PLA	NS PREP	ARED BY:	

B. J. THOMAS, P.E. 7607 80TH AVE NE MARYSVILLE, WA 98270 206-851-1106

DRAWN BY: CHK. BY:

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DRAWING TITLE:

SITE ELEVATION

DRAWING NUMBER:


A-2

"FINAL" SITE LOADING CHART


SECTOR	COLOR	POSITION	ANTENNA MODEL #	VENDOR	AZIMUTH (TN)	RADIATION CENTER	HYBRID CABLE LENGTH	COAX CABLES	ADDITIONAL EQUIPMENT
ALPHA	RED	1 2	FFHH-65C-R3 AEHC	COMMSCOPE NOKIA	30°	86'-0" AGL 88'-4" AGL			(1) AHLOA (1) AHFIG
BETA	GREEN	1 2	FFHH-65C-R3 AEHC	COMMSCOPE NOKIA	150°	86'-0" AGL 88'-4" AGL	(2) 125' HCS 2.0 HYBRID TRUNK CABLES	N/A	(1) AHLOA (1) AHFIG
GAMMA	BLUE	1 2	FFHH-65C-R3 AEHC	COMMSCOPE NOKIA	270°	86'-0" AGL 88'-4" AGL			(1) AHLOA (1) AHFIG

	RFDS
PROJECT TYPE	ANCHOR
RFDS VERSION	3 - 7/26/2022



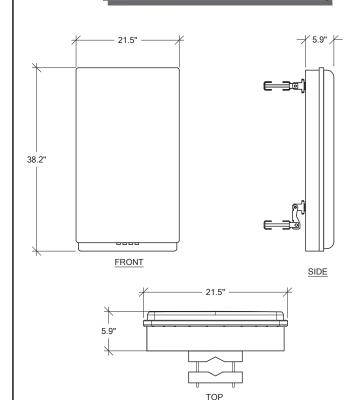

1	AEHC DETAIL
RF-1	SCALE: NTS

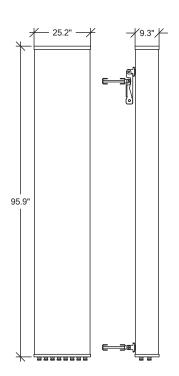

COMMSCOPE ANTENNA DATA								
MECHANICAL SPECIFICATIONS								
PART NUMBER HEIGHT WIDTH DEPTH WEIGHT								
FFHH-65C-R3		95.9 in		25.2 in	9.3 ir	า	127	7.6 lbs
CONNECTORS	CONNECTORS STANDARD MOUNTING HARDWARE							
(8) 7-16 DIN	(8) 7-16 DIN INCLUDED							
ELECTRICAL S	PECI	FICATION	NS					
FREQUENCY	POLA	RIZATION	GAII	N	AZIMU [*]	ТН В	.W.	
617-2360 MHz ±45° 15.8-19.6 dBi 55°- 67°								
	VSWI	R MAX I	NPUT	ΓPOWER	ELEVA'	TION	I B.W	<i>1</i> .
<1.5:1 300 WATTS 4.4° - 10.2°								

2 FFHH-65C-R3 DETAIL
RF-1 SCALE: NTS

T - - Mobile-

PROJECT INFORMATION:

OLYMPIA LACEY AMTRAK/PSE/LP HOA SE05317B

59TH LP SE & STOCKTON ST SE LACEY, WA 98513

ISSUED FOR:

BUILDING PERMIT

REVISION HISTORY:

NO. DATE: DESCRIPTION: BY:

PLANS PREPARED BY:

B. J. THOMAS, P.E. 7607 80TH AVE NE MARYSVILLE, WA 98270 206-851-1106

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12/6/2022 REVISED PER REDLINES

11/15/2022 ISSUED DESIGN REVIEW

JL BJ

LICENSURE:



DRAWING INFORMATION:


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DRAWING TITLE:

RF DETAILS

DRAWING NUMBER:

RF-1

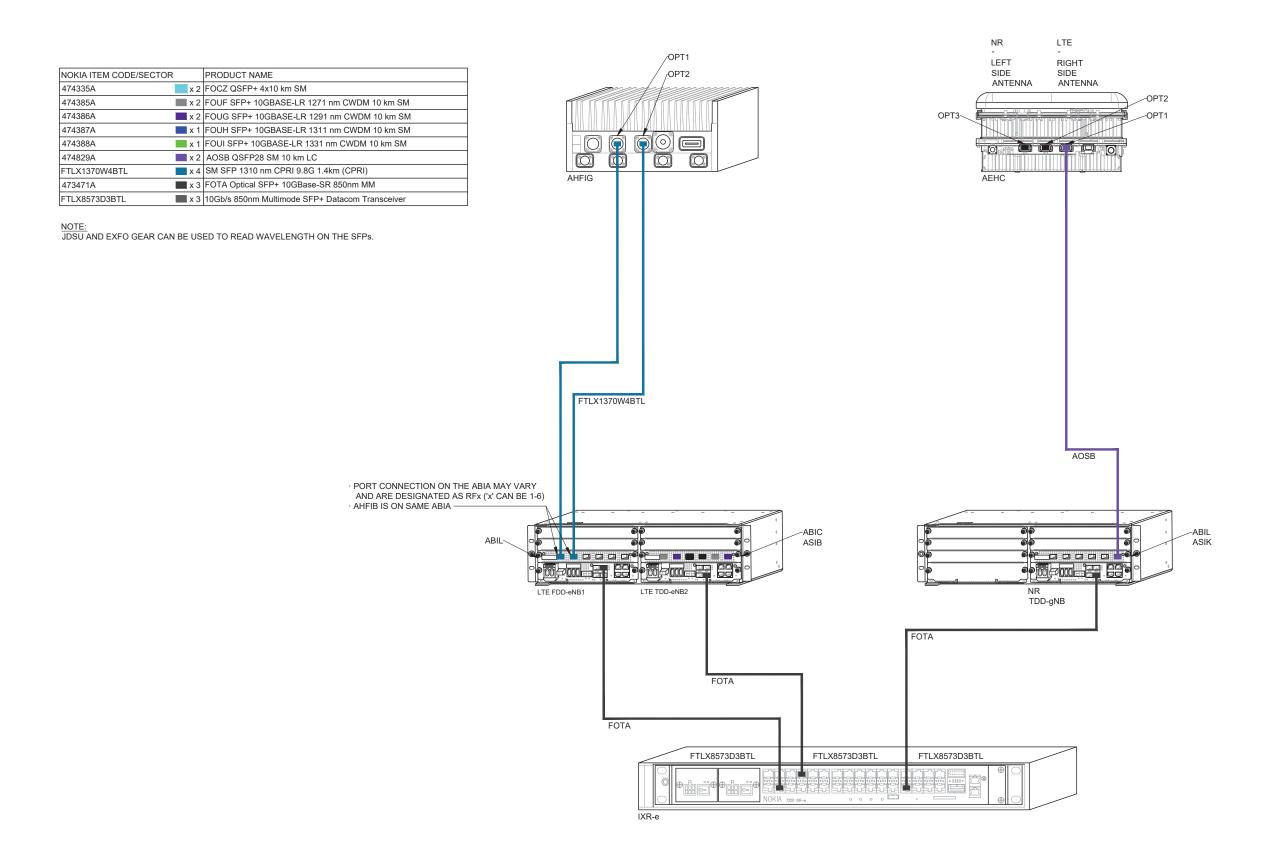

PROJECT INFORMATION:

OLYMPIA LACEY AMTRAK/PSE/LP HOA SE05317B

59TH LP SE & STOCKTON ST SE LACEY, WA 98513

ISSUED FOR:=

BUILDING PERMIT

CH				
NO.	DATE:	DESCRIPTION:	BY:	
$\sqrt{3}$	12/7/2022	MINOR REV	BJT	
2	12/6/2022	REVISED PER REDLINES	BJT	
Λ	11/15/2022	ISSUED DESIGN REVIEW	BJT	

PLANS PREPARED BY:

B. J. THOMAS, P.E. **7607 80TH AVE NE MARYSVILLE, WA 98270** 206-851-1106

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BJ

LICENSURE:




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DRAWING TITLE:

SFP DETAILS



PROJECT INFORMATION:=

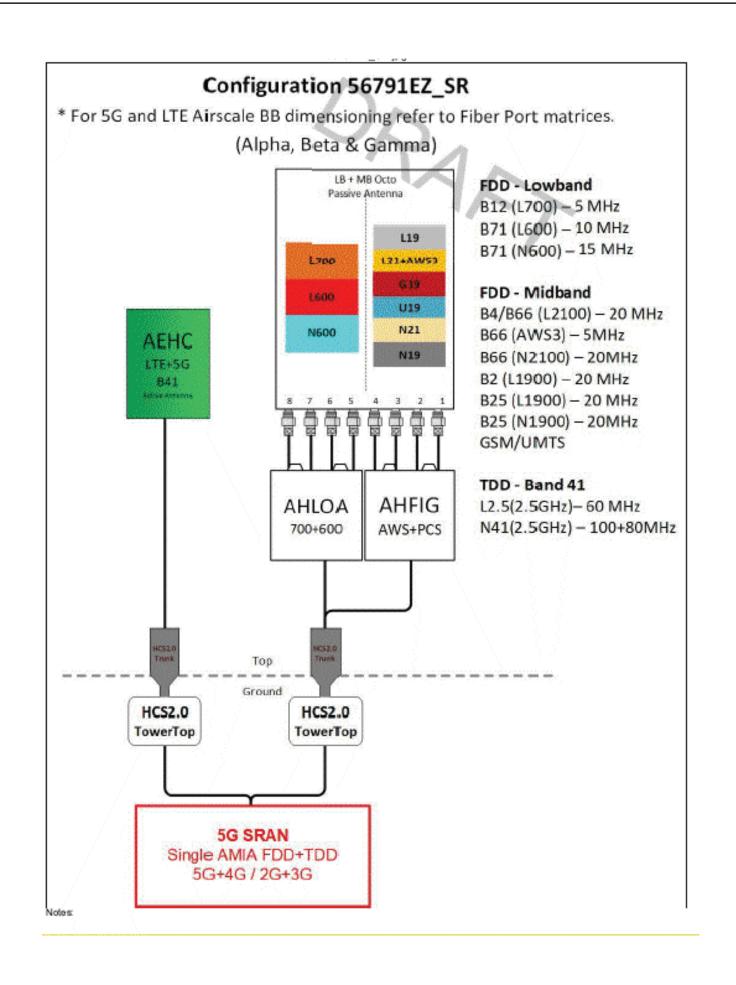OLYMPIA LACEY AMTRAK/PSE/LP HOA SE05317B

59TH LP SE & STOCKTON ST SE LACEY, WA 98513

ISSUED FOR:=

BUILDING PERMIT

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=REVISION HISTORY:					
NO.	DATE:	DESCRIPTION:	BY:		
Δ	12/7/2022	MINOR REV	BJT		

PLANS PREPARED BY:=

B. J. THOMAS, P.E. 7607 80TH AVE NE MARYSVILLE, WA 98270 206-851-1106

REVISED PER REDLINES

DRAWN BY: CHK. BY:

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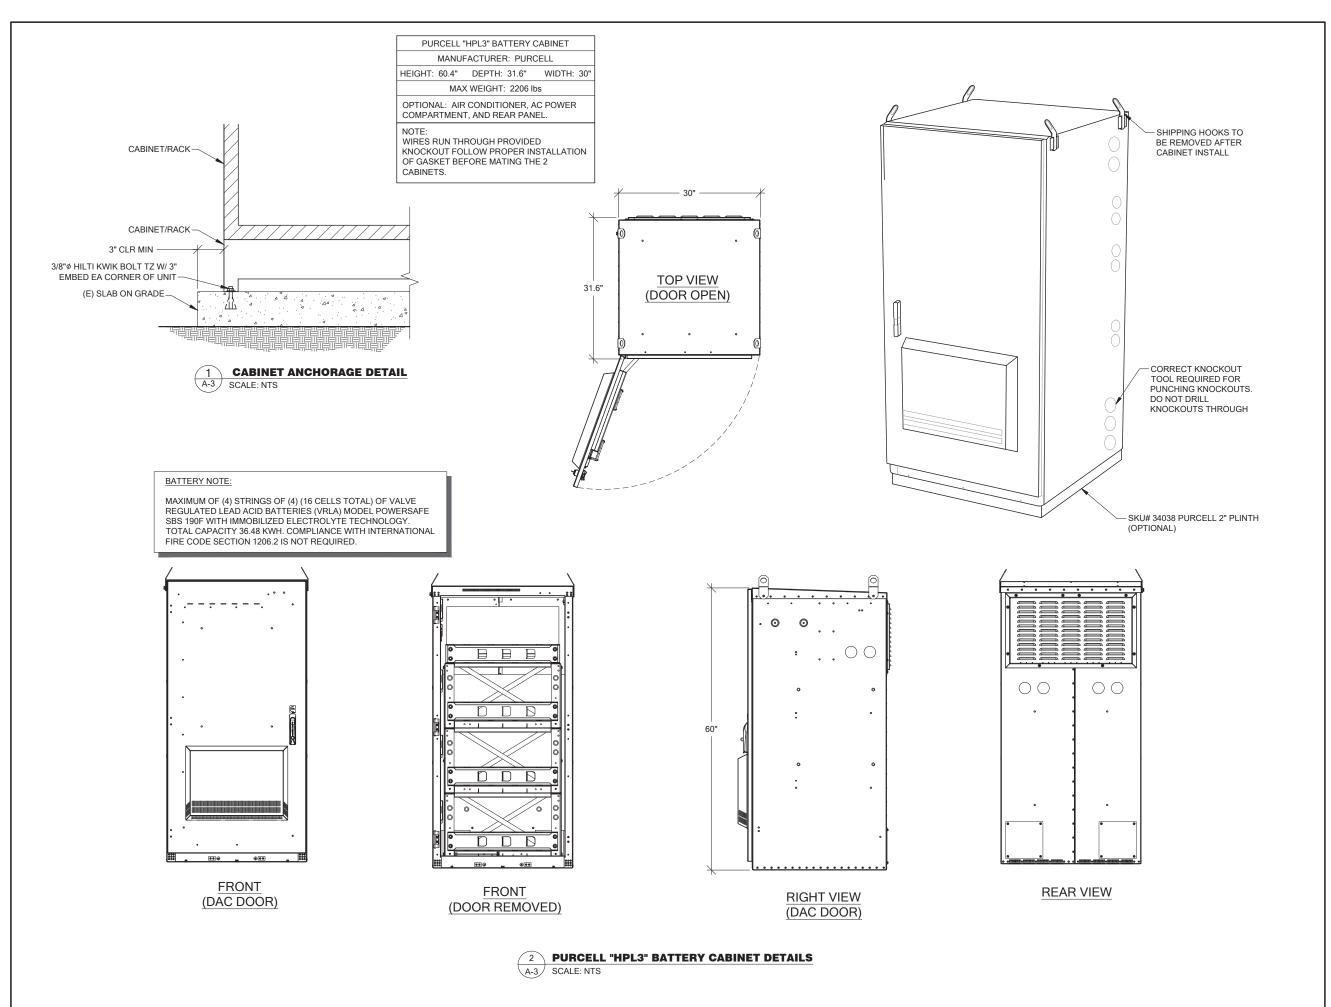
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DRAWING TITLE:

RF DETAILS

DRAWING NUMBER:

RF-2



PROJECT INFORMATION:

OLYMPIA LACEY AMTRAK/PSE/LP HOA SE05317B

59TH LP SE & STOCKTON ST SE LACEY, WA 98513

ISSUED FOR:=

BUILDING PERMIT

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NO.	DATE:	DESCRIPTION:	BY:	
Λ	12/7/2022	MINOR REV	BJT	
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$ \Lambda $	12/6/2022	REVISED PER REDLINES	BJT	
			_	
I_{1}	11/15/2022	ISSUED DESIGN REVIEW	BJT	

PLANS PREPARED BY:

B. J. THOMAS, P.E. 7607 80TH AVE NE MARYSVILLE, WA 98270 206-851-1106

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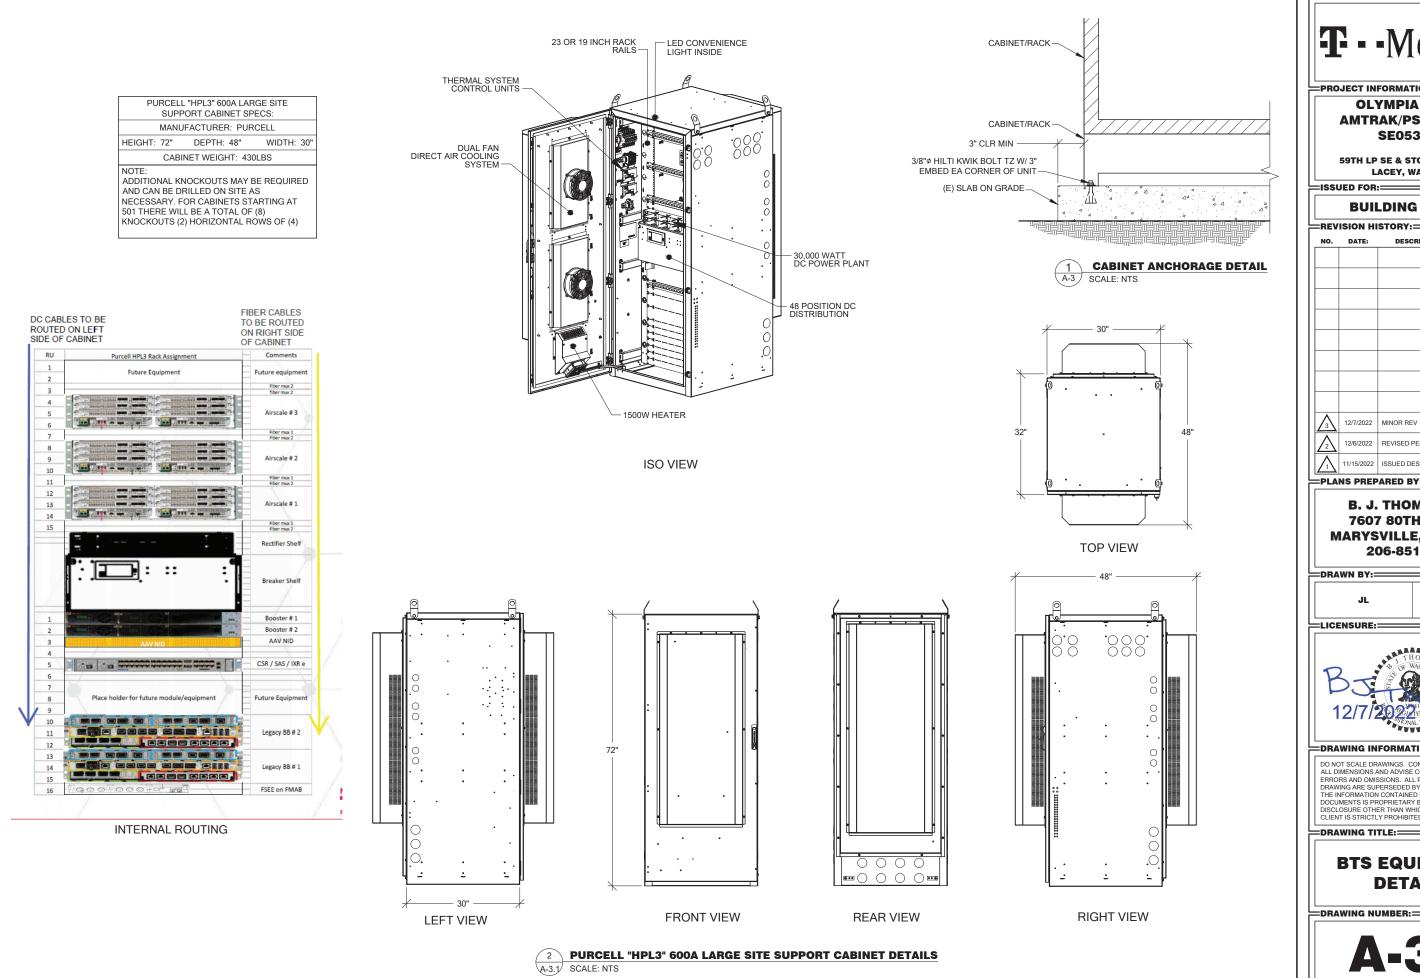
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DRAWING TITLE:

BTS EQUIPMENT DETAILS

DRAWING NUMBER:

A-3



PROJECT INFORMATION:

OLYMPIA LACEY AMTRAK/PSE/LP HOA SE05317B

59TH LP SE & STOCKTON ST SE LACEY, WA 98513

=ISSUED FOR:=

BUILDING PERMIT

NO.	D. DATE: DESCRIPTION:		CHK. BY:
$\sqrt{3}$	12/7/2022	MINOR REV	BJT
2	12/6/2022	REVISED PER REDLINES	BJT
Λ	11/15/2022	ISSUED DESIGN REVIEW	BJT

PLANS PREPARED BY:

B. J. THOMAS, P.E. **7607 80TH AVE NE** MARYSVILLE, WA 98270 206-851-1106

BJ

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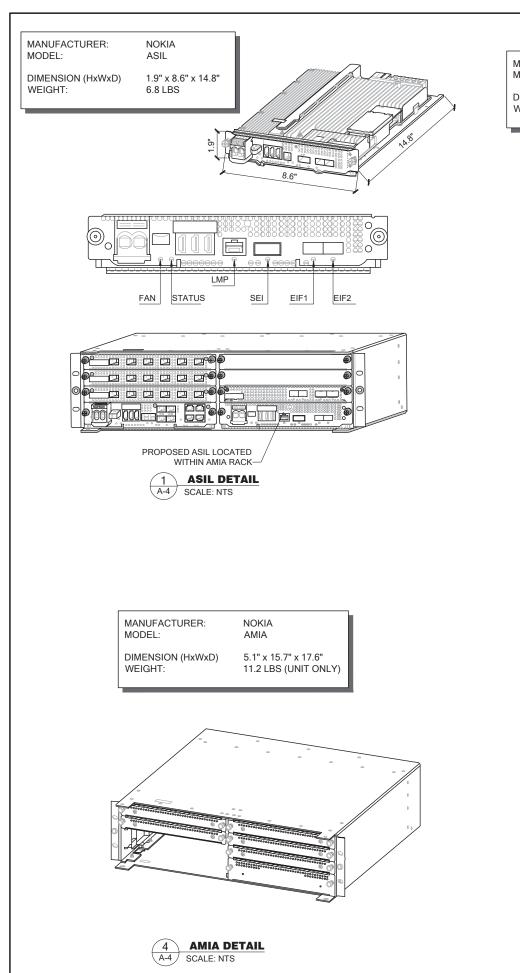



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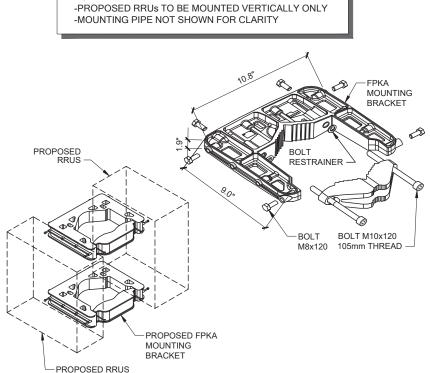
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DRAWING TITLE:

BTS EQUIPMENT DETAILS






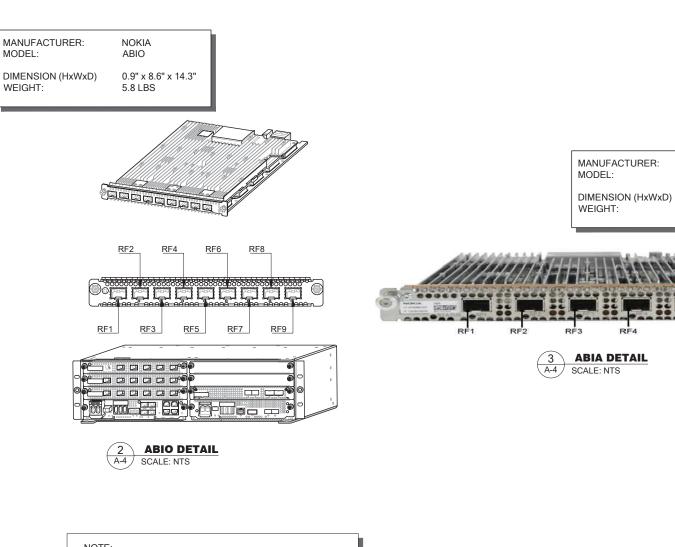

FPKA DETAIL

SCALE: NTS

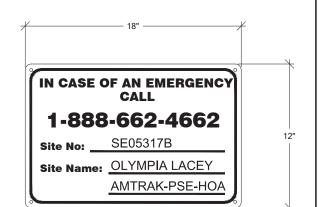

SITE SIGNAGE DETAIL SCALE: NTS

T - - Mobile-

PROJECT INFORMATION:

OLYMPIA LACEY AMTRAK/PSE/LP HOA SE05317B

59TH LP SE & STOCKTON ST SE LACEY, WA 98513

ISSUED FOR:=

NOKIA

4.63 LBS

ABIA AIR SCALE

1.9" x 8.3" x 14.8"

BUILDING PERMIT

REVISION HISTORY: DATE: 12/7/2022 MINOR REV REVISED PER REDLINES 12/6/2022

PLANS PREPARED BY:

B. J. THOMAS, P.E. **7607 80TH AVE NE MARYSVILLE, WA 98270** 206-851-1106

DRAWN BY: CHK. BY:

BJ

LICENSURE:





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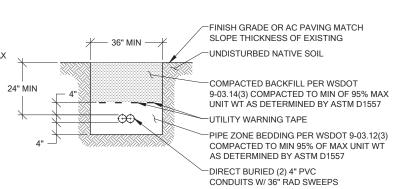
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DRAWING TITLE:

GENERAL DETAILS





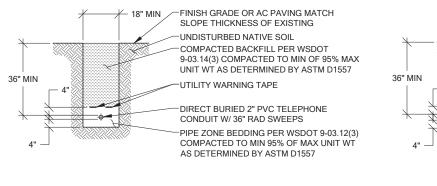

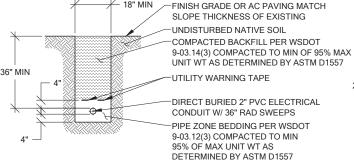HYBRID CABLE TRENCH
SCALE: NTS


TELCO SERVICE TRENCH
SCALE: NTS






ANCHOR DETAIL- 1/2" DIAMETER ANCHOR BOLTS IF CAST IN PLACE WITH 6" DEPTH OR 5/8" DIAMETER HILTI KWIK HUS-EZ BOLTS IF POST-INSTALLED WITH 6" DEPTH.

PLATE DETAIL- CARRIER CAN ALTERNATELY INSTALL A PRE-MANUFACTURED KIT FROM SITE PRO, SUCH AS THEIR PRODUCT "IB24D" OR IB24B".

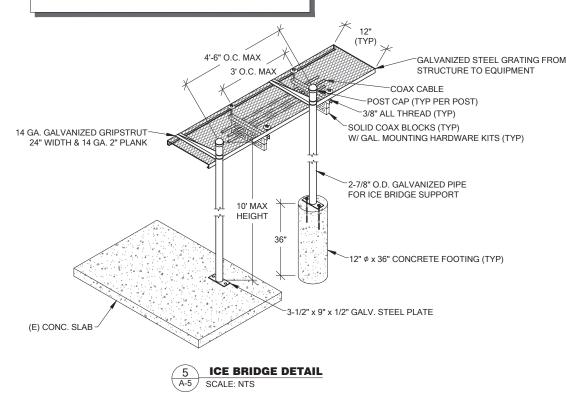

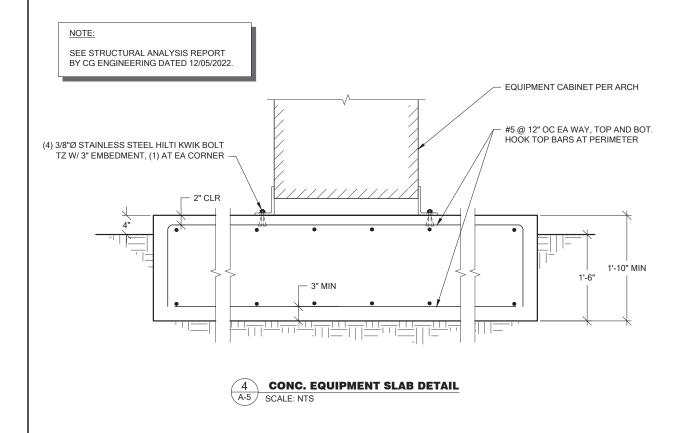

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PROJECT INFORMATION:

OLYMPIA LACEY AMTRAK/PSE/LP HOA SE05317B

59TH LP SE & STOCKTON ST SE LACEY, WA 98513

LISSUED FOR:=

EREVISION HISTORY:

BUILDING PERMIT

12/7/2022	MINOR REV	BJT
12/6/2022	REVISED PER REDLINES	BJT
11/15/2022	ISSUED DESIGN REVIEW	ВЈТ
	12/6/2022	12/6/2022 REVISED PER REDLINES

B. J. THOMAS, P.E. 7607 80TH AVE NE MARYSVILLE, WA 98270 206-851-1106

BJ

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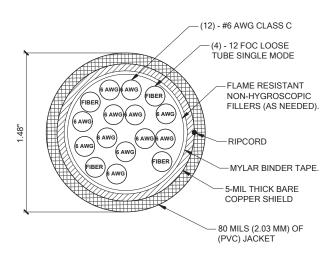
DRAWING TITLE:

GENERAL DETAILS

DRAWING NUMBER:


A-5

HYE	RID CABLE	Ξ
STRUCTURE	# OF CABLES	LENGTH
UTILITY POLE	2	125'



HYBRID TRUNK CABLE DETAIL SCALE: NTS


MANUFACTURER: NOKIA AHFIG MODEL: 70.5 LBS WEIGHT DIMENSION (LxWxD) w/ COVER 28.74" x 12.87" x 5.59"

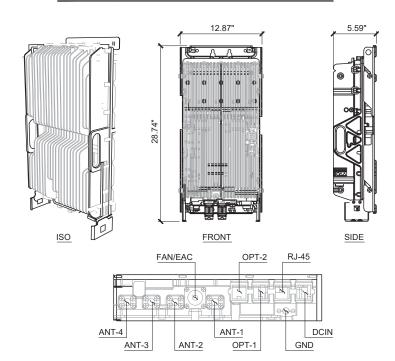

AHFIG DETAIL A-6 SCALE: NTS

MANUFACTURER: ALLIANCE CORPORATION MODEL: ACFB05-HICAP-FULLASY-CRS

DIMENSION (HxWxD) 9.3" x 14.86" x 5.79" WEIGHT: 8.76LBS MOUNTING KIT: PROVIDED

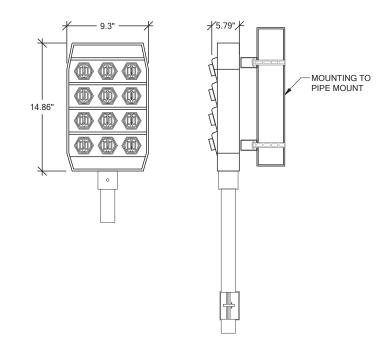

MANUFACTURER: COMMSCOPE MODEL: FE-16148-OVP-B12 16" x 14" x 8" DIMENSION (HxWxD) WEIGHT: 23.5lbs


FIBER & POWER JUNCTION BOX W/ OVP

OVP/JUNCTION BOX DETAIL SCALE: NTS

HCS 2.0 PENDANT DETAIL SCALE: NTS

General Specifications

Cable Type	HET410-4SNOK2-xx	HFT410-4SNOK3-xx (for FASB)
Brand	HELIAX® FiberFeed®	HELIAX® FiberFeed®
Total Fiber Quantity	4	4
Fiber Type	Bend insensitive single mode fiber (G.657.A2)	Bend insensitive single mode fiber (G.657.A2)
Jacket Color	Black	Black
Dimensions		
Cable Weight	456,1 kg/km 306.5 lb/kff	456.1 kg/km 306.5 lb/kft
Breakout Length Fiber, end 1	815 mm 32 in	1560 mm 61 in
Breakout Length Power, end 1	895 mm 35 in	457 mm 18 in
Breakout Length Fiber, end 2	600 mm 24 in	600 mm 24 in
Diameter Over Jacket	1831 mm 0.72 in	1831 mm 0.72 in
Physical Specifications		
Minimum Bend Radius, loaded	365.8 mm 14.4 in	365.8 mm 14.4 in
Minimum Bend Radius, unloaded	221.0 mm 8.7 in	221.0 mm 8.7 in
Tensile Load, long term, maximum	801 N 180 lbf	801 N 180 lbf
Tensile Load, short term, maximum	2669 N 600 lbf	2669 N 600 lbf

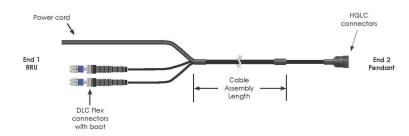

5 HCS 2.0 SCALE: NTS

HCS 2.0 HYBRID JUMPER DETAIL

HELIAX FiberFeed Hybrid Jumpers

FiberFeed hybrid jumpers are constructed specifically for the conditions of the last few feet to the RRUs.

- Smallest cable diameter for high flexibility
- Corrugated aluminum shield resists bird/animal damaç

Exact fit to Pendant and RRU

Features

Specifications

Hybrid Jumpers					
10 AWG power conductor 4 Single mode fibers	wire				
	wire 4	4	35	32	24

Hybrid Jumpers for Nokia Radios

Ordering Information

Hybrid Jumpers for Nokia Radios	6	HFT410-4SNOK2-6
End 1: 4 fibers terminated DIC for Nokia RRUs with flush out power cord (red/black conductors).	10	HFT410-4SNOK2-10
End 2: 4 fibers terminated LC and 4 X 10 AVVG	15	HFT410-4SNOK2-15
conductors terminated at hybrid trunk connector (HQtC)	20	HFT41 0-45NOK2-20
	25	HFT41 0-4SNOK2-25
	30	HFT41 0-4\$NOK2-30
	40	HFT41 0-4SN/OK2-40
	50	HFT410-4\$NOK2-50
	60	HFT41 0-4\$NOK2-60
	70	HFT410-4SNOK2-70
	80	HFT41 0-4SN/OK2-80
	90	HFT41 0-4SN/OK2-90
	100	HFT410-4\$NOK2-100

Note: Longer lengths are available; contact your CommScope sales representative for details



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PROJECT INFORMATION:

OLYMPIA LACEY AMTRAK/PSE/LP HOA SE05317B

59TH LP SE & STOCKTON ST SE LACEY, WA 98513

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$\overline{\Lambda}$	11/15/2022	ISSUED DESIGN REVIEW	BJT

PLANS PREPARED BY:

B. J. THOMAS, P.E. **7607 80TH AVE NE** MARYSVILLE, WA 98270 206-851-1106

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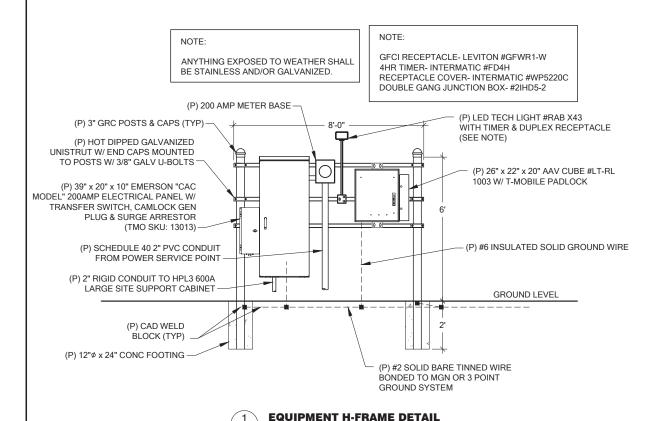
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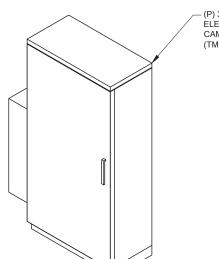
GENERAL DETAILS






SCALE: NTS

32.3" 32.3" 19.6" SIDE VIEW FRONT VIEW TOP VIEW AAV CUBE WEIGHT: 90LBS **AAV ROUTER "CUBE" DETAIL** SCALE: NTS



(P) 39" X 20" X 10" EMERSON "CAC MODEL" 200AMP ELECTRICAL PANEL W/ TRANSFER SWITCH, CAMLOCK GEN PLUG & SURGE ARRESTOR (TMO SKU: 13013)

X34-35L/120

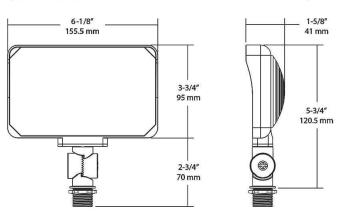

Pantrol

PanLoc Lite was developed to eliminate compatibility issues between Alternate Power Source Connections in a more compact cost effective solution.

- Eliminates Multiple Generator Plugs and Adapters
- Industry Standard, color coded Single Pole Connectors
- Touch Safe Design
- Industry Standard Mounting
- Decreased Down Time
- 200A, 3-Phase Capabilities kAIC Rating: Up to 10 ,000 amps
- Aluminum Construction
- Removable access cover
- Dimensions 10.5"h x 9"w x 9.25"d
- Ease of use **UL Listed**

PanLite Spec Sheet doc R1


Contact a Pantrol Inc. Sales Representative for configuration verification and pricing







Phone: (509).535.9061, Fax: (509).535.8793, 1.800.261.3505, www.pantrol.com

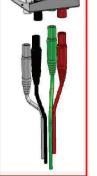

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=DRAWING TITLE:===

CAMLOCK GEN PLUG DETAIL SCALE: NTS









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$\sqrt{1}$	11/15/2022	ISSUED DESIGN REVIEW	BJT

B. J. THOMAS, P.E. **7607 80TH AVE NE**

PLANS PREPARED BY:

MARYSVILLE, WA 98270 206-851-1106


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GENERAL DETAILS





A-8 SCALE: NTS

WOOD FENCE DETAIL

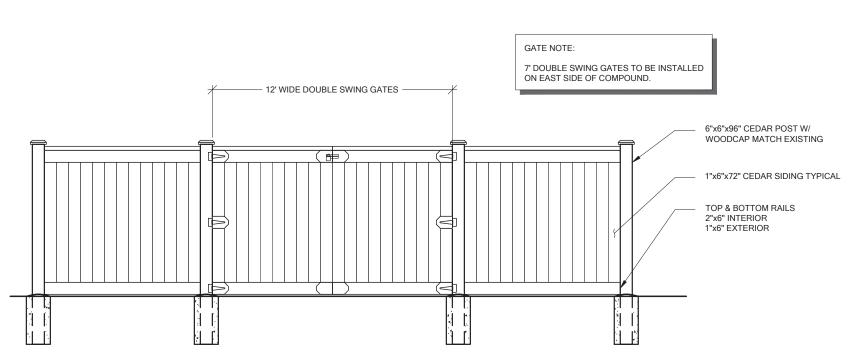FENCE & GATE NOTES:

- TOP RAIL & BRACE RAIL: SHALL BE CEDAR OR P/T IF OTHER WOOD IS USED.
- BARBED WIRE: NO BARBED WIRE ALLOWED AT THIS LOCATION
- GATE LATCH: SWINGING GATE LATCH; MATCH EXISTING; VERIFY WITH PROJECT MANAGER.

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PROJECT INFORMATION:

OLYMPIA LACEY AMTRAK/PSE/LP HOA SE05317B

59TH LP SE & STOCKTON ST SE LACEY, WA 98513

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PLANS PREPARED BY:

B. J. THOMAS, P.E. 7607 80TH AVE NE MARYSVILLE, WA 98270 206-851-1106

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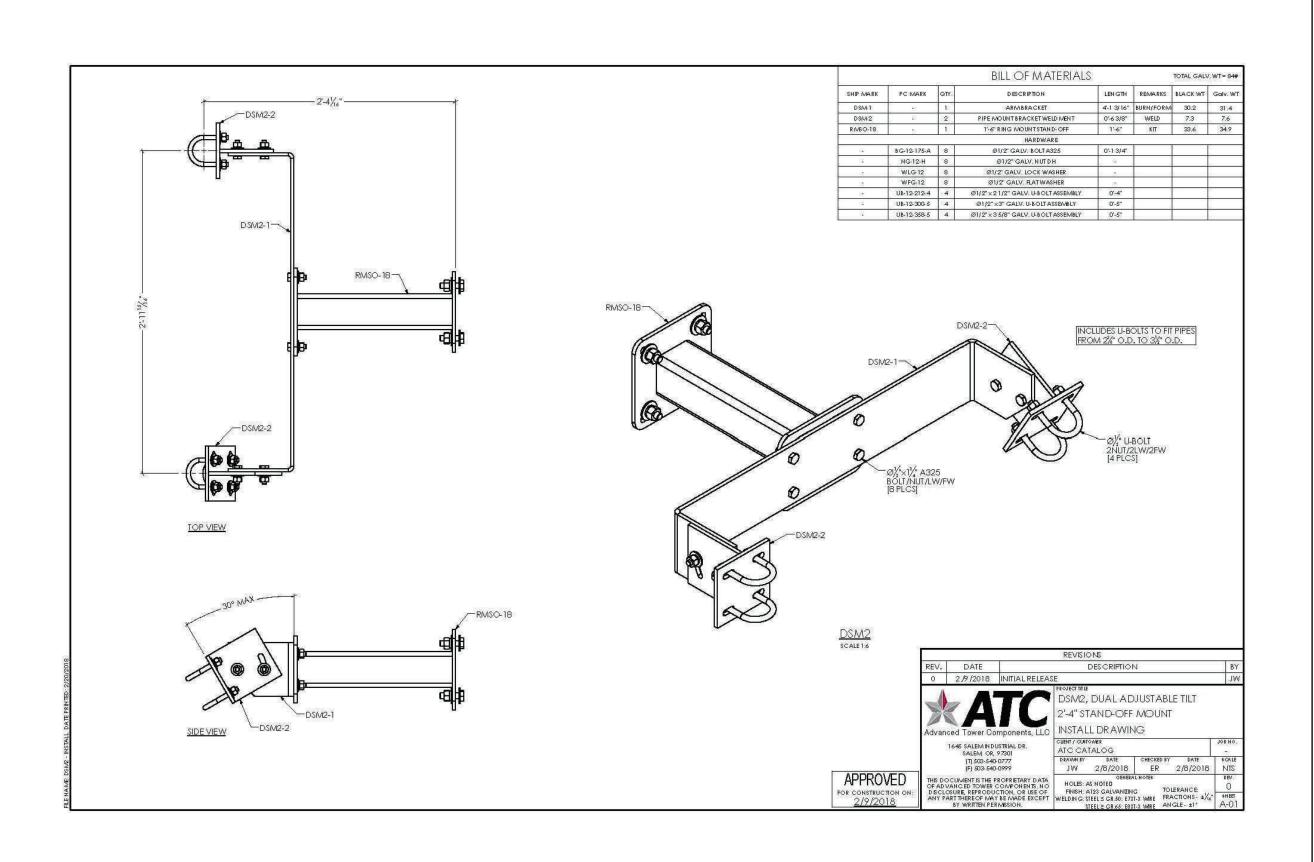
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GENERAL DETAILS

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A-8



PROJECT INFORMATION:

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59TH LP SE & STOCKTON ST SE LACEY, WA 98513

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B. J. THOMAS, P.E. 7607 80TH AVE NE MARYSVILLE, WA 98270 206-851-1106

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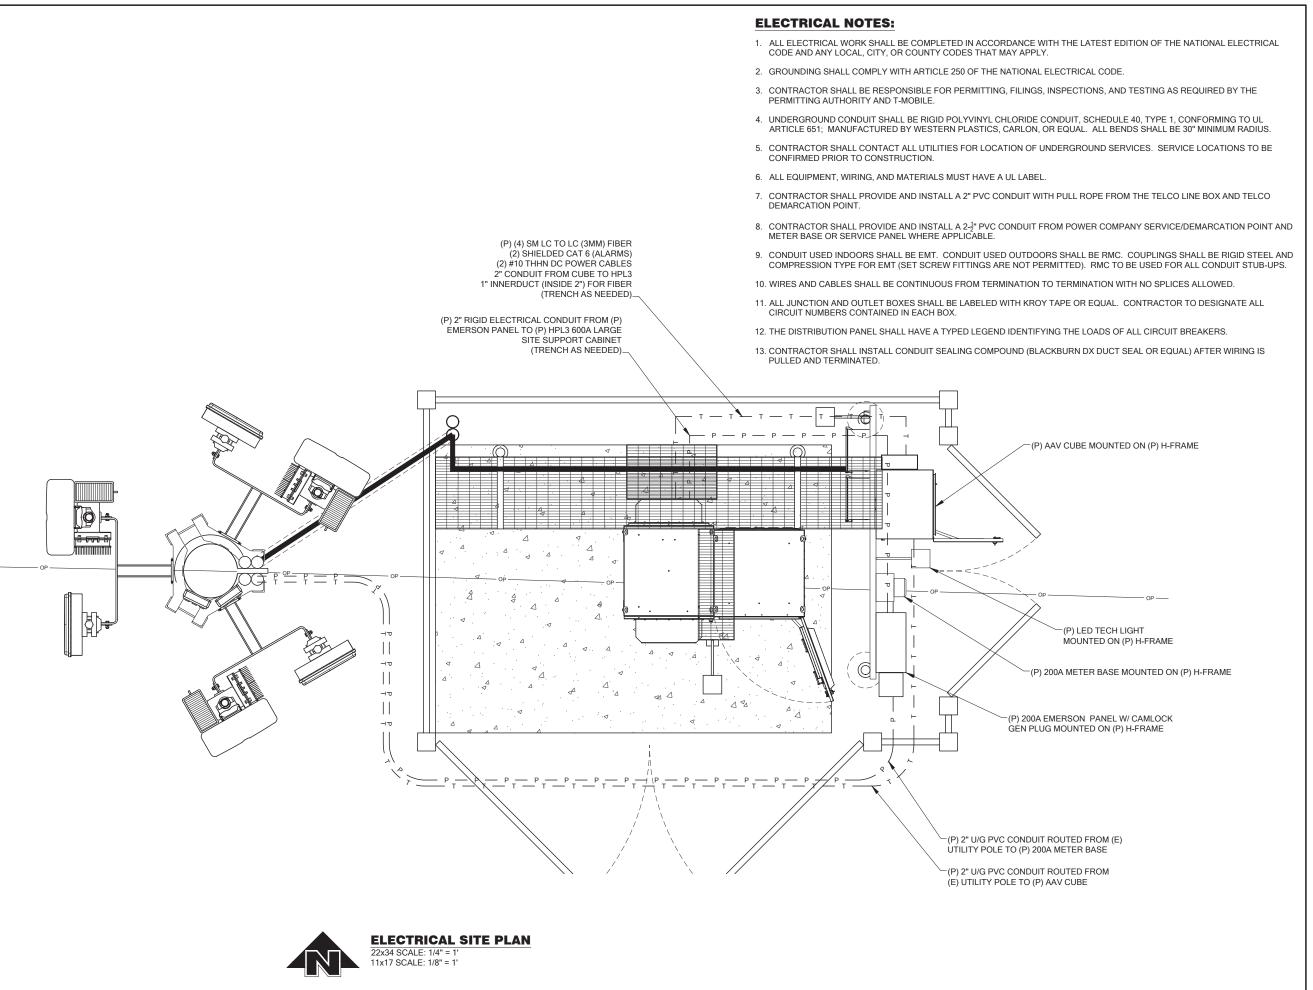
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DRAWING TITLE:

ANTENNA MOUNT DETAILS

DRAWING NUMBER:

A-9



PROJECT INFORMATION:

OLYMPIA LACEY AMTRAK/PSE/LP HOA SE05317B

59TH LP SE & STOCKTON ST SE LACEY, WA 98513

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PLANS PREPARED BY:

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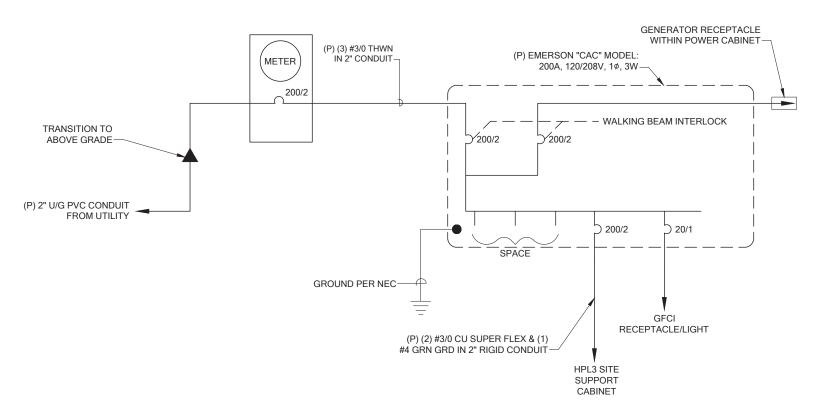
ELECTRICAL SITE PLAN

DRAWING NUMBER:

E-1

NEMA 3R - PANELBOARD FURNISHED BY T-MOBILE

	ACI	E MOUNTING C	PAN		S	CH	IED	UL	E	
NO.	Α	LOCATION: FENCED SERVING: T-MOBILE	COMPO	DUND					120/208 VOLTS 1PHASE 3 MPS WITH 200 MAIN BRE	
CKT NO.	L	OAD DESCRIPTION	KVA	TRIP AMPS		NSI -{	TRIP AMPS	KVA	LOAD DESCRIPTION	CKT NO
1	TV	SS	-	30	_~	+	20	.2	GFCI RECPT & LIGH	Τ 2
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REM	ARK	S:				COI	NNECT	ED LO	AD: 24.2 KVA 106.7	AMPS
	DEMAND LOAD: 24.2 KVA 106.7 AMPS									



ELECTRICAL ONE LINE

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PROJECT INFORMATION:

OLYMPIA LACEY AMTRAK/PSE/LP HOA SE05317B

59TH LP SE & STOCKTON ST SE LACEY, WA 98513

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$\sqrt{3}$	12/7/2022	MINOR REV	BJT
2	12/6/2022	REVISED PER REDLINES	BJT
$\sqrt{1}$	11/15/2022	ISSUED DESIGN REVIEW	BJT

==PLANS PREPARED BY:=

B. J. THOMAS, P.E. **7607 80TH AVE NE MARYSVILLE, WA 98270** 206-851-1106

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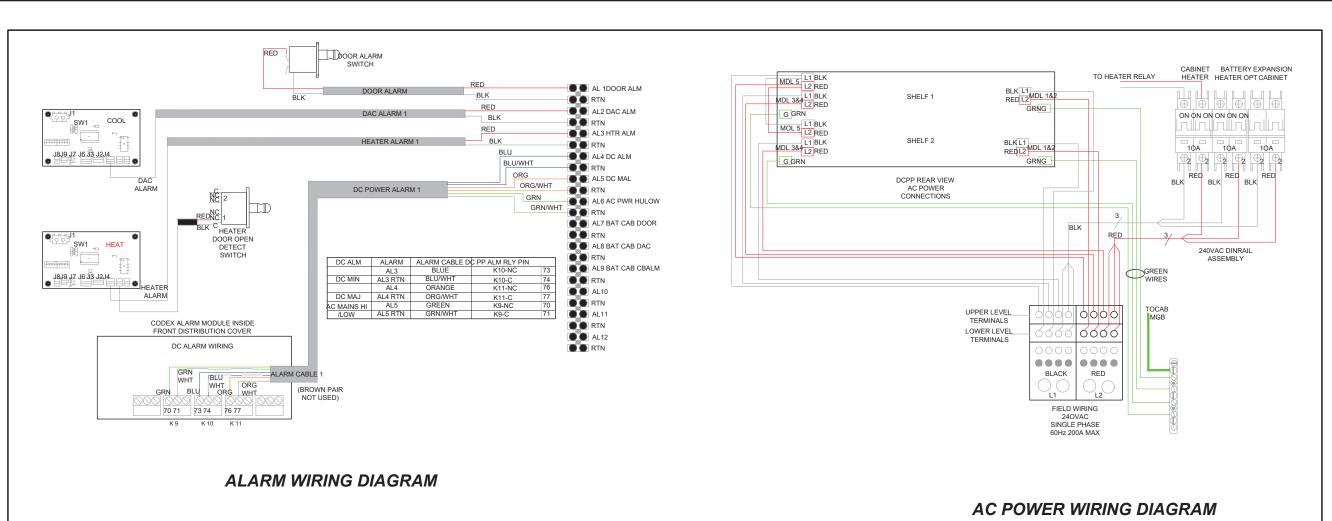


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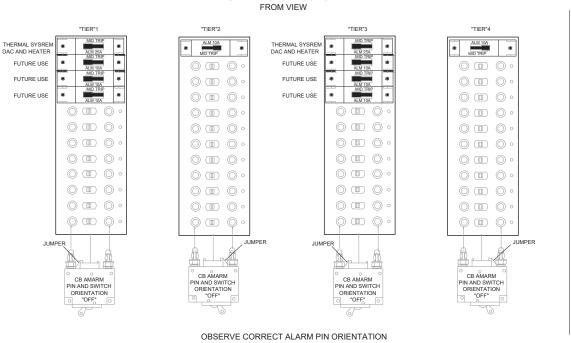
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ELECTRICAL DETAILS










DC DISTRIBUTION-DOOR OPEN

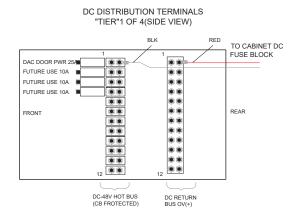

DC POWER WIRING DIAGRAM

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59TH LP SE & STOCKTON ST SE LACEY, WA 98513

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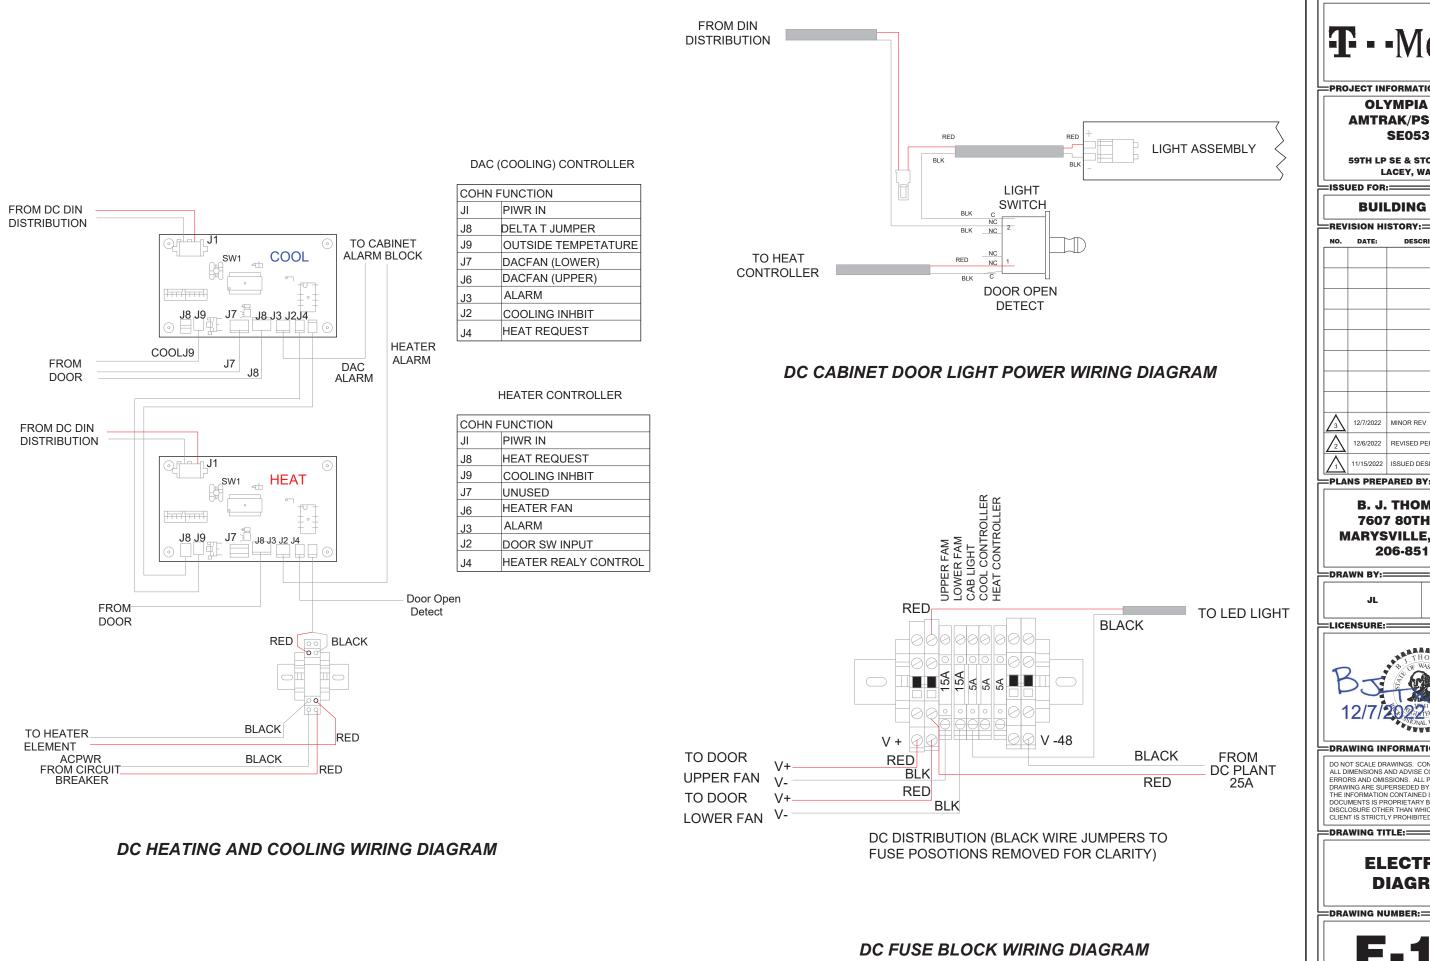


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DRAWING TITLE:

ELECTRICAL DIAGRAMS



PROJECT INFORMATION:

OLYMPIA LACEY AMTRAK/PSE/LP HOA SE05317B

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ELECTRICAL DIAGRAMS

SYMBOL LEGEND:

MGB

MASTER GROUND BAR 1/4"x4"x24"

AGB

ACCESSORY GROUND BAR 1/4"x4"x12" OR 1/4"x4"x20" COPPER

--- EXPOSED WIRING

---- UNDERGROUND WIRING

■ CADWELD

MECHANICAL CONNECTION

5/8"x8' COPPER CLAD STEEL GROUND ROD

INSPECTION PORT

■ -- EXOTHERMIC (CADWELD) BELOW GROUND

 \perp GROUND

(P) CADWELD BOND (TYP) (SEÉ GROUNDING NOTE #4) (SEE SHT. E-3 FOR ADDITIONAL INFORMATION). (P) MGB NEAR BTS EQUIPMENT MOUNTED TO ICEBRIDGE (SEE GROUNDING NOTE #5)-BOND (E) AGB TO (P) MGB-(E) AGB AT TOP OF POLE DIRECTLY BELOW ANTENNA ARRAY (SEE GROUNDING NOTE #5)_ (P) MECHANICAL CONNECTION (TYP) (SEE GROUNDING NOTES #4 & #6) (P) GROUND INSPECTION WELL (SEE SHT. E-3, DETAIL 4)-BOND BTS EQUIPMENT TO (P) MGB W/ (P) #2 SOLID BARE TINNED COPPER WIRE #2 GREEN STRANDED THWN (TYP) (SITE GROUND RING) (SEE SHT. E-3, DETAIL 5)_

(P) GROUND RODS AROUND (P) GROUND RING-

GROUNDING NOTES:

- GROUNDING SHALL COMPLY WITH LATEST EDITION OF THE NATIONAL ELECTRICAL CODE.
- 2. MINIMUM BENDING RADIUS FOR GROUND CONDUCTOR IS 8".
- 3. NO SPLICES PERMITTED IN GROUND CONDUCTORS.
- ALL GROUNDING CONNECTORS TO BE CLEAN AND FREE OF PAINT AT THEIR MATING SURFACES AND INSTALLED PER MANUFACTURER'S RECOMMENDATIONS. USE PENETROX OR EQUIVALENT ANTIOXIDANT GREASE.
- 5. ALL GROUND BAR CONNECTIONS ARE TO BE 2 HOLE LUG COMPRESSION TYPE. STACKED CONNECTIONS ARE NOT ACCEPTABLE. BACK TO BACK CONNECTIONS ON OPPOSITE SIDES OF THE GROUND BAR WILL BE PERMITTED.
- 6. ENSURE ALL MECHANICAL CONNECTORS ARE TORQUED TO THE MANUFACTURER'S SPECIFIED VALUES.
- 7. MULTIPLE BONDS ON GROUND RODS TO BE SEPARATED BY ATLEAST 6".
- 8. MAXIMUM RESISTANCE OF THE COMPLETED GROUND SYSTEM SHALL NOT EXCEED A RESISTANCE OF 5 OHMS TO EARTH.
- GROUND WIRES SHALL NOT BE INSTALLED THROUGH HOLES IN ANY METAL OBJECTS OR SUPPORTS; TO PRECLUDE ESTABLISHING A "CHOKE" POINT.
- 10. GROUND BARS SHALL NOT BE FIELD MODIFIED.
- 11. GROUND RING BURIAL DEPTH SHALL BE 30".
- 12. A CERTIFIED CONTRACTOR WILL MAKE ALL MEASUREMENTS REQUIRED TO TEST THE GROUNDING SYSTEM USING A MEGGER OR EQUIVALENT. THE ACCEPTABLE RESISTANCE MEASURED FOR THE GROUNDING SYSTEM WILL NOT EXCEED 5 OHMS RESISTANCE. THREE DISTANCES SHALL BE USED: 1 AT 100 FEET, 1 AT 70 FEET, AND 1 AT 35 FEET. THESE DISTANCES ARE SUBJECT TO A SITE BY SITE BASIS. T-MOBILE-WTS SHALL BE GIVEN 24 HOURS NOTICE. ALL COSTS ASSOCIATED WITH GROUND TESTING WILL BE AT THE EXPENSE OF THE CONTRACTOR.

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PLANS PREPARED BY:

B. J. THOMAS, P.E. 7607 80TH AVE NE MARYSVILLE, WA 98270 206-851-1106

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ELECTRICAL GROUNDING PLAN


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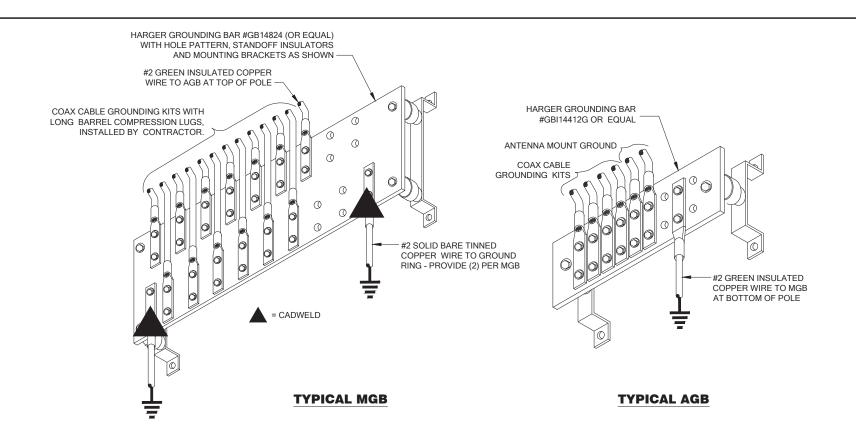
ELECTRICAL GROUNDING PLAN

22x34 SCALE: 1/2" = 1'


11x17 SCALE: 1/4" = 1'





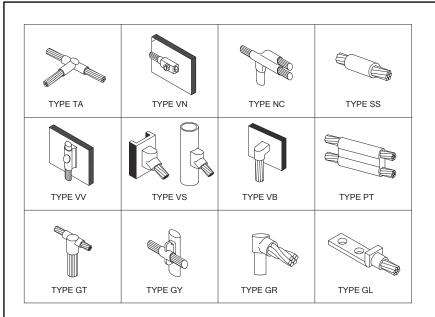





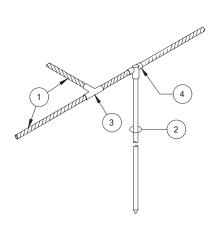

- 1 MAIN CONDUCTOR, COPPER CABLE
- 2 5/8"x8' COPPER CLAD STEEL GROUND ROD
- 3 CADWELD TYPE "TA"
- 4 CADWELD TYPE "GT"



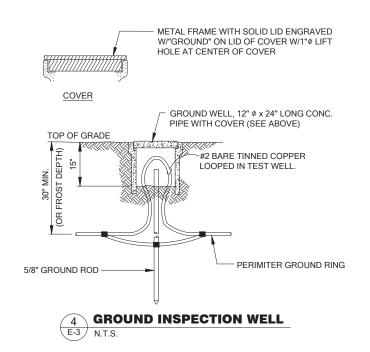

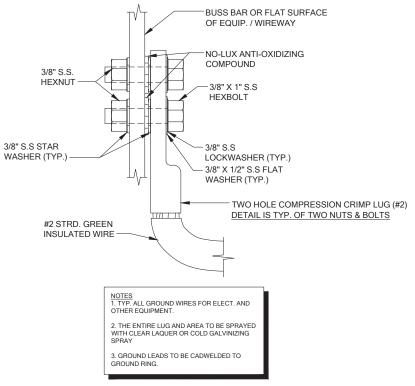

TYPICAL CABINET GROUNDING DETAIL

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PROJECT INFORMATION:

OLYMPIA LACEY AMTRAK/PSE/LP HOA SE05317B

59TH LP SE & STOCKTON ST SE LACEY, WA 98513

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ELECTRICAL GROUNDING DETAILS

DRAWING NUMBER:

E-3

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%LACEY

CITY OF LACEY

FEB 0 3 2023

Community Development Department 420 College Street 22

Lacey, WA 98503 (360) 491-5642

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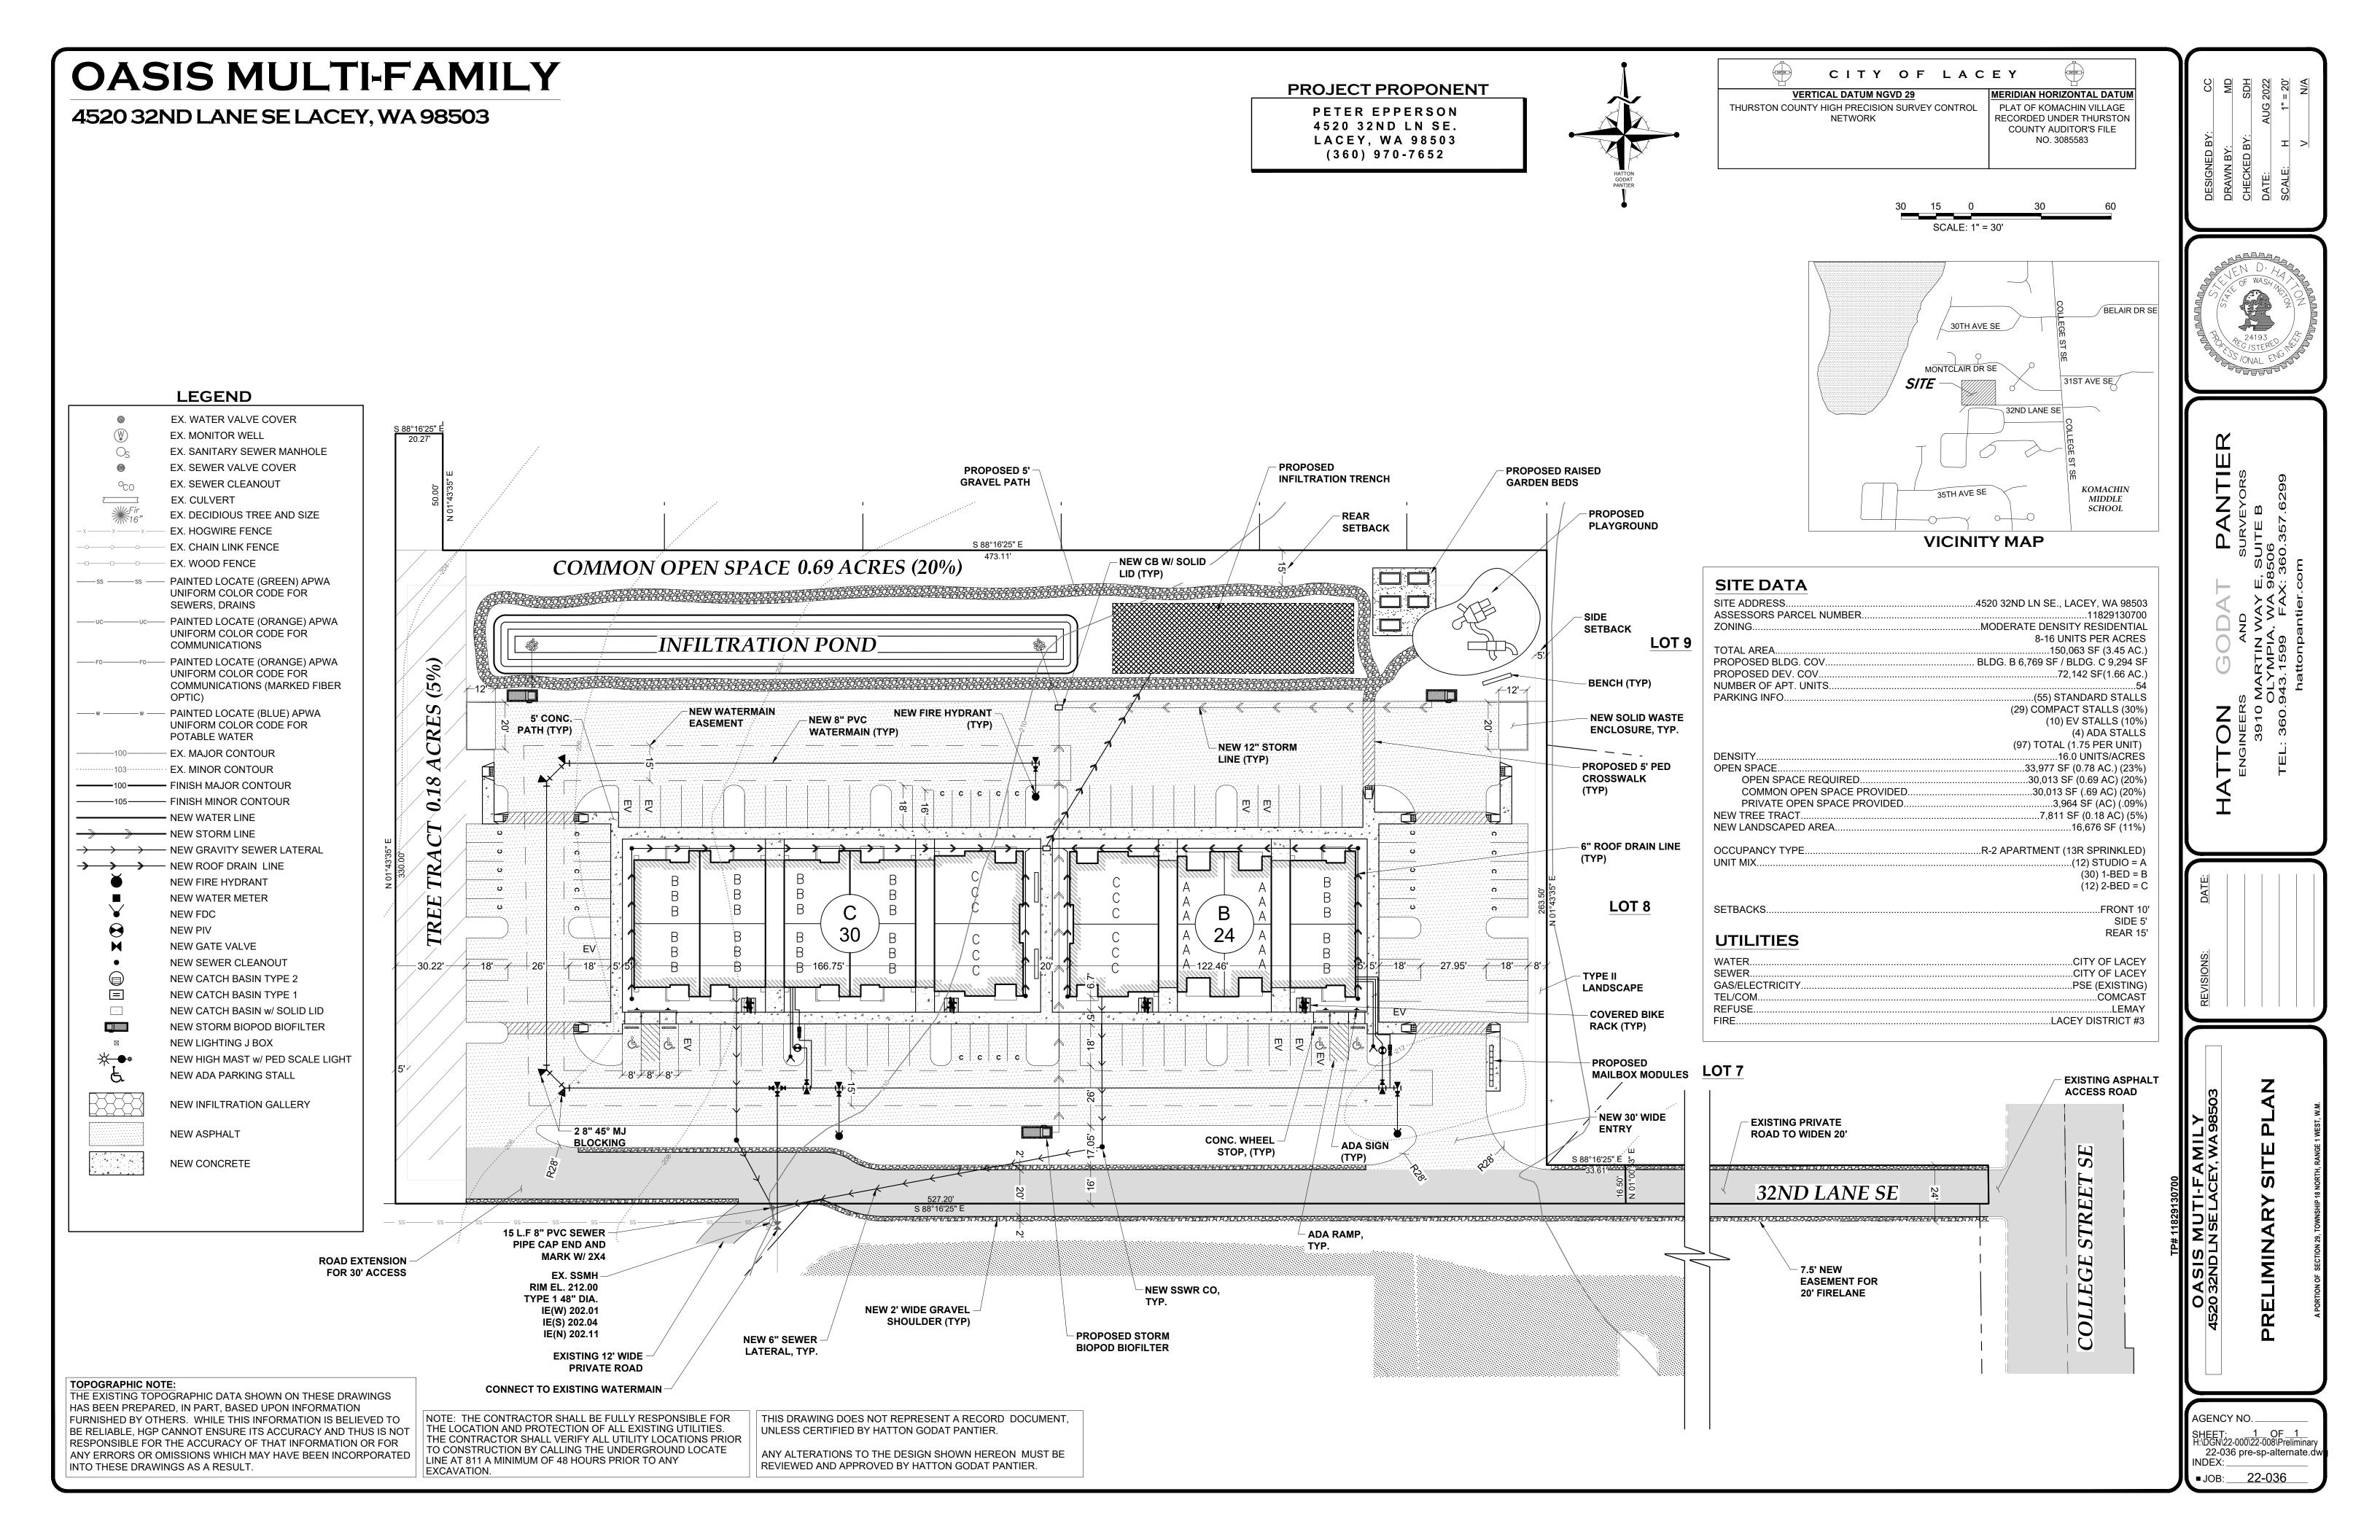
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RELATED CASE NUMBERS:	
PLANNER ASSIGNED:	
PW ASSIGNED:	


PRESUBMISSION CONFERENCE REQUEST FORM

ONE WEEK PRIOR TO REQUESTED DATE, SUBMIT VIA EMAIL TO PLANNING@CI.LACEY.WA.US, OR TO LACEY CITY HALL. NO FEE IS REQUIRED, SUBMISSION SHOULD INCLUDE COMPLETED APPLICATION, SITE PLAN DRAWING, VICINITY MAP, AND TRAFFIC GENERATION WORKSHEET.


APPLICANT: Carolyn Driscoll			
ADDRESS:	CITY:	STATE:	ZIP:
4529 32nd LN SE PHONE NUMBER: 360-970-7652	EMAIL:	ptepperson@gmail.com	98503
REPRESENTATIVE: Peter Epperson			
ADDRESS:	CITY:	STATE:	ZIP:
Same as above PHONE NUMBER:	EMAIL:		
PROJECT ADDRESS: 4520 32nd LN SE, La ASSESSOR'S TAX PARCEL NUMBER(S): BRIEF DESCRIPTION OF PROJECT: exploring		ress and egress to propert	y for development.
TOTAL ACREAGE: TOTAL SQ. F	T OF BLDG:	ZONING:	
PROPOSED LAND USE: () SINGLE-FAMILY ()	MULTI-FAMILY (loderate Density MMERCIAL () M.H. PARK
EXISTING ACCESS:	PROPO:	SED ACCESS:	• • • • •
private drive		private drive	or Montclaire
INDICATE PREFERENCE FOR A MEETING DATE A	ND TIME:		
(MEETINGS ARE HELD THE 2ND AND 4TH WEDNESDAY	OF EACH MONTH)	DATE: Fob 22 12 JME	1 nm

A presubmission conference is an opportunity for the developer and/or their representative to meet with staff to discuss preliminary studies or sketches of the proposed project. At the conference, staff will make available, pertinent information relating to the proposed development. The intent is to identify and/or eliminate as many potential problems as possible in order for the project to be processed without delay. The conference should take place prior to detailed work by an engineer or surveyor; however, the site drawing submitted, should have sufficient information to allow for staff review. Discussion topics will include such things as Comprehensive Plan, Street Plan, Storm Run Off & Retention, Shoreline Master Program, Zoning, Availability of Water/Sewer, Development Concepts, other requirements and permits, and the environmental impact. If the applicant owns adjacent land, the possibilities of future development will be discussed. Written information regarding process, specific requirements & related issues, will be furnished at the meeting. Staff will typically visit the site prior to the meeting and may enter the property if deemed necessary to gain a full understanding of the project.




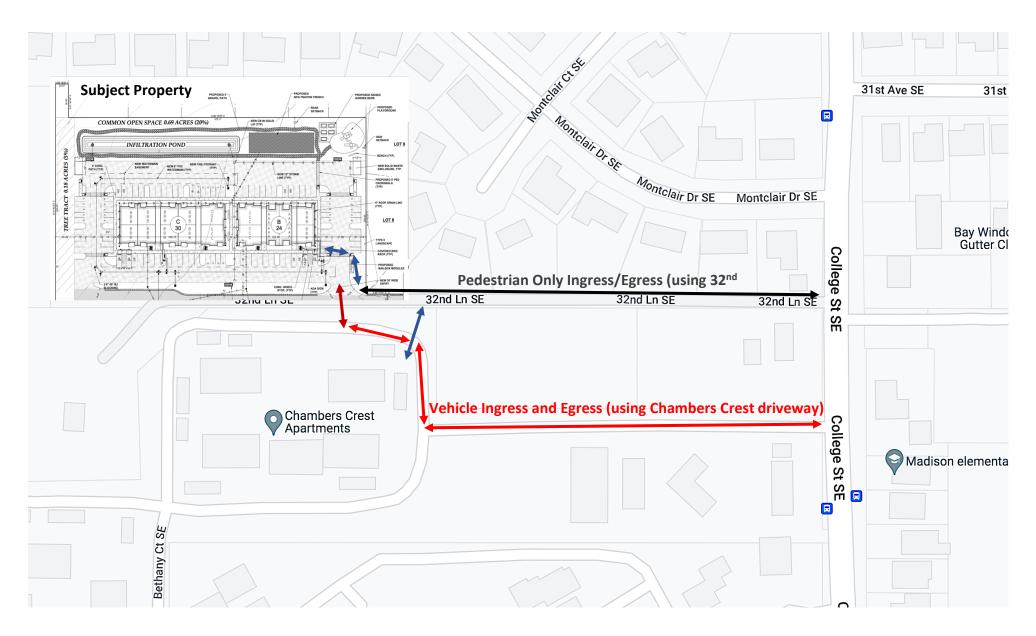

In this option, Chambers Crest residents and The Oasis tenants would share the existing Chambers Crest driveway off college. 32nd LN drive would become a pedestrian only path used by Chambers Crest and Oasis tenants. The new driveway between The Oasis and Chambers Crest (in a darker red) would be designed to comply with current code and meet fire safety standards. The Oasis and Chambers Crest Pedestrian access (see blue arrow) to 32nd LN would be a minimum of 5' wide and crosswalks on the driveways would be marked.

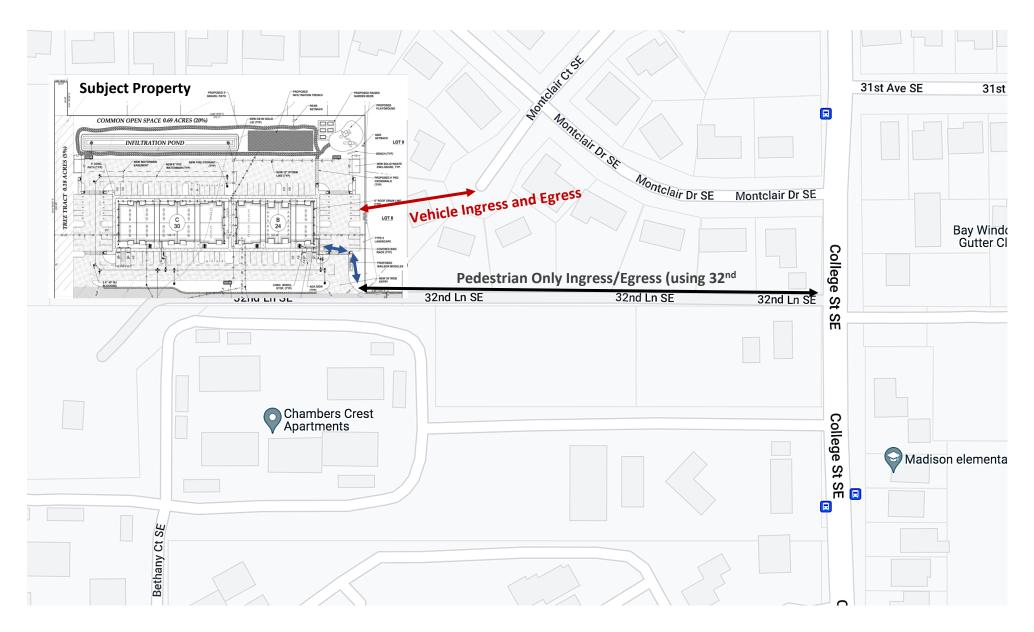

In this option, Oasis tenants would use Montclair Dr SE off college and turn south on Montclair CT SE. A new 20' driveway between The Oasis and Montclair CT (in red) would connect through Lot 8. The new driveway would comply with current code and meet fire safety standards. Oasis tenants would use 32nd LN as a pedestrian only walkway.

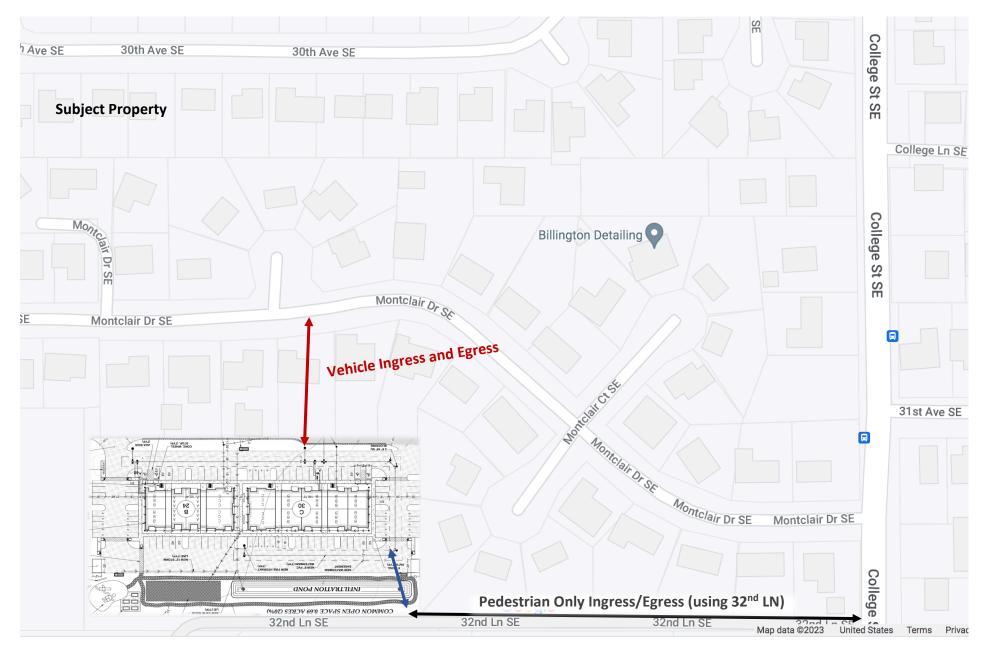

In this option, Oasis tenants would use Montclair Dr SE off college and turn south onto a new 20' driveway between The Oasis and Montclair DR SE (in red). The driveway would be through 4407 Montclair Dr. The new driveway would comply with current code and meet fire safety standards. Oasis tenants would use 32nd LN as a pedestrian only walkway. The on-site water treatment would be modified to accommodate a sidewalk connector with 32nd LN SE.