RAC PARKING LOT EXPANSION CONSTRUCTION PLANS LACEY, WA

OWNER / APPLICANT SITE ADDRESS: 8345 STEILACOOM RD SE LACEY, WA 98513 CITY OF LACEY 420 COLLEGE ST SE LACEY, WA 98503 PHONE: 360.413.4340 CONTACT: ASHLEY SMITH **BASIS OF BEARINGS:** CONSULTANTS SCJ ALLIANCE 8730 TALLON LANE NE, SUITE 200 MERIDIAN IS WASHINGTON COORDINATE SYSTEM OF 1983/91
- SOUTH ZONE DERIVED FROM TIES TO HPGN STATIONS LACEY, WA 98516 PHONE: 360.352.1465 SANDERSON, MCKENNA AND CBL1110 AND TO WSDOT GPS STATIONS G259R, GP34005-2, GP34005-4, GP34101-32, CONTACT: WHITNEY HOLM, PE GP34101-39, HC34-2, LUHR RM2, TS34-33, TS34-59 AND TO THURSTON COUNTY GPS STATIONS U-531, AT-194, SITE INFORMATION AT-352, AT-355, AT-447, AT449 AND AT-478. PARCEL NUMBER: 11814410200; 11814410300 DISTANCES SHOWN ARE GROUND SCALE U.S. SURVEY ACRES: ±6.28 FEET. COMBINED SCALE FACTOR (GROUND TO GRID) IS 0.999935701. SURVEY AF# 3111152 DATED 09-24-1997. LACEY PROJECT NUMBER DATUM: PW 2022-19 LACEY CITY OFFICIALS THE CITY OF LACEY BENCHMARKS ARE BASED ON NGVD 29 DATUM FROM PRIMARY CONTROL ESTABLISHED BY ANDY RYDER FEDERAL AND STATE AGENCIES TO FIRST OR SECOND DEPUTY MAYOR LENNY GREENSTEIN ORDER ACCURACY. THE CITY OF LACEY'S BENCHMARKS MICHAEL STEADMAN ARE GENERALLY TO THIRD ORDER ACCURACY. ED KUNKEL ROBIN VAZQUEZ CITY MANAGER CITY ATTORNEY DAVID S. SCHNEIDER AUBREY COLLIER, P.E., S.E. CITY ENGINEER DIRECTOR OF PW SCOTT EGGER, P.E. SCOTT EGGER, P.E. PUBLIC WORKS DIRECTOR Rainier vista mobile home park The GraceWorks Church: Lacey Campus Billing Solutions 360 Dynamic Body Sculpting Our Place To Grow 9th Ave SE

LEGAL DESCRIPTION:

SECTION 13 / 14 TOWNSHIP 18 RANGE 1W QUARTER NW SW / NE SE BLA13101203 TR A DOCUMENT 4335765

SECTION 13 / 14 TOWNSHIP 18 RANGE 1W QUARTER NW SW / NE SE BLA13101203LA TR B DOCUMENT 4335765

UTILITIES

STORMWATER/SEWER:
CITY OF LACEY
UTILITY SERVICES
PO BOX 3400
420 COLLEGE STREET SE
LACEY, WA 98509-3400
PH: 360.491.5616

WATER/SOLID WASTE: CITY OF LACEY UTILITY SERVICES PO BOX 3400 420 COLLEGE STREET SE LACEY, WA 98509-3400 PH: 360.491.5616

ELECTRIC/NATURAL GAS:
PUGET SOUND ENERGY — PSE
10885 NE 4TH STREET
BELLEVUE, WA 98009
PH: 425.452.1234
EMERGENCY SERVICE: 888.225.5773
CONTACT: DAVE LESINSKI
ENGINEERING SPECIALIST, CONSTRUCTION SERVICES
PH: 253.476.6425

CUSTOMER CONSTRUCTION 3130 S 38TH ST TACOMA, WA 98409 PH: 888.321.7779

TELEPHONE:
QWEST COMMUNICATIONS
711 CAPITOL WAY S, STE 307
OLYMPIA, WA 98501
PH: 360.754.5912

CONTACT: WAYDE HOLMQUIST

SR DESIGN ENGINEER

CABLE: COMCAST

410 VALLEY AVE NW, STE 307
PUYALLUP, WA 98371
PH: 253.261.0945
FX: 253.864.4215
CONTACT: ERIC PARTON
COMCAST BUSINESS SERVICES GROUP

	SHE	ET INDEX
SHEET NUMBER	SHEET TITLE	SHEET DESCRIPTION
01	CV-01	COVER SHEET
02	GN-01	GENERAL NOTES
03	EX-01	EXISTING CONDITIONS MAP COVER SHEET
04	EX-02	TOPOGRAPHIC SURVEY
05	EX-03	TOPOGRAPHIC SURVEY
06	EC-01	DEMOLITION AND TESC PLAN
07	EC-02	EROSION CONTROL NOTES & DETAILS
08	SP-01	SITE & PAVING PLAN
09	SP-02	SITE PLAN NOTES & DETAILS
10	SP-03	SITE PLAN DETAILS
11	HC-01	HORIZONTAL CONTROL PLAN
12	CG-01	GRADING PLAN
13	CG-02	ENLARGED GRADING PLAN
14	CG-03	ENLARGED GRADING PLAN
15	SD-01	DRAINAGE PLAN
16	SD-02	STORM DRAINAGE NOTES & DETAILS
17	SD-03	STORMWATER POND PROFILES
18	SD-04	STORM PIPE PROFILES
19	SD-05	STORM PIPE PROFILES
FRONTAGE IMPROVE	MENTS	
20	FR-01	STEILACOOM TESC & DEMO PLAN
21	FR-02	STEILACOOM ROADWAY PLAN
22	FR-03	STEILACOOM STRIPING PLAN
23	FR-04	STEILACOOM RD DETAILS
LANDSCAPE		
25	LS-00	OVERALL LANDSCAPE PLAN
26	LS-01	NORTHWEST LANDSCAPE PLAN
27	LS-02	NORTHEAST LANDSCAPE PLAN
28	LS-03	SOUTHWEST LANDSCAPE PLAN
29	LS-04	SOUTHEAST LANDSCAPE PLAN
30	LS-05	LANDSCAPE DETAILS
31	LS-06	OVERALL IRRIGATION PLAN
32	LS-07	NORTHEAST IRRIGATION PLAN
33	LS-08	NORTHEAST IRRIGATION PLAN
34	LS-09	SOUTHWEST IRRIGATION PLAN
35	LS-10	SOUTHEAST IRRIGATION PLAN
36	LS-11	IRRIGATION NOTES AND DETAILS
ELECTRICAL	•	•
37	E-001	ELECTRICAL LEGEND AND LIGHTING SCHEDUL
38	E-101	ELECTRICAL SITE PLAN
39	E-102	ELECTRICAL SITE PLAN
40	E-104	SECURITY SITE PLAN
41	E-105	SECURITY COVERAGE SITE PLAN
42	E-601	ONE-LINE DIAGRAM AND PANEL SCHEDULE
43	E-701	ELECTRICAL DETAILS
44	E-702	STREET LIGHTING DETAILS
 45	E-703	SECURITY DETAILS

	A REVISIONS			
		SCJ ALLIANCE	CONSULTING SERVICES 8730 TALLON LANE NE, SUITE 200, LACEY, WA 98516	P: 360.352.1465 F: 360.352.1509
	HULLIO	COVERSHEEL		
	SHEET TITLE:	IGNEF	₹:	F
		WN B' K. G. ROVE	ANS	

WASHINGTON ORKS

ISION

S PARKING LOT EXPANS 8345 STEILACOOM RD SE LACEY, WA

RAC

W. HOLM

22-000313

DRAWING FILE NO: 22-000313 CV-01

DRAWING NO:

SHEET NO:

LACEY DWG NUMBER:

D-22-18

JOB NO:

SEPT. 13, 2023

CV-01

01 of 45

CALL BEFORE YOU DIG

THE CONTRACTOR SHALL BE FULLY RESPONSIBLE FOR THE LOCATION AND PROTECTION OF ALL EXISTING UTILITIES. THE CONTRACTOR SHALL VERIFY ALL UTILITY LOCATIONS PRIOR TO CONSTRUCTION BY CALLING THE UNDERGROUND LOCATE LINE AT 811 OR 1.800.424.5555 A MINIMUM OF 48 HOURS PRIOR TO ANY EXCAVATION.

A PORTION OF SEC 14, T 18N., R 1W., W.M. LACEY, WA

SCJ ALLIANCE **GENERAL CONSTRUCTION NOTES:**

- 1. ALL WORK, WORKMANSHIP AND MATERIALS FOR THIS PROJECT SHALL MEET OR EXCEED THE PROJECT SPECIFICATIONS, CITY OF LACEY ENGINEERING DESIGN AND DEVELOPMENT STANDARDS AND MAY INCLUDE REFERENCES TO THE MOST CURRENT VERSION OF THE WSDOT/APWA STANDARD SPECIFICATIONS FOR ROAD, BRIDGE, AND MUNICIPAL CONSTRUCTION. IF THERE IS A CONFLICT BETWEEN THE SPECIFICATION TYPES, THE MOST RESTRICTIVE REFERENCE SHALL BE ADHERED TO.
- 2. ALL GOVERNMENTAL SAFETY REGULATIONS SHALL BE STRICTLY ADHERED TO INCLUDING OSHA, WISHA AND THE WASHINGTON DEPARTMENT OF LABOR AND INDUSTRY.
- IT IS THE RESPONSIBILITY OF THE CONTRACTOR TO DULY NOTIFY THE CITY IN ADVANCE OF THE COMMENCEMENT OF ANY AUTHORIZED WORK AND TO SCHEDULE REQUIRED INSPECTIONS. ALL REQUIRED INSPECTION TESTS WILL BE PERFORMED AT THE CONTRACTOR'S EXPENSE.
- 4. THE CONTRACTOR SHALL PROVIDE A TWO—YEAR WARRANTY ON ALL WORKMANSHIP AND MATERIAL FOLLOWING ACCEPTANCE OF THE PROJECT BY THE OWNER.
- 5. THE APPROVAL OF THESE PLANS BY THE CITY OF LACEY DOES NOT RELIEVE THE CONTRACTOR OR DEVELOPER OF THE RESPONSIBILITY TO COMPLY WITH THE REQUIREMENTS OF OTHER GOVERNING AGENCIES.
- <u>CAUTION NOTICE TO CONTRACTOR</u>
- THE CONTRACTOR IS SPECIFICALLY CAUTIONED THAT THE LOCATION OF EXISTING UTILITIES AS SHOWN ON THESE PLANS IS BASED ON THE PROJECT SURVEY AND OTHER RECORDS OF UTILITIES. THE INFORMATION IS NOT TO BE RELIED ON AS BEING EXACT OR COMPLETE. THE CONTRACTOR SHALL CALL 1-800-424-5555 48 HOURS PRIOR TO PLANNED EXCAVATIONS.
- THE DESIGN SHOWN IS BASED UPON THE ENGINEER'S UNDERSTANDING OF THE EXISTING CONDITIONS. THE EXISTING CONDITIONS SHOWN ON THIS PLAN SHEET ARE BASED UPON COMPILED SURVEY DATA. THE CONTRACTOR IS RESPONSIBLE FOR VERIFYING FIELD CONDITIONS PRIOR TO BIDDING THE PROPOSED WORK IMPROVEMENTS. IF CONFLICTS ARE DISCOVERED. THE CONTRACTOR SHALL NOTIFY THE OWNER OR OWNERS REPRESENTATIVE.
- EXISTING UTILITIES ARE SHOWN FOR REFERENCE ONLY. PRIOR TO CONNECTION TO EXISTING UTILITIES THE CONTRACTOR SHALL VERIFY EXACT LOCATION, DIA, LENGTH, CONDITION, PIPE TYPE, SLOPE AND VERTICAL AND HORIZONTAL ALIGNMENT OF THE EXISTING UTILITY AND PROPOSED POINT OF CONNECTION. THE CONTRACTOR SHALL REPORT ANY DISCREPANCIES TO ENGINEER PRIOR TO CONSTRUCTION.
- PRIOR TO COMMENCING WORK, THE CONTRACTOR SHALL OBTAIN ALL NECESSARY LOCAL, STATE, AND FEDERAL APPROVALS AND PERMITS.
- 10. IT SHALL BE THE RESPONSIBILITY OF THE CONTRACTOR TO HAVE A COPY OF THE APPROVED PLANS, SPECIFICATIONS, AND CONTRACT DOCUMENTS AT THE CONSTRUCTION SITE AT ALL TIMES.
- 11. THE CONTRACTOR SHALL PROVIDE SLOPE PROTECTION FOR SLOPES OF 5:1 OR GREATER ACCORDING TO ASSOCIATED GENERAL CONTRACTORS (AGC) STANDARD GUIDELINES AND BEST MANAGEMENT PRACTICES (BMP'S).
- 12. THE CONTRACTOR SHALL MAINTAIN EROSION CONTROL FACILITIES IN ACCORDANCE WITH THE CITY OF LACEY, DEPARTMENT OF ECOLOGY STORMWATER MANUAL, THE STORMWATER POLLUTION PREVENTION PLAN (SWPPP), AND PER THE EROSION CONTROL PLAN.
- 13. THE CONTRACTOR SHALL SAFELY MAINTAIN TRAFFIC AND CONTINUOUS ACCESS TO PRIVATE AND/OR PUBLIC
- 14. CONSTRUCTION SIGNING AND TRAFFIC CONTROL SHALL BE PER THE CURRENT COPY OF THE MANUAL OF UNIFORM TRAFFIC CONTROL DEVICES (MUTCD).
- 15. ALL VEHICLES AND EQUIPMENT SHALL BE KEPT WITHIN THE WORK AREAS ESTABLISHED FOR THAT WORK SHIFT UNLESS TRAVELING TO OR FROM THE SITE. UNDER NO CIRCUMSTANCES SHALL VEHICLES OR EQUIPMENT BE PARKED OR STORED OUTSIDE OF THESE AREAS.
- 16. OTHER CONSTRUCTION PROJECTS MAY OCCUR NEAR THE PROJECT SITE AND MAY BE IN PROGRESS CONCURRENT WITH THE PROJECT. THE CONTRACTOR SHALL COOPERATE AS NECESSARY AND NOT INTERFERE OR HINDER THE PROGRESS OR COMPLETION OF WORK BEING PERFORMED BY OTHER CONTRACTORS.
- 17. THE CONTRACTOR SHALL BE RESPONSIBLE FOR FURNISHING AND INSTALLING ALL MATERIALS, LABOR, AND EQUIPMENT NECESSARY TO COMPLETE THE WORK SHOWN ON THESE DRAWINGS AND TO OBTAIN ACCEPTANCE BY THE CITY OF LACEY AND THE PROJECT OWNER.
- 18. ALL AREAS DISTURBED DURING CONSTRUCTION SHALL BE RESTORED TO THEIR ORIGINAL "PRE CONSTRUCTION"
- 19. DRIVEWAY ACCESS AND UTILITY SERVICE TO EXISTING HOMES AND BUSINESSES SHALL BE MAINTAINED AT ALL
- 20. SEE LANDAU DRAFT TECHNICAL MEMORANDUM DATED SEPTEMBER 1, 2022 FOR ADDITIONAL INFORMATION INCLUDING

SEC. 14, T 18N., R 1W., W.M.

1. ALL WORKMANSHIP AND MATERIALS SHALL BE IN ACCORDANCE WITH CITY OF LACEY STANDARDS AND THE MOST CURRENT EDITION OF THE STATE OF WASHINGTON STANDARD SPECIFICATIONS FOR ROAD, BRIDGE AND MUNICIPAL CONSTRUCTION (WSDOT/APWA). IN CASES OF CONFLICT, THE MOST STRINGENT STANDARD SHALL APPLY.

CITY OF LACEY GENERAL CONSTRUCTION NOTES

- 2. THE CONTRACTOR SHALL BE IN COMPLIANCE WITH ALL SAFETY STANDARDS AND REQUIREMENTS AS SET FORTH BY OSHA, WISHA AND THE STATE OF WASHINGTON, DEPARTMENT OF LABOR AND INDUSTRIES.
- 3. ALL APPROVALS AND PERMITS REQUIRED BY THE CITY OF LACEY SHALL BE OBTAINED BY THE CONTRACTOR PRIOR TO THE START OF CONSTRUCTION.
- 4. IF CONSTRUCTION IS TO TAKE PLACE IN THE COUNTY RIGHT-OF-WAY, THE CONTRACTOR SHALL NOTIFY THE COUNTY AND OBTAIN ALL THE REQUIRED APPROVALS AND PERMITS.
- 5. A PRE-CONSTRUCTION MEETING SHALL BE HELD WITH THE CITY OF LACEY CONSTRUCTION INSPECTOR A MINIMUM 72 HOURS PRIOR TO THE START OF CONSTRUCTION.
- 6. THE CITY OF LACEY CONSTRUCTION INSPECTOR SHALL BE NOTIFIED A MINIMUM OF 48 HOURS IN ADVANCE OF A TAP CONNECTION TO AN EXISTING MAIN. THE INSPECTOR SHALL BE PRESENT AT THE TIME OF THE TAP.
- 7. THE CONTRACTOR SHALL BE FULLY RESPONSIBLE FOR THE LOCATION AND PROTECTION OF ALL EXISTING UTILITIES. THE CONTRACTOR SHALL VERIFY ALL UTILITY LOCATIONS PRIOR TO CONSTRUCTION BY CALLING THE UNDERGROUND LOCATE LINE AT 811 NOT LESS THAN TWO BUSINESS DAYS AND NOT MORE THAN 10 BUSINESS DAYS PRIOR TO ANY EXCAVATION. THE CONTRACTOR WILL ALSO BE RESPONSIBLE FOR MAINTAINING ALL LOCATE MARKS ONCE THE UTILITIES HAVE BEEN LOCATED.
- 8. TEMPORARY STREET PATCHING SHALL BE ALLOWED FOR AS APPROVED BY THE CITY ENGINEER. TEMPORARY STREET PATCHING SHALL BE PROVIDED BY PLACEMENT AND COMPACTION OF 1-INCH MAXIMUM ASPHALT CONCRETE COLD MIX. CONTRACTOR SHALL BE RESPONSIBLE FOR MAINTENANCE AS REQUIRED.
- 9. THE CONTRACTOR SHALL BE RESPONSIBLE FOR ALL TRAFFIC CONTROL IN ACCORDANCE WITH THE WSDOT/APWA STANDARD PLANS FOR ROAD, BRIDGE AND MUNICIPAL CONSTRUCTION (ALL APPLICABLE "K" PLANS) AND/OR THE MANUAL ON UNIFORM TRAFFIC CONTROL DEVICES (MUTCD). PRIOR TO DISRUPTION OF ANY TRAFFIC, A TRAFFIC CONTROL PLAN SHALL BE PREPARED AND SUBMITTED TO THE CITY FOR APPROVAL. NO WORK SHALL COMMENCE UNTIL ALL APPROVED TRAFFIC CONTROL IS IN PLACE.
- 10. EROSION CONTROL/WATER POLLUTION MEASURES SHALL BE REQUIRED IN ACCORDANCE WITH SECTION 1-07.15 OF THE WSDOT/APWA STANDARD SPECIFICATIONS FOR ROAD, BRIDGE AND MUNICIPAL CONSTRUCTION AND THE CITY OF LACEY STORMWATER DESIGN MANUAL. AT NO TIME WILL SILTS AND DEBRIS BE ALLOWED TO DRAIN INTO AN EXISTING OR NEWLY INSTALLED FACILITY UNLESS SPECIAL PROVISIONS HAVE BEEN DESIGNED.
- 11. ALL SURVEYING AND STAKING SHALL BE PERFORMED PER THE CORRESPONDING CHAPTER OF THE CITY OF LACEY DEVELOPMENT GUIDELINES AND PUBLIC WORKS STANDARDS.
- 12. IT SHALL BE THE RESPONSIBILITY OF THE CONTRACTOR TO HAVE A COPY OF AN APPROVED SET OF PLANS ON THE CONSTRUCTION SITE AT ALL TIMES.
- 13. ANY CHANGES TO THE DESIGN SHALL FIRST BE REVIEWED AND APPROVED BY THE PROJECT ENGINEER AND THE CITY OF LACEY.
- 14. IF CONSTRUCTION IS TO TAKE PLACE IN OTHER JURISDICTION'S RIGHT-OF-WAY(I.E., THE COUNTY, THE STATE, THE CITY OF OLYMPIA, OR OTHER ADJACENT MUNICIPALITIES), THE CONTRACTOR SHALL NOTIFY THE JURISDICTION AND OBTAIN ALL THE REQUIRED APPROVALS AND PERMITS.
- 15. PRIOR TO BACKFILL ALL MAINS AND APPURTENANCES SHALL BE INSPECTED AND APPROVED BY THE CITY OF LACEY CONSTRUCTION INSPECTOR. APPROVAL SHALL NOT RELIEVE THE CONTRACTOR FOR CORRECTION OF ANY DEFICIENCIES AND/OR FAILURES AS DETERMINED BY SUBSEQUENT TESTING AND INSPECTIONS. IT SHALL BE THE CONTRACTOR'S RESPONSIBILITY TO NOTIFY THE CITY OF LACEY FOR THE REQUIRED INSPECTIONS.
- 16. THE CITY WILL BE GIVEN 72-HOURS' NOTICE PRIOR TO SCHEDULING A SHUTDOWN. WHERE CONNECTIONS REQUIRE "FIELD VERIFICATION", CONNECTION POINTS SHALL BE EXPOSED BY THE CONTRACTOR AND FITTINGS VERIFIED 72 HOURS

ABBREVIATIONS

ABBRE	ABBREVIATIONS						
& + - - - - - - - - - - - - - - - - - -	AND ANGLE APPROXIMATELY AT CENTERLINE DEGREE EQUALS FOOT GREATER THAN INCH NUMBER PERCENT	L LB(S) LF LP LT MAX MFR MH MIN MISC MON	LENGTH POUND(S) LINEAR FEET LOW POINT ELEVATION LEFT MAXIMUM MANUFACTURER MANHOLE MINIMUM, MINUTE MISCELLANEOUS MONUMENT IN CASE				
AC ADD'L ADJT AFF AP APPROX ARCH ASTM ATB AVE BCR BFV	ASPHALTIC CONCRETE ADDITIONAL ADJACENT ABOVE FINISH FLOOR ANGLE POINT APPROXIMATE ARCHITECT AMERICAN SOCIETY FOR TESTING AND MATERIALS ASPHALT TREATED BASE COURSE AVENUE BEGIN CURB RETURN BUTTERFLY VALVE	N N/A NE NEMA NIC NO, NO NTS NW OC, OC OD OSHA P	NORTH, NORTHING NOT APPLICABLE NORTHEAST NATIONAL ELECTRICAL MANUFACTURER ASSOCIATION NOT IN CONTRACT NUMBER NOT TO SCALE NORTHWEST ON CENTER OUTSIDE DIAMETER OCCUPATIONAL SAFETY & HEALTH ADMINISTRATION				
BGS BLK BLDG BM BVC C CB CF	BELOW GROUND SURFACE BLOCK(S) BUILDING BENCHMARK BEGIN VERTICAL CURB CONDUIT CATCH BASIN CUBIC FEET	PC PCC PED PI PC POC PP	POWER, POWER VAULT POINT OF CURVATURE POINT OF COMPOUND CURVE OR PORTLAND CEMENT CONCRETE PEDESTAL POINT OF INTERSECTION PROPERTY LINE POINT OF CONNECTION POWER POLE				
CIRC CIP CIP MON CJ Q CL CLR CO COMM	CIRCUIT, CIRCULA(R, TION) CAST—IN—PLACE CAST—IN—PLACE MONUMENT CENTER JOINT CENTER LINE CROWNLINE CLEAR CLEANOUT COMMUNICATION COMPACTED	PRC PROP PSI PT PVC PVI PVT PVMT PWR	POINT OF REVERSE CURVATURE PROPERTY POUNDS PER SQUARE INCH POINT OF TANGENCY POINT OF VERTICAL CURVE POINT OF VERTICAL INTERSECTION POINT OF VERTICAL TANGENT PAVEMENT POWER				
CONC CONST CONT COORD CSBC CSTC CULV CU YD	CONCRETE CONSTRUCT CONTINU(E, ED, OUS, ATION) COORDINATE CRUSHED SURFACING BASE COURSE CRUSHED SURFACING TOP COURSE CULVERT CUBIC YARD	QTY R RD REF REINF REQ'D REV RIM RT	QUANTITY RADIUS ROAD, ROADWAY REFERENCE REINFORC(E, ED, ING, MENT) REQUIRED REVISION STRUCTURE RIM ELEVATION RIGHT TURN				
D/W DEF DEG DEMO DIA DIM DIP DR DWG(S)	DRIVEWAY DEFLECTION DEGREE DEMOLISH/DEMOLITION DIAMETER DIMENSION(S) DUCTILE IRON PIPE DRIVE DRAWING(S)	R/W, ROW S SCHED SD, SDMH SE SECT SHT SP	RIGHT OF WAY SOUTH OR SLOPE SCHEDULE STORM DRAIN, STORM DRAIN MANHOLE SOUTHEAST SECTION(S) SHEET SPRINKLER				
E EA ECR EHH EL, ELEV ELEC ENGR EOP EQ EQUIP ESMT	EAST OR ELECTRICAL EACH END CURB RETURN ELECTRICAL HANDHOLE ELEVATION ELECTRIC(AL) ENGINEER EDGE OF PAVEMENT EQUAL(LY) EQUIPMENT	SQ SQ FT SQ IN SS SSMH ST STA STD STRUCT SW SYS	SQUARE SQUARE FEET SQUARE INCH SANITARY SEWER SANITARY SEWER MANHOLE STREET STATION STANDARD STRUCTURE(E, AL) SOUTHWEST SYSTEM				
EVC EX, EXIST EXP FDC FDN FF FG FH FIN	EASEMENT END VERTICAL CURVE EXISTING EXP EXPANSION EXPANSION FIRE DEPARTMENT CONNECTION FOUNDATION FINISH FLOOR FINISH GRADE ELEVATION FIRE HYDRANT FINISH(ED)	T TBD TBM TC TELE TEMP TOW TP, T/P TYP	TELEPHONE OR TELEPHONE VAULT TO BE DETERMINED TEMPORARY BENCH MARK TOP OF CURB ELEVATION TELEPHONE TEMPORARY TOP OF WALL ELEVATION TOP OF PIPE TYPICAL				
FL FT G GALV GRND GV	FIRE LINE/FLANGE FOOT/FEET GAS GALVANIZED GROUND GATE VALVE	UDG VAP VC VERT VOL	UNDERGROUND VERTICAL ANGLE POINT VERTICAL CURVE VERTICAL VOLUME				
HH HORIZ HT IE IN JB, J-BOX JT	HANDHOLE HORIZONTAL HEIGHT INVERT ELEVATION INCH JUNCTION BOX JOINT TRENCH	W W/O WM WV XFMR	WEST, WDTH, WDE OR WATER WITH WITHOUT WATER MAIN OR WILLAMETTE MERIDIAN WATER VALVE TRANSFORMER				
KV KW KWH	KILOVOLTS KILOWATT KILOWATT HOURS						

WASHINO DRKS

CITY OF DEPARTMENT 420 COLLEGE

 \overline{S}

LOT E ACOOM EY, WA

PARKING 8345 STEILA

RAC

NOTES

GENERAL

DESIGNER: K. GANS DRAWN BY: W. HOLM APPROVED BY: W. HOLM

JOB NO:

SEPT. 13, 2023

GN-01

02 of 45

22-000313

DRAWING FILE NO: 22-000313 GN-01

DRAWING NO:

SHEET NO:

CALL BEFORE YOU DIG HE CONTRACTOR SHALL BE FULLY RESPONSIBLE FOR THE LOCATION

AND PROTECTION OF ALL EXISTING UTILITIES. THE CONTRACTOR SHALL VERIFY ALL UTILITY LOCATIONS PRIOR TO CONSTRUCTION BY CALLING THE UNDERGROUND LOCATE LINE AT 811 OR 1.800.424.5555 A MINIMUM OF 48 HOURS PRIOR TO ANY EXCAVATION.

TOPOGRAPHIC SURVEY OF REGIONAL ATHLETIC COMPLEX

EAST $\frac{1}{2}$, SEC. 14, T18N, R1W, W.M.

BASIS OF BEARING

MERIDIAN IS WASHINGTON COORDINATE SYSTEM OF 1983/91 - SOUTH ZONE DERIVED FROM TIES TO HPGN STATIONS SANDERSON, MCKENNA AND CBL1110 AND TO WSDOT GPS STATIONS G259R, GP34005-2, GP34005-4, GP34101-32, GP34101-39, HC34-2, LUHR RM2, TS34-33, TS34-59 AND TO THURSTON COUNTY GPS STATIONS U-531, AT-194, AT-352, AT-355, AT-447, AT449 AND AT-478. DISTANCES SHOWN ARE GROUND SCALE U.S. SURVEY

FEET. COMBINED SCALE FACTOR (GROUND TO GRID)

IS 0.999935701. SURVEY AF# 3111152 DATED 09-24-1997.

METHOD OF SURVEY

SURVEY PERFORMED BY CONVENTIONAL FIELD TRAVERSE USING A LEICA TS-16 (THREE SECOND TOTAL STATION), LINEAR AND ANGULAR CLOSURE OF THE TRAVERSE MEET THE STANDARDS OF WAC 332-130-090.

THE BOUNDARY WAS COMPILED USING PHYSICAL FEATURES TIED IN THE FIELD AND DOCUMENTS OF RECORD AS SHOWN BELOW.

VERTICAL
THE CITY OF LACEY BENCHMARKS ARE BASED ON NGVD 29 DATUM FROM PRIMARY CONTROL ESTABLISHED BY FEDERAL AND STATE AGENCIES TO FIRST OR SECOND ORDER ACCURACY. THE CITY OF LACEY'S BENCHMARKS ARE GENERALLY TO THIRD ORDER ACCURACY.

> 2" SURFACE MONUMENT AT THE C/L OF VINE MAPLE DR SE, 80' +/- SOUTH OF STEILACOOM RD SE


SOURCE OF CONTOURS COMPILE FIELD MEASUREMENTS USING

SOURCE OF UTILITY MARKINGS SURFACE MARKINGS PROVIDED BY UTILITY NOTIFICATION CENTER (callbeforeyoudig.org) TICKET # 21189894

FIELD SURVEYOR & FIELD BOOK MIKE BREDESON & 256



CONCRETE

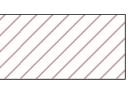

BUILDING





ASPHALT

CITY OF LACEY BM#993

ELEV.=218.711'

AUTOCAD CIVIL 3D-2020

"COMMUNICATION UTILITY WAS NOT PROPERLY MARKED IN FIELD"



GRAVEL



SURVEY SYMBOL LEGEND

BARB WIRE FENCE

————— CHAIN LINK FENCE

CONCRETE FENCE

-XXX-XXX-XXX-XXX-XXX-WIRE FENCE

TOE OF SLOPE

SEWER (PAINTED)

OVERHEAD CABLE

OVERHEAD FIBER OPTIC

OVERHEAD ELECTRIC UNDERGROUND ELECTRIC (PAINTED)

RECLAIMED WATER (PAINTED)

UNDERGROUND CABLE (PAINTED)

UNDER GROUND PHONE (PAINTED)

UNDERGROUND FIBER OPTIC (PAINTED)

GAS (PAINTED) OVERHEAD PHONE

\oplus	Axle	å		Bike Symbol
0	Brass Disk	رياني ا	. 1	Handicap
0	Boatspike		ı	Left turn
0	Cased Monument	M	(Only Text
•	Concrete Monument		. 1	Parallel Park End
\boxtimes	Hub & Tack	+	•	Parallel Park Tic
₽	Iron Pipe	×	ı	Railroad Crossing
*	Magnail w/ flasher	7	1	Right turn
₩	Magnail		,	Straight Thru
©	PKnail w/flasher	4		Straight Thru and Left Turn
X	PKnail		> ;	Straight thru and Right Turn
0	Rebar no/cap		3	Catch Basin
•	1/2" or #4 Rebar w/cap			Catch Basin w/EJIW inlet
•	5/8" or #5 Rebar w/cap	× culve	7 (Culvert
•	Railroad Spike	°C() 5	Storm C/O
X	Scribe	6) { D	Storm Manhole
♦	Traverse Point	SI	,	Storm Strip Drain
NSR	Non Standard Curb Return	(3)	Lift Station
	Truncated Domes	ဇင	0	Sewer C/O
		6		Sewer Manhole

□S	Sewer Mete
(P)	Sewer Pum
XS	Sewer Valve
ово	Blowoff
o BO	Blowoff-Rec
Ħ	Hydrant
\$\tag{\tag{\tag{h}}}	Hydrant-Red
XIR	Irrigation Va
IR RW	Irrigation Va
K	Post Indicat
\bowtie	Sampling St
RW KX	Sampling St
□ SP	Sprinkler he
□ RW SP	Sprinkler he
රු	Water Air R
\bigcirc_{W}	Water Manh
RW O	Water Manh

□S	Sewer Meter	
(P)	Sewer Pump	
⊠S	Sewer Valve	
ово	Blowoff	
o BO RW	Blowoff-Reclaimed	7
\mathcal{A}	Hydrant	
\$	Hydrant-Reclaimed	7
XIR	Irrigation Valve	
IR X RW	Irrigation Valve-Reclaimed	7
R	Post Indicator Valve	
\bowtie	Sampling Station	
RW KX	Sampling Station-Reclaimed	
□ SP	Sprinkler head	
□ RW SP	Sprinkler head-Reclaimed	
රු	Water Air Release	
\bigcirc_{W}	Water Manhole	
RW O W	Water Manhole-Reclaimed	
ωW	Water Meter	7

□RW Water Meter-Reclaimed

Ô	Reduce Pressure Backflow Assem.
+ws	Water Service
+ _{ws}	Water Service-Reclaimed
Â	Water Tank
₩	Water Valve
R ₩	Water Valve-Reclaimed
□w	Water Vault
□ _{RW}	Water Vault-Reclaimed
WELL ⊙	Well
\downarrow	Anchor
₩	Basketball Hoop
	BBQ
⊕	Bollard
H	Dumpster
0	Filler Cap
 	Flag Pole
O_{G}	Gas Manhole
⊠G	Gas Meter
	Gaspump
₩G	Gas Vavle

		Cidio
	-G₽	Guy Pole
eclaimed	P	Headstone
	□J	Junction Box typ
	121 /	Junction Box typ
laimed	3 √	Junction Box ty
	ж-•	Light Pole
aimed	0	Light Standard
	Ж	Luminaire
	P	Mailbox
	⊙ PS	Pedestrain Hea
	\oplus	Pile
	▦	Pinic Table
	0	Pole
	□	Post
	□Р	Power Meter
	-O _E	Power Pole
	–⊗ _F	Power Pole w/di
	► ⊗	Power Pole w/Li

□_P Power Vault


	Guy Pole		\bigcirc	Rock
	Headstone		SD	Service Disconnect
,	Junction Box type 1		–§√	Service Pole
,	Junction Box type 2		ட	Sign
	Junction Box type 3			Sign (Large)
•	Light Pole		□sig	Signal Control Cabinet
	Light Standard			Signal Pole
	Luminaire		Ì	Street Light
	Mailbox		T	Telehone Booth
•	Pedestrain Head		O_{T}	Telephone Manhole
	Pile		□Т	Telephone Pedestal
	Pinic Table		□т	Telephone Vault
	Pole			Trash Can
	Post		□т∨	TV Pedestal
,	Power Meter		⊸ū	Utility Pole
	Power Pole		Ж	Yard Light
	Power Pole w/drop		റ്റ് RW	Water Air Release-Reclaimed
	Power Pole w/Luminaire		oxdot	Tree Grate
		ıI		

O PVC Pipe


0	Rock	*	Birch Tree
SD	Service Disconnect		Cedar Tree
~§√	Service Pole	₿	Cherry Tree
-	Sign	**	Conifer Tree
	Sign (Large)	\odot	Cottonwood T
□sic	Signal Control Cabinet	\Box	Deciduous Tr
	Signal Pole	兴	Fir Tree
Î	Street Light	₩	Fruit Tree
T	Telehone Booth	٥	Hemlock tree
O _T	Telephone Manhole	*	Holly Tree
ПΤ	Telephone Pedestal	*	Madrona Tree
□т	Telephone Vault	0	Maple Tree
0	Trash Can	0	Oak Tree
□т∨	TV Pedestal	卷	Pine Tree
⊸ū	Utility Pole	*	Poplar Tree
Ж	Yard Light	•	Spruce Tree
مہ	Water Air Balance Bealaimed	Æ.	Willow Troo

·	**	Conifer Tree
	\odot	Cottonwood Tree
	\bigcirc	Deciduous Tree
	兴	Fir Tree
	**	Fruit Tree
	0	Hemlock tree
	*	Holly Tree
	*	Madrona Tree
	0	Maple Tree
	0	Oak Tree
	卷	Pine Tree
	*	Poplar Tree
	•	Spruce Tree
	4	Willow Tree
	()	Bush
	Я	Stump

Alder Tree

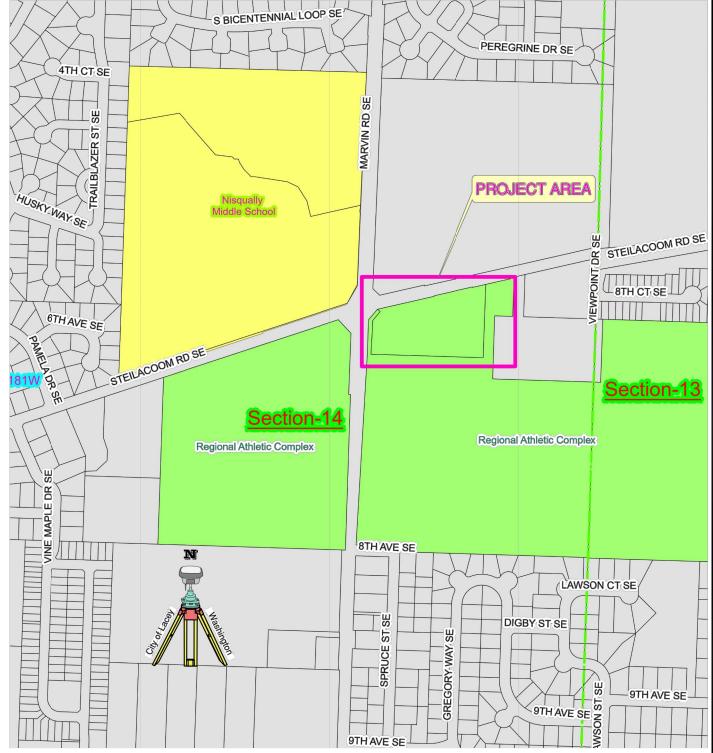

DATE OF SURVEY 06/2021

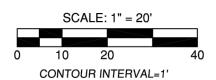

PURPOSE OF TOPOGRAPHIC SURVEY: TO PROVIDE CITY OF LACEY ENGINEERS TOPOGRAPHIC INFORMATION FOR A PROPOSED PARKING LOT.

NOTE:
The Topographic Survey depicts the physical features that were visible at the time of the survey. The City of Lacey is not responsible for the location of underground utilities that are marked or not marked in the field by other utility providers. All feature locations should be independently verified prior to design or construction.

CITY OF LACEY, WASHINGTON DEPARTMENT OF PUBLIC WORKS

420 COLLEGE STREET S.E. 98503 (360) 491-5600




DATE: 06-07-2021 DRAFTED:MKB CHECKED: M. BREDESON SCALE: 1"=20' AREA OF WORK: SEC. 14, T18N, R1W, W.M.


FILE: RAC TOPO 06-2021.dwg




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	DATE	DESCRIPTION	DWG. NO
			EX-01
_			LX-01
			3 of 44
			3 01 44



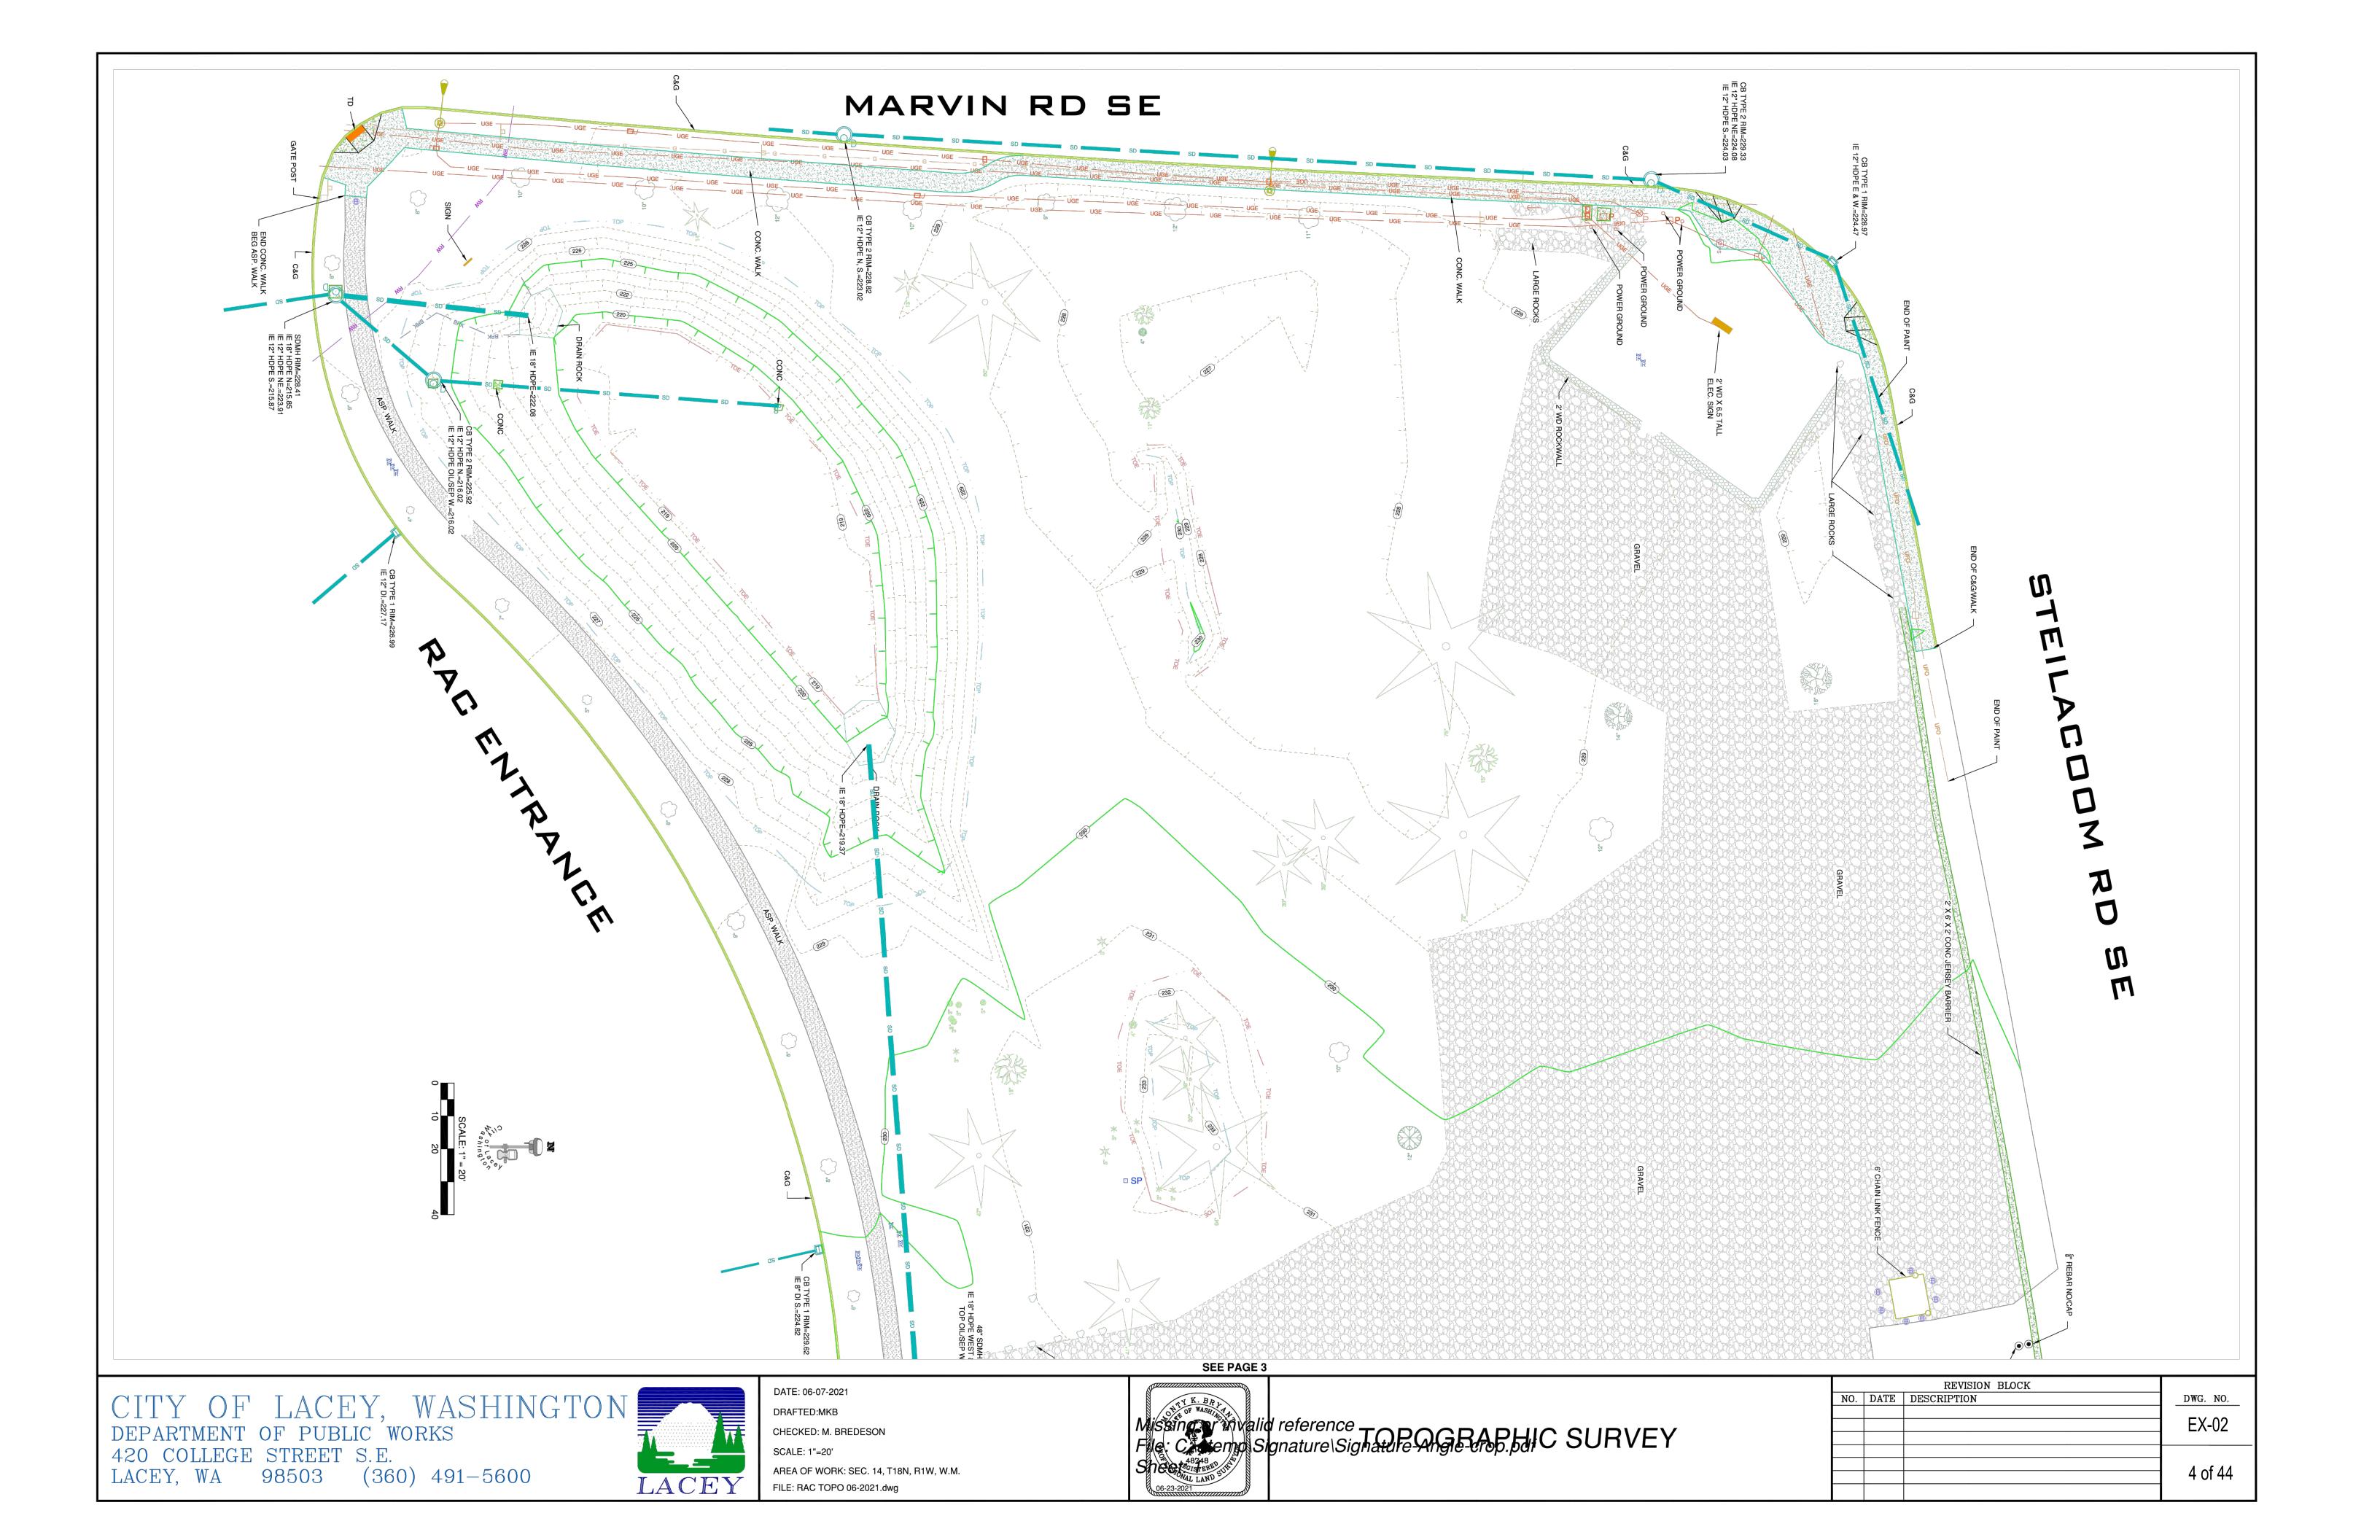

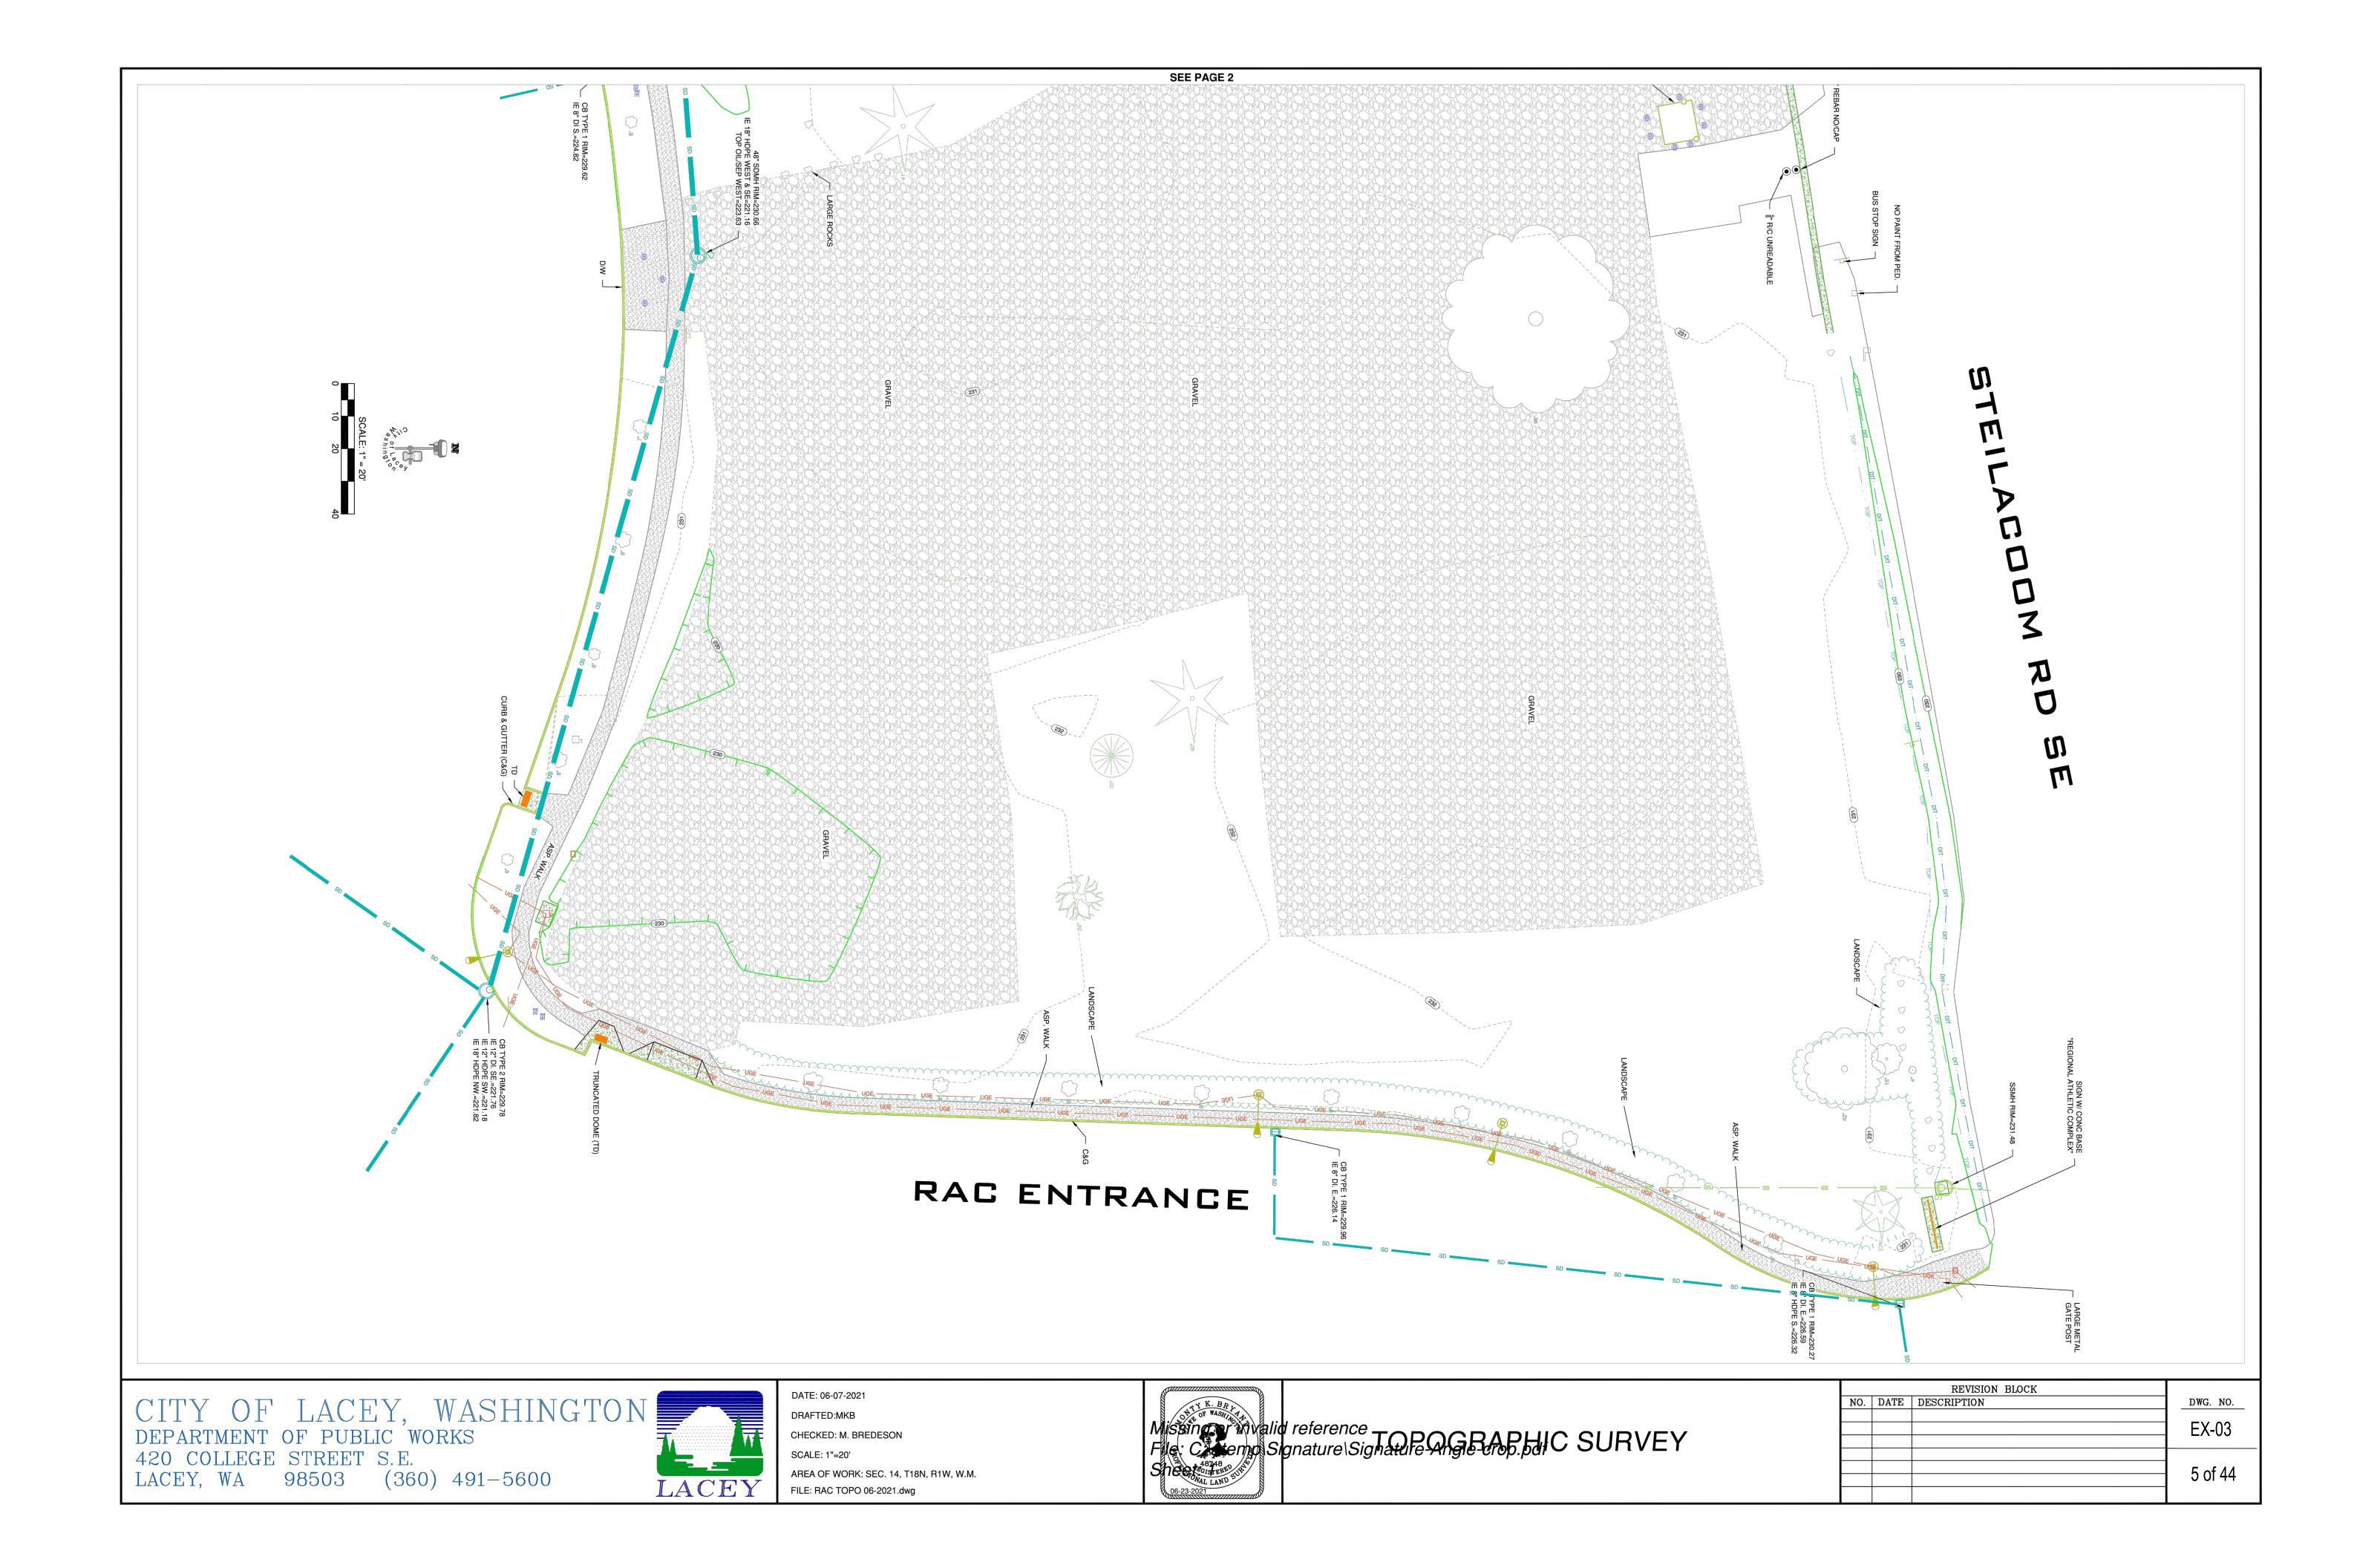

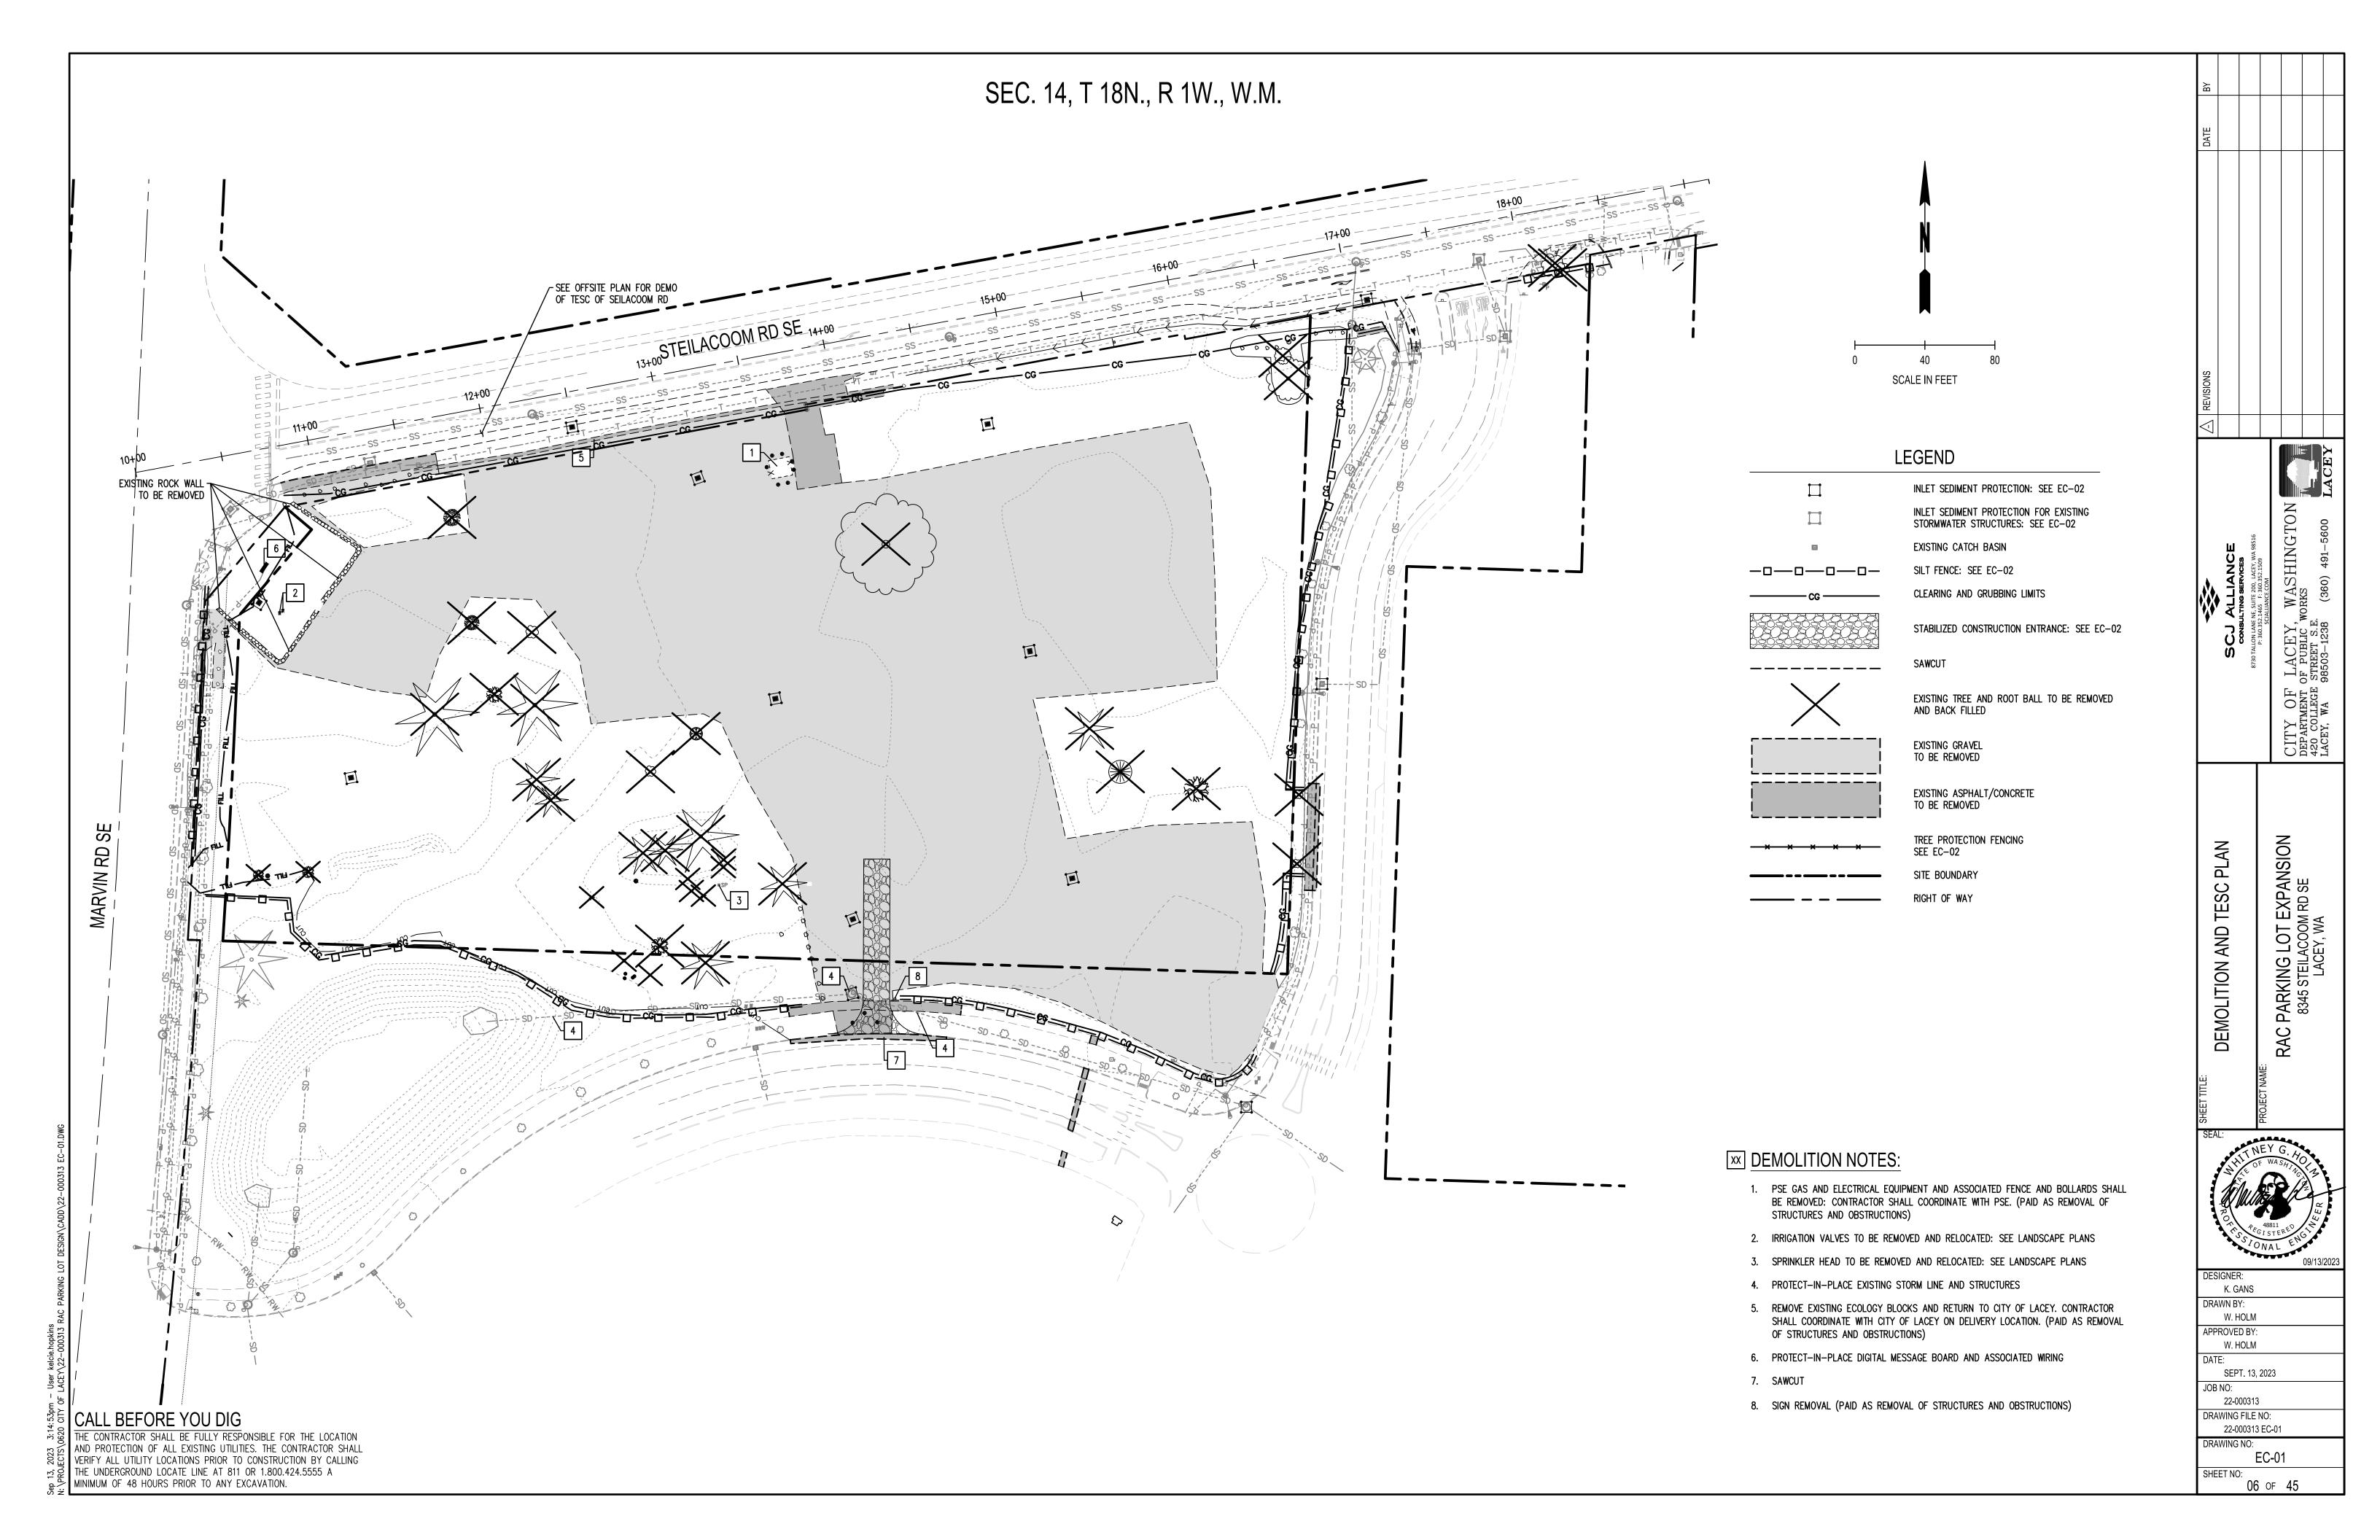CITY OF LACEY STANDARD EROSION CONTROL NOTES

- A CERTIFIED EROSION AND SEDIMENT CONTROL LEAD (CESCL) IS REQUIRED FOR ALL CONSTRUCTION PROJECTS. THE NAMED PERSON OR FIRM SHALL BE ON-SITE OR ON-CALL AT ALL TIMES. FOR THIS SITE, THE PERSON/FIRM IS ___ AND THEIR TELEPHONE NUMBERS ARE:
- (OFFICE:) ______ (CELL:)___
- APPROVAL OF THIS EROSION & SEDIMENT CONTROL (ESC) PLAN DOES NOT CONSTITUTE AN APPROVAL OF PERMANENT ROAD OR DRAINAGE DESIGN (E.G. SIZE AND LOCATION OF ROADS, PIPES, RESTRICTORS, CHANNELS, RETENTION FACILITIES, UTILITIES, ETC.).
- THE IMPLEMENTATION OF THESE ESC PLANS AND THE CONSTRUCTION, MAINTENANCE, REPLACEMENT, AND UPGRADING OF THESE ESC FACILITIES IS THE RESPONSIBILITY OF THE APPLICANT/CONTRACTOR UNTIL ALL CONSTRUCTION IS COMPLETED AND APPROVED AND VEGETATION/LANDSCAPING IS ESTABLISHED.
- · THE CLEARING LIMIT BOUNDARIES SHOWN ON THIS PLAN SHALL BE CLEARLY FLAGGED IN THE FIELD PRIOR TO CONSTRUCTION. DURING THE CONSTRUCTION PERIOD, NO DISTURBANCE BEYOND THE FLAGGED CLEARING LIMITS SHALL BE PERMITTED. THE FLAGGING SHALL BE MAINTAINED BY THE APPLICANT/CONTRACTOR FOR THE DURATION OF
- THE ESC FACILITIES SHOWN ON THIS PLAN MUST BE CONSTRUCTED IN CONJUNCTION WITH ALL CLEARING AND GRADING ACTIVITIES, AND IN SUCH A MANNER AS TO ENSURE THAT SEDIMENT AND SEDIMENT-LADEN WATER DO NOT ENTER THE DRAINAGE SYSTEM, ROADWAYS, OR VIOLATE APPLICABLE SURFACE WATER, GROUND WATER, OR DISCHARGE STANDARDS.
- THE ESC FACILITIES SHOWN ON THIS PLAN ARE THE MINIMUM REQUIREMENTS FOR ANTICIPATED SITE CONDITIONS. DURING THE CONSTRUCTION PERIOD, THESE ESC FACILITIES SHALL BE UPGRADED AS NEEDED FOR UNEXPECTED STORM EVENTS AND TO ENSURE THAT SEDIMENT AND SEDIMENT-LADEN WATER DO NOT LEAVE THE SITE.
- THE ESC FACILITIES ON ACTIVE SITES SHALL BE INSPECTED DAILY BY THE APPLICANT/CONTRACTOR—AND MAINTAINED, REPAIRED, OR AUGMENTED AS NECESSARY—TO ENSURE THEIR CONTINUED FUNCTIONING.
- · THE ESC FACILITIES ON INACTIVE SITES SHALL BE INSPECTED MONTHLY AND WITHIN 48 HOURS FOLLOWING A MAJOR STORM EVENT (≥1"RAINFALL IN 24 HOURS) BY THE APPLICANT/CONTRACTOR —AND MAINTAINED, REPAIRED, OR AUGMENTED AS NECESSARY —TO ENSURE THEIR CONTINUED FUNCTIONING. STORM DRAIN INLETS OPERABLE DURING CONSTRUCTION SHALL BE PROTECTED SO THAT STORMWATER RUNOFF DOES NOT ENTER THE CONVEYANCE SYSTEM WITHOUT FIRST BEING FILTERED OR TREATED TO REMOVE SEDIMENT. AT NO TIME SHALL MORE THAN 1 FOOT OR 1/3 OF THE SUMP VOLUME (WHICHEVER IS LESS) OF SEDIMENT BE ALLOWED TO ACCUMULATE WITHIN A CATCH BASIN. ALL CATCH BASINS AND CONVEYANCE LINES SHALL BE CLEANED PRIOR TO PROJECT COMPLETION AND ACCEPTANCE. THE CLEANING OPERATION SHALL NOT FLUSH SEDIMENT-LADEN WATER OFFSITE WITHOUT TREATMENT.
- STABILIZED CONSTRUCTION ENTRANCES SHALL BE INSTALLED AT THE BEGINNING OF CONSTRUCTION AND MAINTAINED FOR THE DURATION OF THE PROJECT. ADDITIONAL MEASURES MAY BE REQUIRED TO ENSURE THAT ALL PAVED AREAS ARE KEPT CLEAN FOR THE DURATION OF THE PROJECT.
- ROADS SHALL BE CLEANED THOROUGHLY AS NEEDED TO PROTECT DOWNSTREAM WATER RESOURCES OR STORMWATER INFRASTRUCTURE. SEDIMENT SHALL BE REMOVED FROM ROADS BY SHOVELING OR PICKUP SWEEPING AND SHALL BE TRANSPORTED TO A CONTROLLED SEDIMENT DISPOSAL AREA.
- FROM OCTOBER 1 THROUGH APRIL 30, NO SOILS SHALL REMAIN EXPOSED AND UNWORKED FOR MORE THAN 2 DAYS. FROM MAY 1 TO SEPTEMBER 30, NO SOILS SHALL REMAIN EXPOSED AND UNWORKED FOR MORE THAN 7 DAYS. SOILS SHALL BE STABILIZED AT THE END OF THE SHIFT BEFORE A HOLIDAY OR WEEKEND IF NEEDED BASED ON THE WEATHER FORECAST. LINEAR CONSTRUCTION ACTIVITIES, SUCH AS RIGHT-OF-WAY AND EASEMENT CLEARING, ROADWAY DEVELOPMENT, PIPELINES, AND TRENCHING FOR UTILITIES, SHALL COMPLY WITH THESE REQUIREMENTS. THESE STABILIZATION REQUIREMENTS APPLY TO ALL SOILS ON SITE, WHETHER AT FINAL GRADE OR NOT. THE LOCAL PERMITTING AUTHORITY MAY ADJUST THESE TIME LIMITS IF IT CAN BE SHOWN THAT A DEVELOPMENT SITE'S EROSION OR RUNOFF POTENTIAL JUSTIFIES A DIFFERENT STANDARD.
- FROM OCTOBER 1 THROUGH APRIL 30, CLEARING, GRADING, AND OTHER SOIL—DISTURBING ACTIVITIES SHALL ONLY BE PERMITTED IF SHOWN TO THE SATISFACTION OF THE LOCAL PERMITTING AUTHORITY THAT THE TRANSPORT OF SEDIMENT FROM THE CONSTRUCTION SITE TO RECEIVING WATERS WILL BE PREVENTED.


- · SOIL STOCKPILES MUST BE STABILIZED AND PROTECTED WITH SEDIMENT-TRAPPING MEASURES.
- ALL POLLUTANTS, INCLUDING WASTE MATERIALS AND DEMOLITION DEBRIS, THAT OCCUR ON SITE DURING CONSTRUCTION SHALL BE HANDLED AND DISPOSED OF IN A MANNER THAT DOES NOT CAUSE CONTAMINATION OF STORMWATER. WOODY DEBRIS MAY BE CHOPPED AND SPREAD ON SITE.
- MAINTENANCE AND REPAIR OF HEAVY EQUIPMENT AND VEHICLES AND OTHER ACTIVITIES WHICH MAY RESULT IN DISCHARGE OR SPILLAGE OF POLLUTANTS TO THE GROUND OR INTO STORMWATER RUNOFF MUST BE CONDUCTED USING SPILL PREVENTION MEASURES, SUCH AS DRIP PANS. REPORT ALL SPILLS TO 911.
- WATER FROM MOST DEWATERING OPERATIONS SHALL BE DISCHARGED INTO A SEDIMENT TRAP OR POND. CLEAN. NON-TURBID WATER MAY BE DISCHARGED TO STATE SURFACE WATERS, PROVIDED THE DISCHARGE DOES NOT CAUSE EROSION OR FLOODING. HIGHLY TURBID OR CONTAMINATED DEWATERING WATER FROM CONSTRUCTION EQUIPMENT OPERATION, CLAMSHELL DIGGING, CONCRETE TREMIE POUR, OR WORK INSIDE A COFFERDAM SHALL BE HANDLED SEPARATELY FROM STORMWATER AND PROPERLY DISPOSED.

CITY OF LACEY SILT FENCE NOTES

- 1. FILTER FABRIC SHALL BE PURCHASED IN A CONTINUOUS ROLL CUT TO THE LENGTH OF THE BARRIER TO AVOID USE OF JOINTS. WHEN JOINTS ARE NECESSARY, FILTER CLOTH SHALL BE SPLICED TOGETHER ONLY AT A SUPPORT POST, WITH A MINIMUM 6-INCH OVERLAP, AND SECURELY FASTENED AT BOTH ENDS TO POST.
- 2. POSTS SHALL BE SPACED A MAXIMUM OF 6 FEET APART AND DRIVEN SECURELY INTO THE GROUND (MINIMUM OF 30 INCHES).
- 3. A TRENCH SHALL BE EXCAVATED APPROXIMATELY 8 INCHES WIDE AND 12 INCHES DEEP ALONG THE LINE OF POSTS AND UPSLOPE FROM THE BARRIER.
- 4. WHEN STANDARD STRENGTH FILTER FABRIC IS USED, A WIRE MESH SUPPORT FENCE SHALL BE FASTENED SECURELY TO THE WHEN STANDARD STRENGTH FILTER FABRIC IS USED. A WIRE MESH SUPPORT FENCE SHALL BE FASTENED SECURELY TO THE UPSLOPE SIDE OF THE POSTS USING HEAVY—DUTY WIRE STAPLES AT LEAST 1 INCH LONG, TIE WIRES OR HOG RINGS. THE WIRE SHALL EXTEND INTO THE TRENCH A MINIMUM OF 4 INCHES AND SHALL NOT EXTEND MORE THAN 36 INCHES ABOVE THE ORIGINAL GROUND SURFACE.
- 5. THE STANDARD STRENGTH FILTER FABRIC SHALL BE STAPLED OR WIRED TO THE FENCE, AND 20 INCHES OF THE FABRIC SHALL BE EXTRNDED INTO THE TRENCH. THE FABRIC SHALL NOT EXTEND MORE THAN 36 INCHES ABOVE THE ORIGINAL GROUND SURFACE. FILTER FABRIC SHALL NOT BE STAPLED TO EXISTING TREES.
- 6. WHEN EXTRA-STRENGTH FILTER FABRIC AND CLOSER POST SPACING IS USED, THE WIRE MESH SUPPORT FENCE MAY BE ELIMINATED. IN SUCH A CASE, THE FILTER FABRIC IS STAPLED OR WIRED DIRECTLY TO THE POSTS WITH ALL OTHER PROVISIONS OF ABOVE NOTES APPLYING.
- 7. FILTER FABRIC FENCES SHALL NOT BE REMOVED BEFORE THE UPSLOPE AREA HAS BEEN PERMANENTLY STABILIZED.
- 8. FILTER FABRIC FENCES SHALL BE INSPECTED IMMEDIATELY AFTER EACH RAINFALL AND AT LEAST DAILY DURING PROLONGED RAINFALL. ANY REQUIRED REPAIRS SHALL BE MADE IMMEDIATELY.

CITY OF LACEY INLET PROTECTION NOTES

- 1. PLACE CONCRETE BLOCKS LENGTHWISE ON THEIR SIDES IN A SINGLE ROW AROUND THE PRIMETER OF THE INLET, SO THAT THE OPEN ENDS FACE OUTWARD, NOT UPWARD. THE ENDS OF ADJACENT BLOCKS SHALL ABUT. THE HEIGHT OF THE BARRIER CAN BE VARIED, DEPENDING ON DESIGN NEEDS, BY STACKING COMBINATIONS OF BLOCKS THAT ARE 4 INCHES, AND 12 INCHES WIDE, THE ROW OF BLOCKS SHALL BE AT LEAST 12 INCHES BUT NO GREATER THAN 24 INCHES HIGH.
- 2. PLACE WIRE MESH OVER THE OUTSIDE VERTICAL FACE (OPEN END) OF THE CONCRETE BLOCKS TO PREVENT STONE FROM BEING WASHED THROUGH THE BLOCKS. USE HARDWARE CLOTH OR COMPARABLE WIRE MESH WITH 1/2-INCH OPENINGS.
- 3. PILE STONE AGAINST THE WIRE MESH TO THE TOP OF THE BLOCKS. USE 3/4-TO 3-INCH GRAVEL.
- 4. PLACE WIRE MESH OVER THE DROP INLET SO THAT THE WIRE EXTENDS A MINIMUM OF 1 FT BEYOND EACH SIDE OF THE INLET STRUCTURE. USE HARDWARE CLOTH OR COMPARABLE WIRE MESH WITH 1/2-INCH OPENINGS. IF MORE THAN ONE STRIP OF MESH IS NECESSARY, OVERLAP THE STRIPS. PLACE FILTER FABRIC OVER WIRE MESH.
- 5. PLACE 3/4-INCH GRAVEL OVER THE WIRE MESH. THE DEPTH OF STONE SHALL BE AT LEAST 12 INCHES OVER THE ENTIRE INLET OPENING. EXTEND THE STONE BEYOND THE INLET OPENING AT LEAST 18 INCHES ON ALL SIDES.
- 6. IF THE STONE FILTER BECOMES CLOGGED WITH SEDIMENT, THE STONES MUST BE PULLED AWAY FROM THE INLET AND CLEANED OR REPLACED.

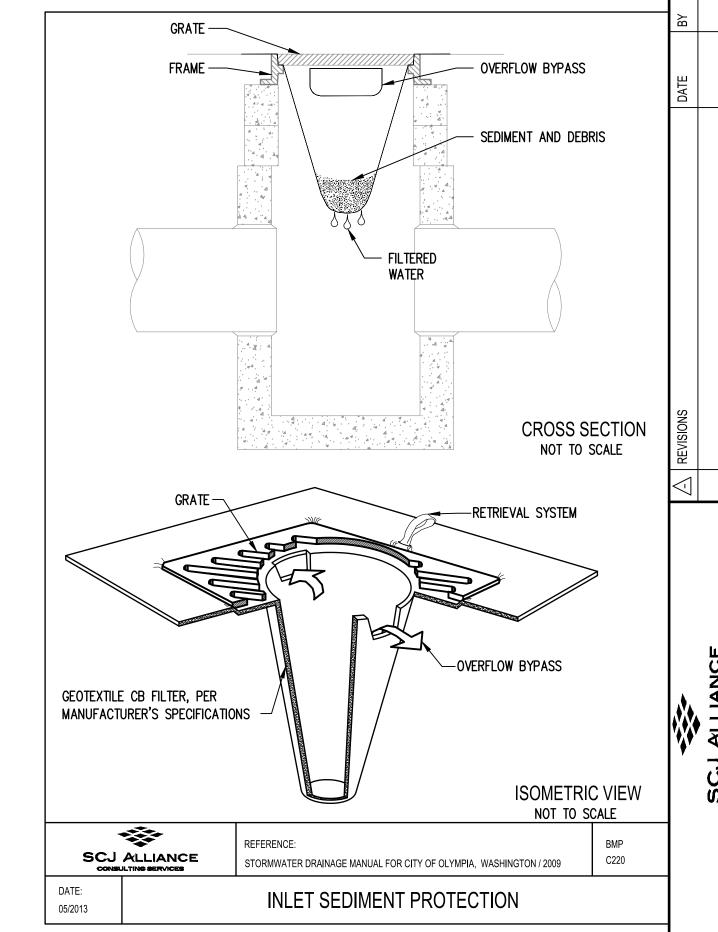



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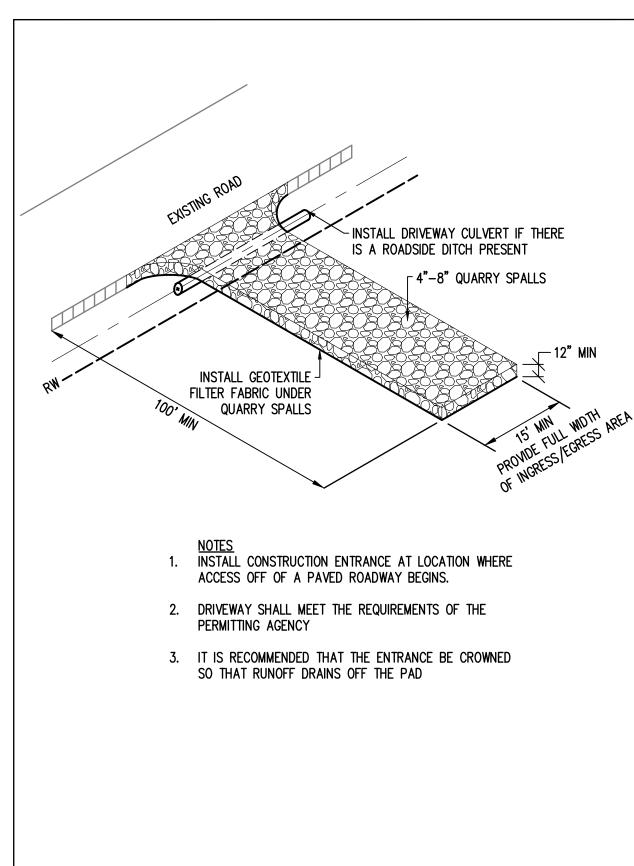
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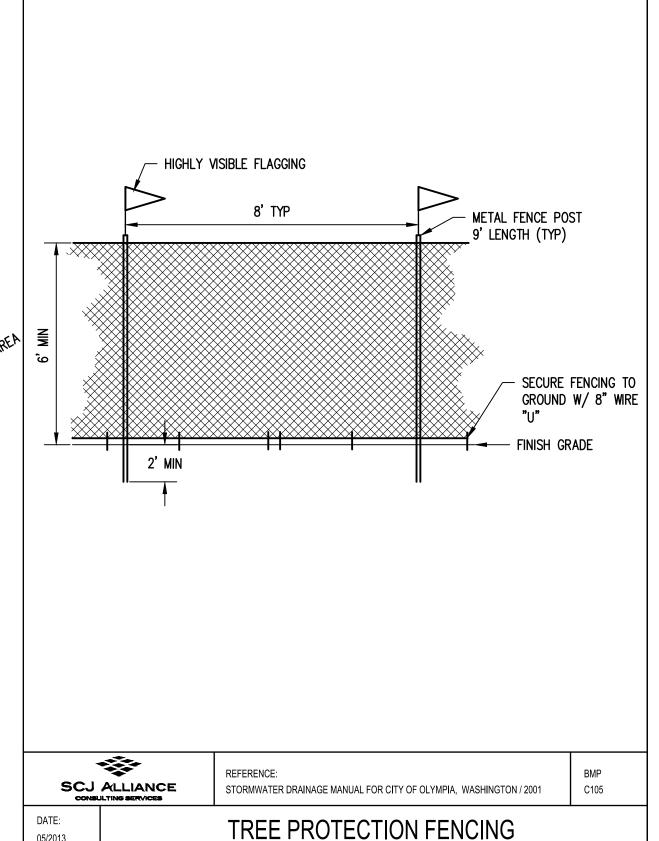
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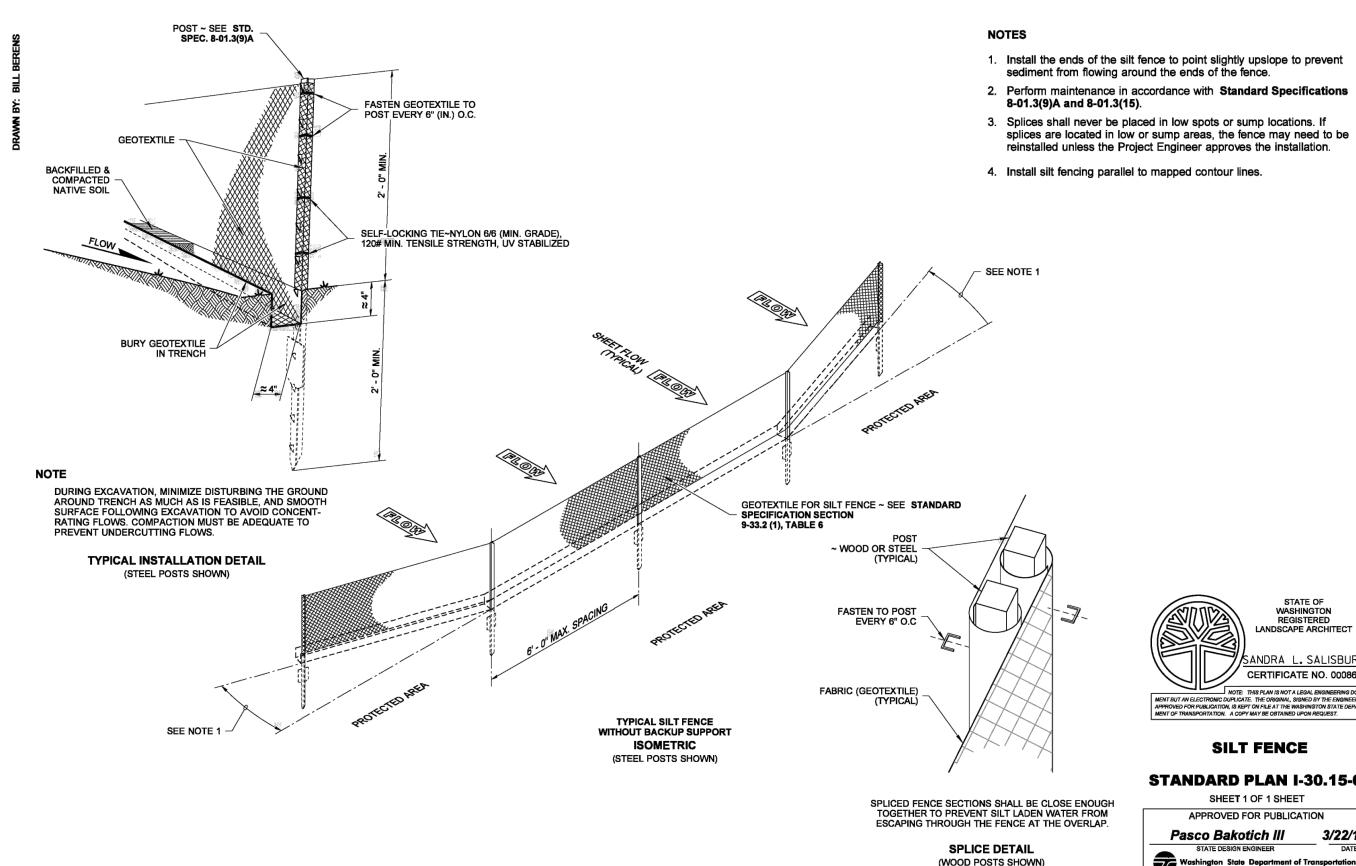
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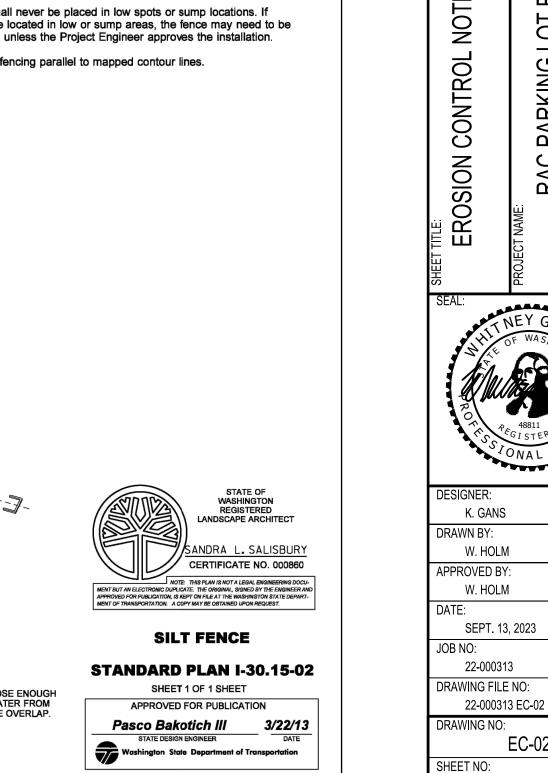



STABILIZED CONSTRUCTION ENTRANCE

05/2013








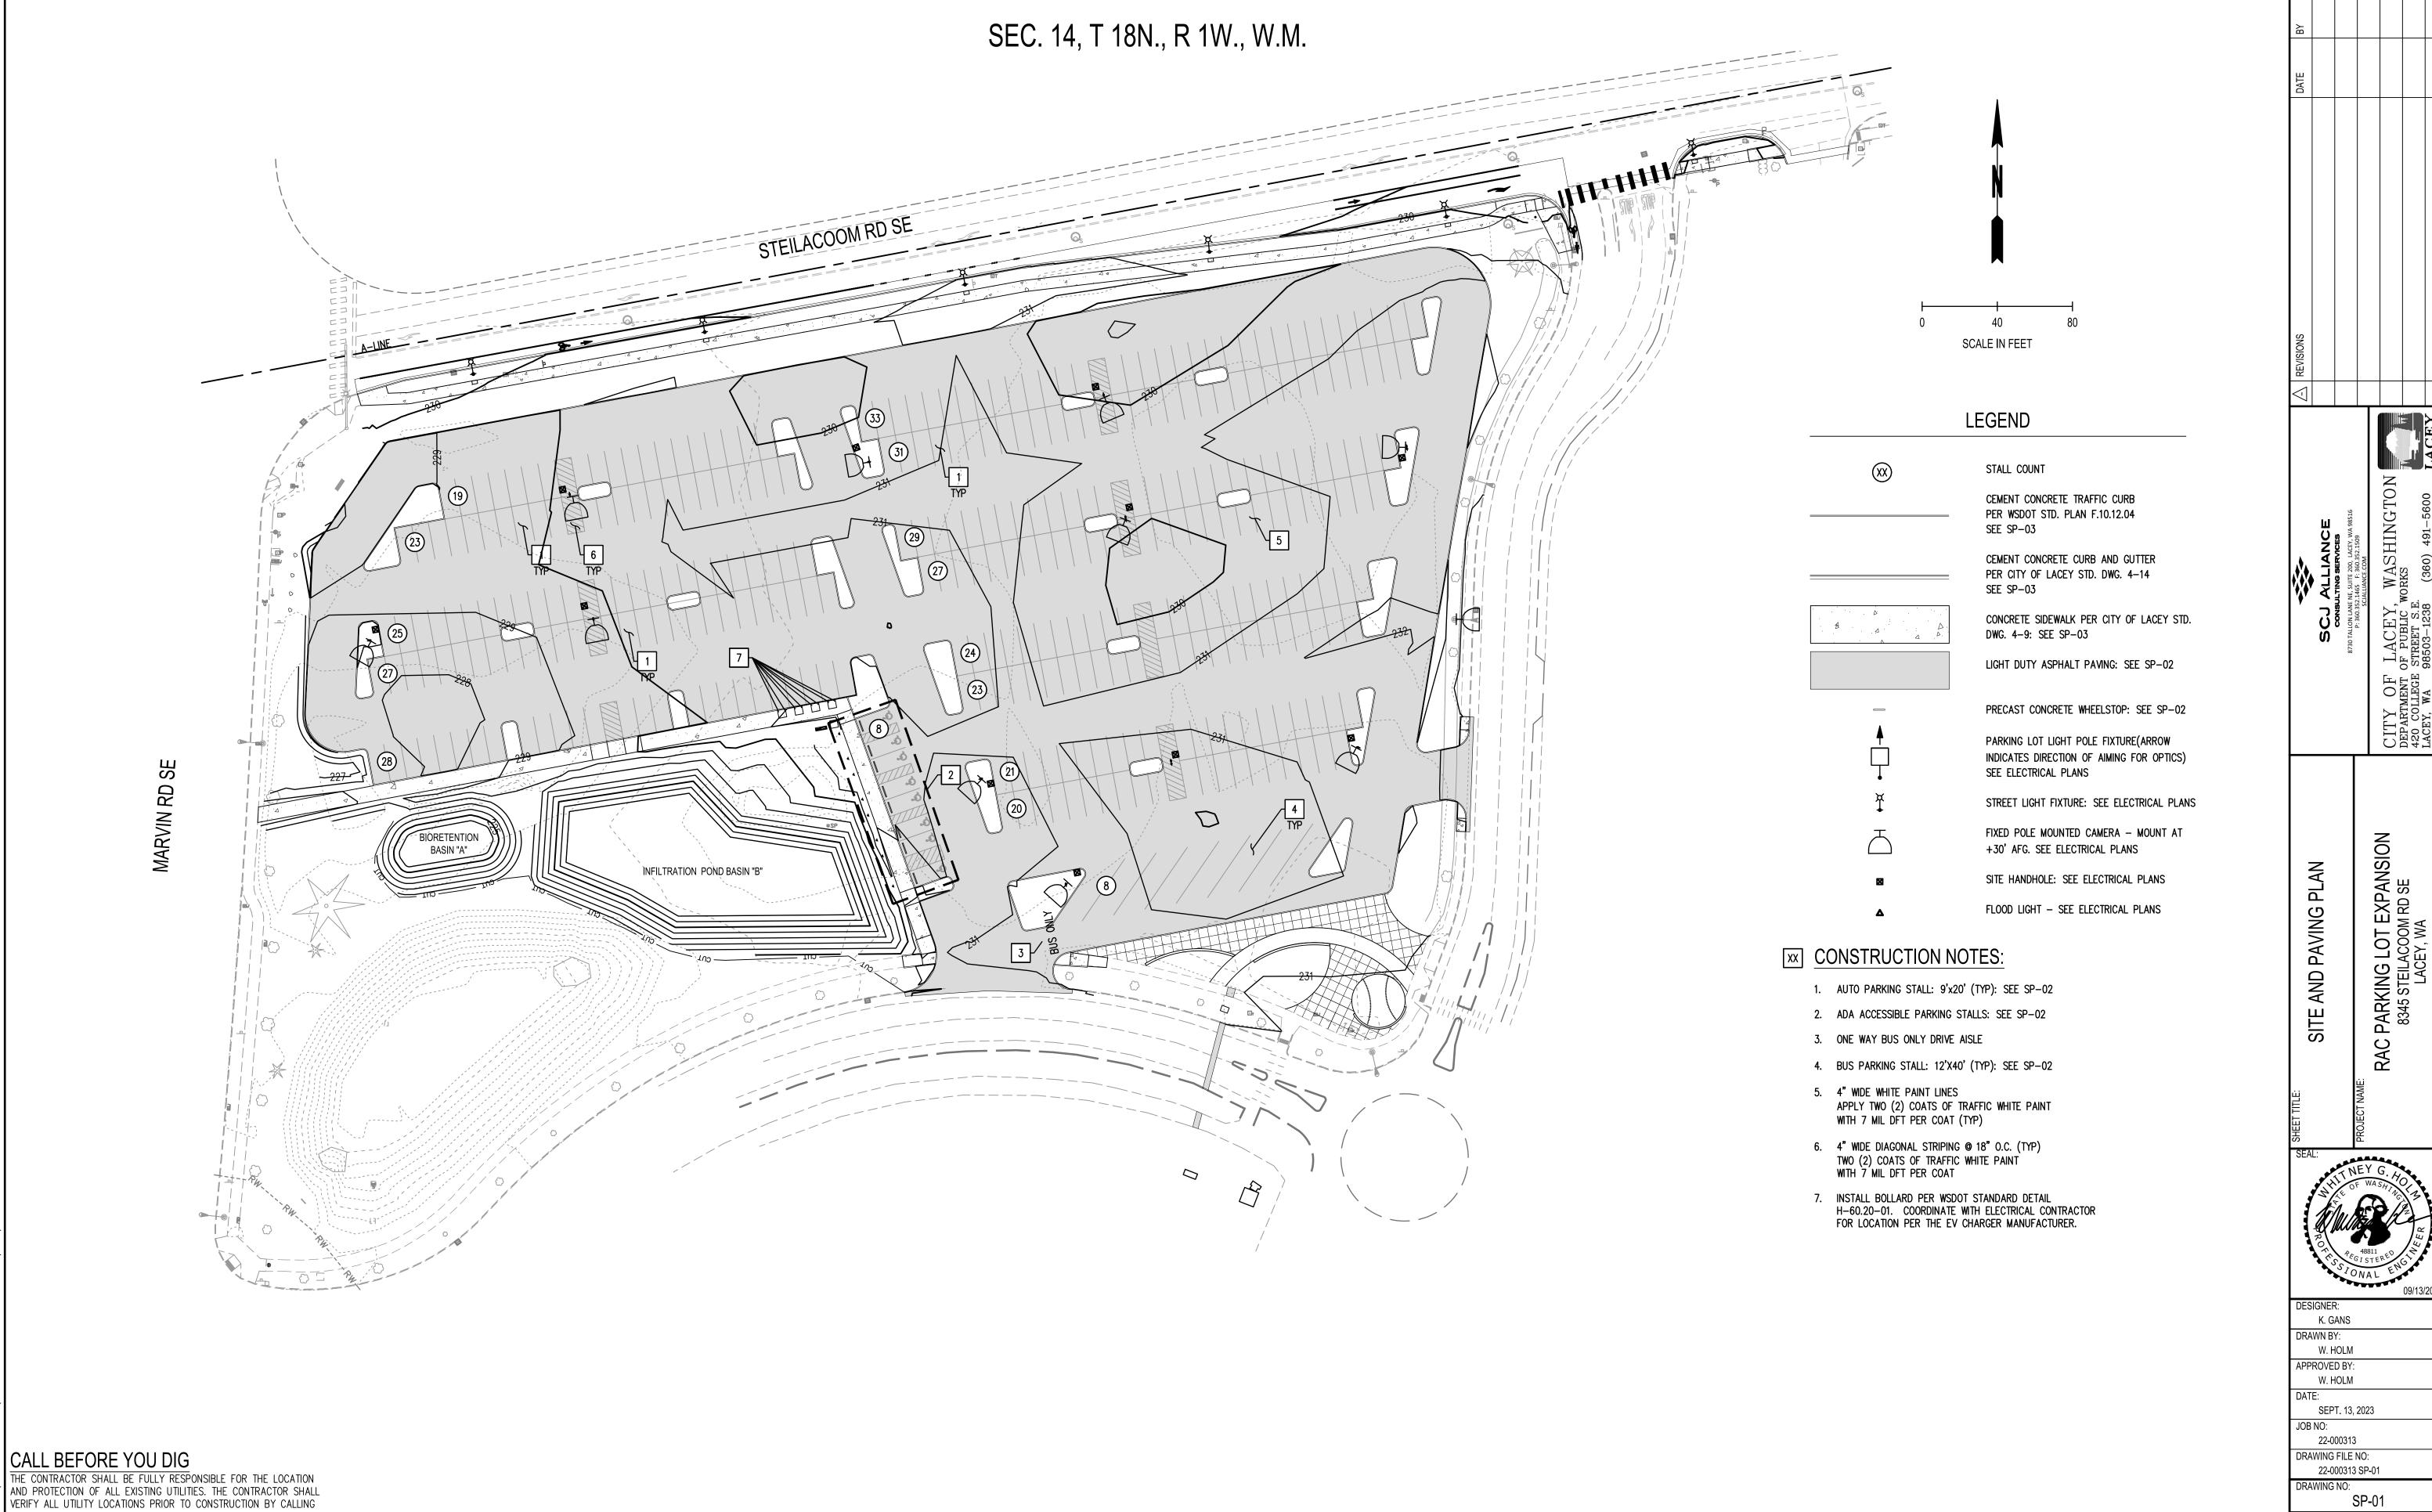


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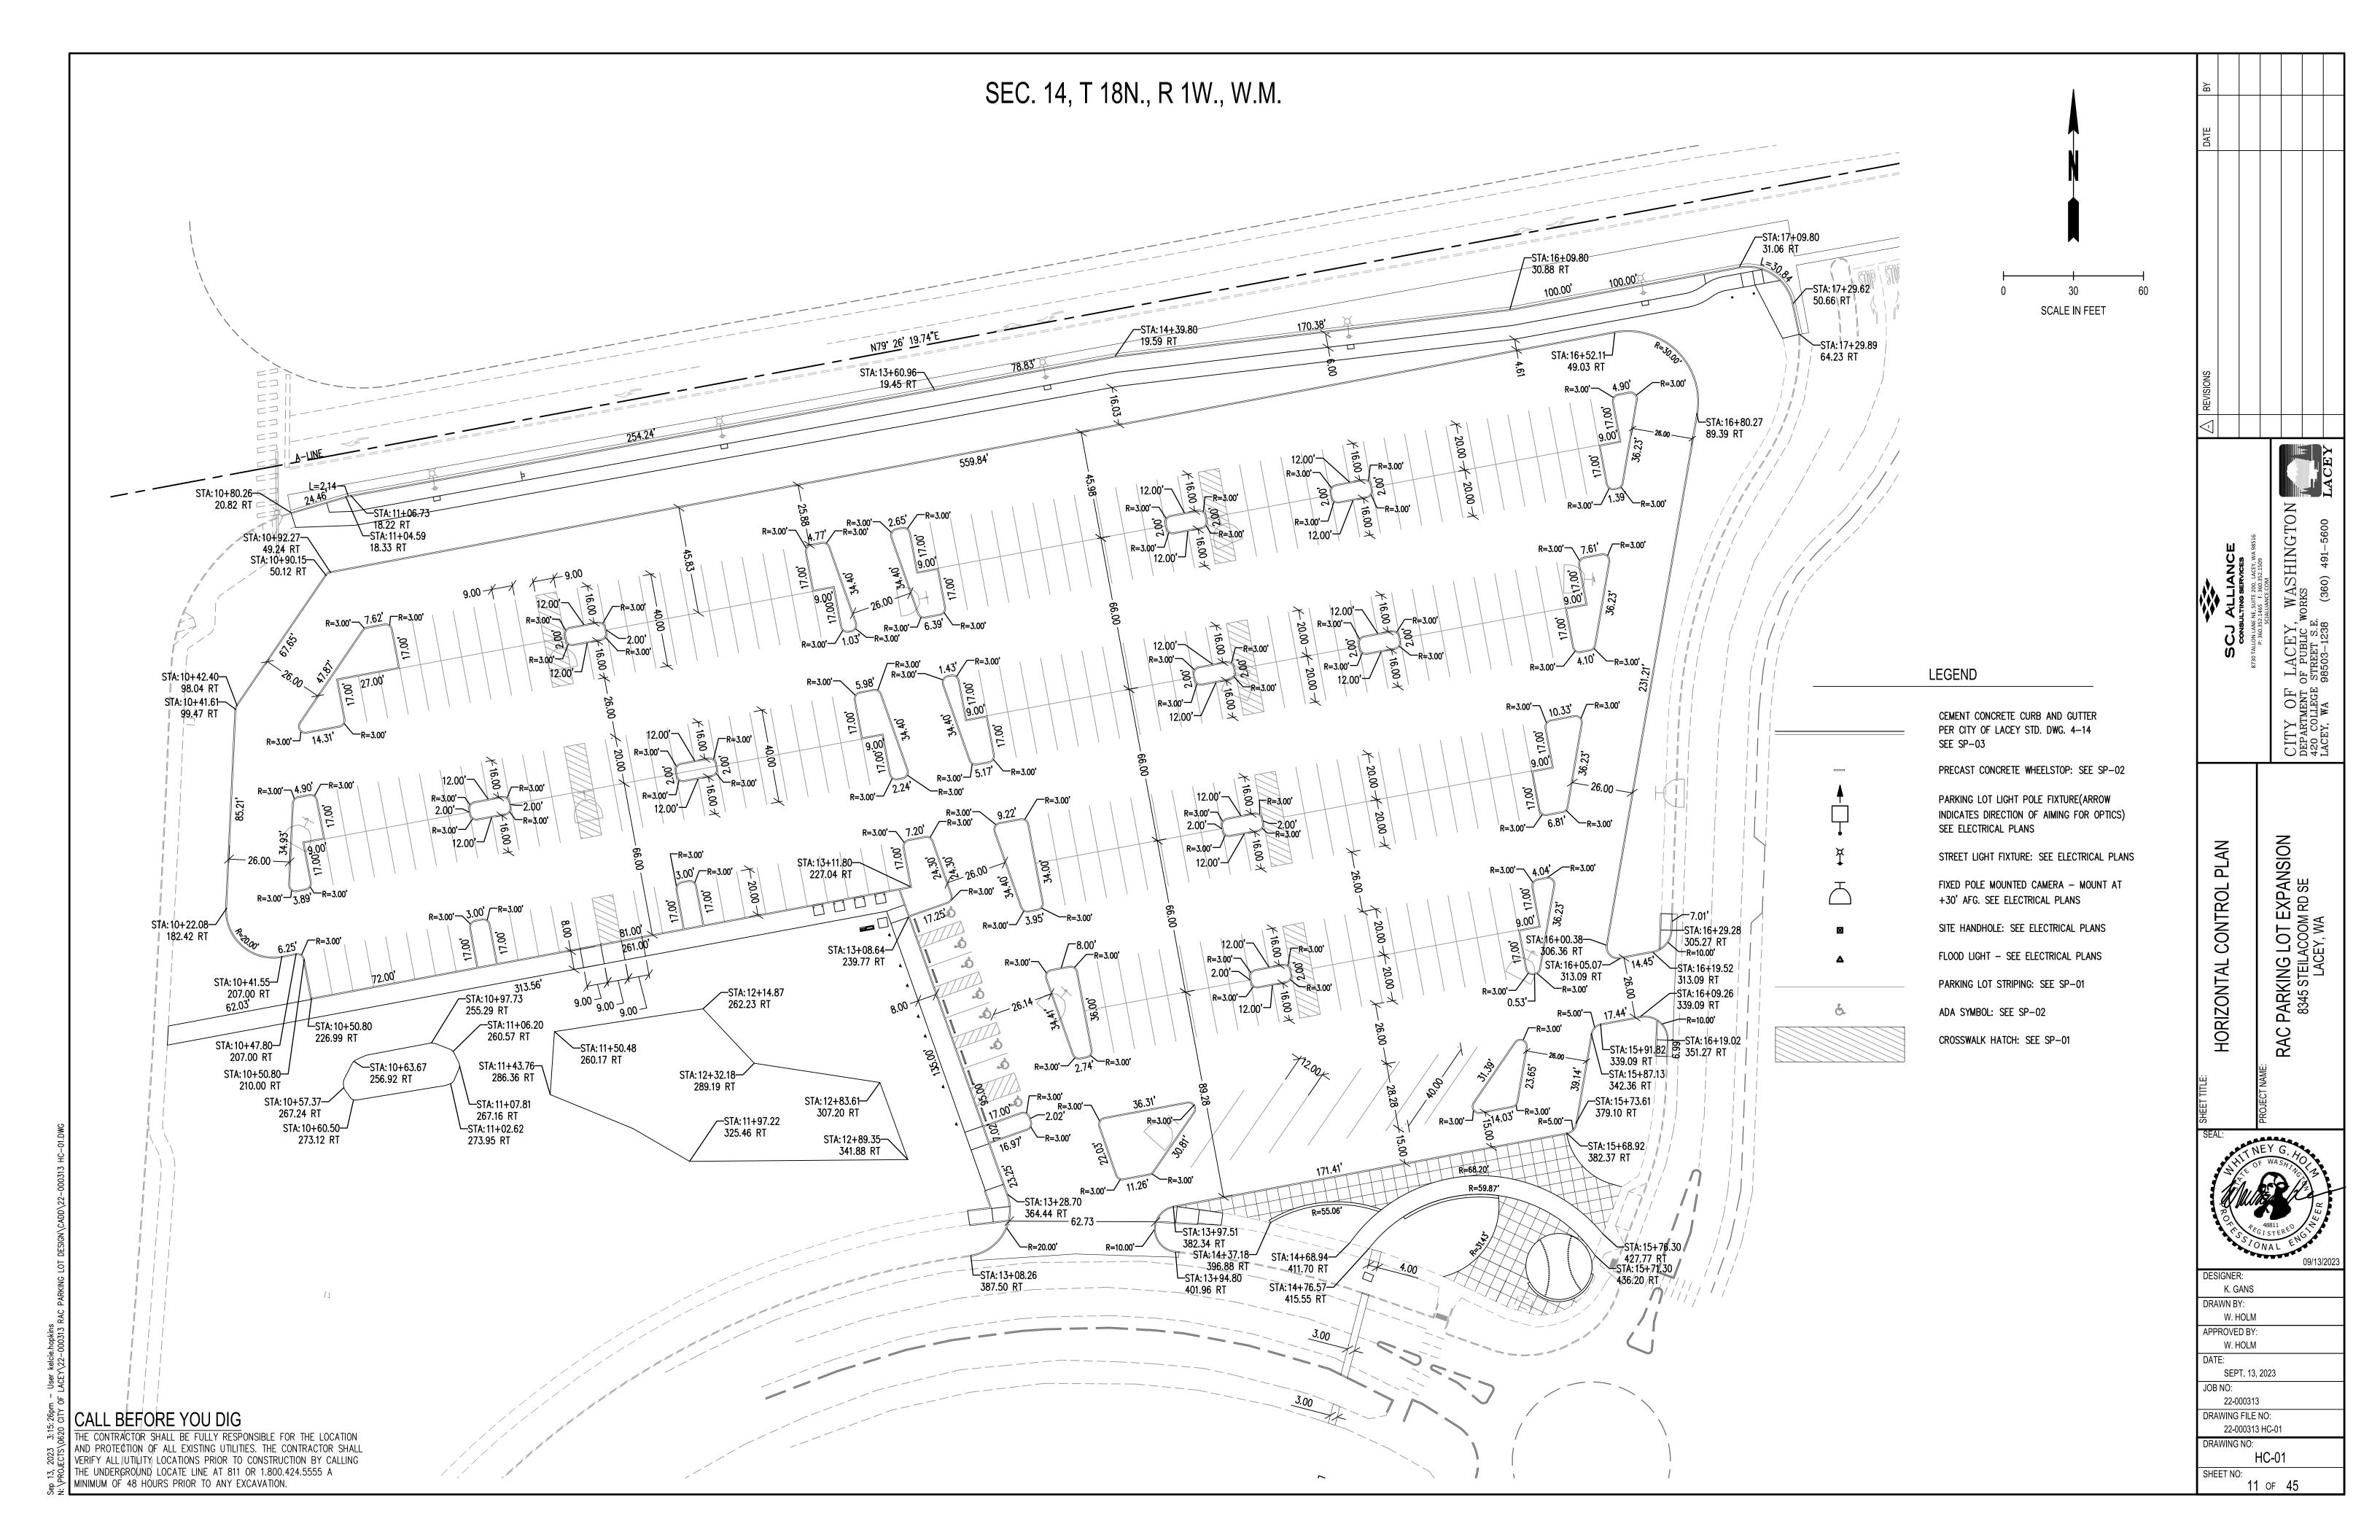
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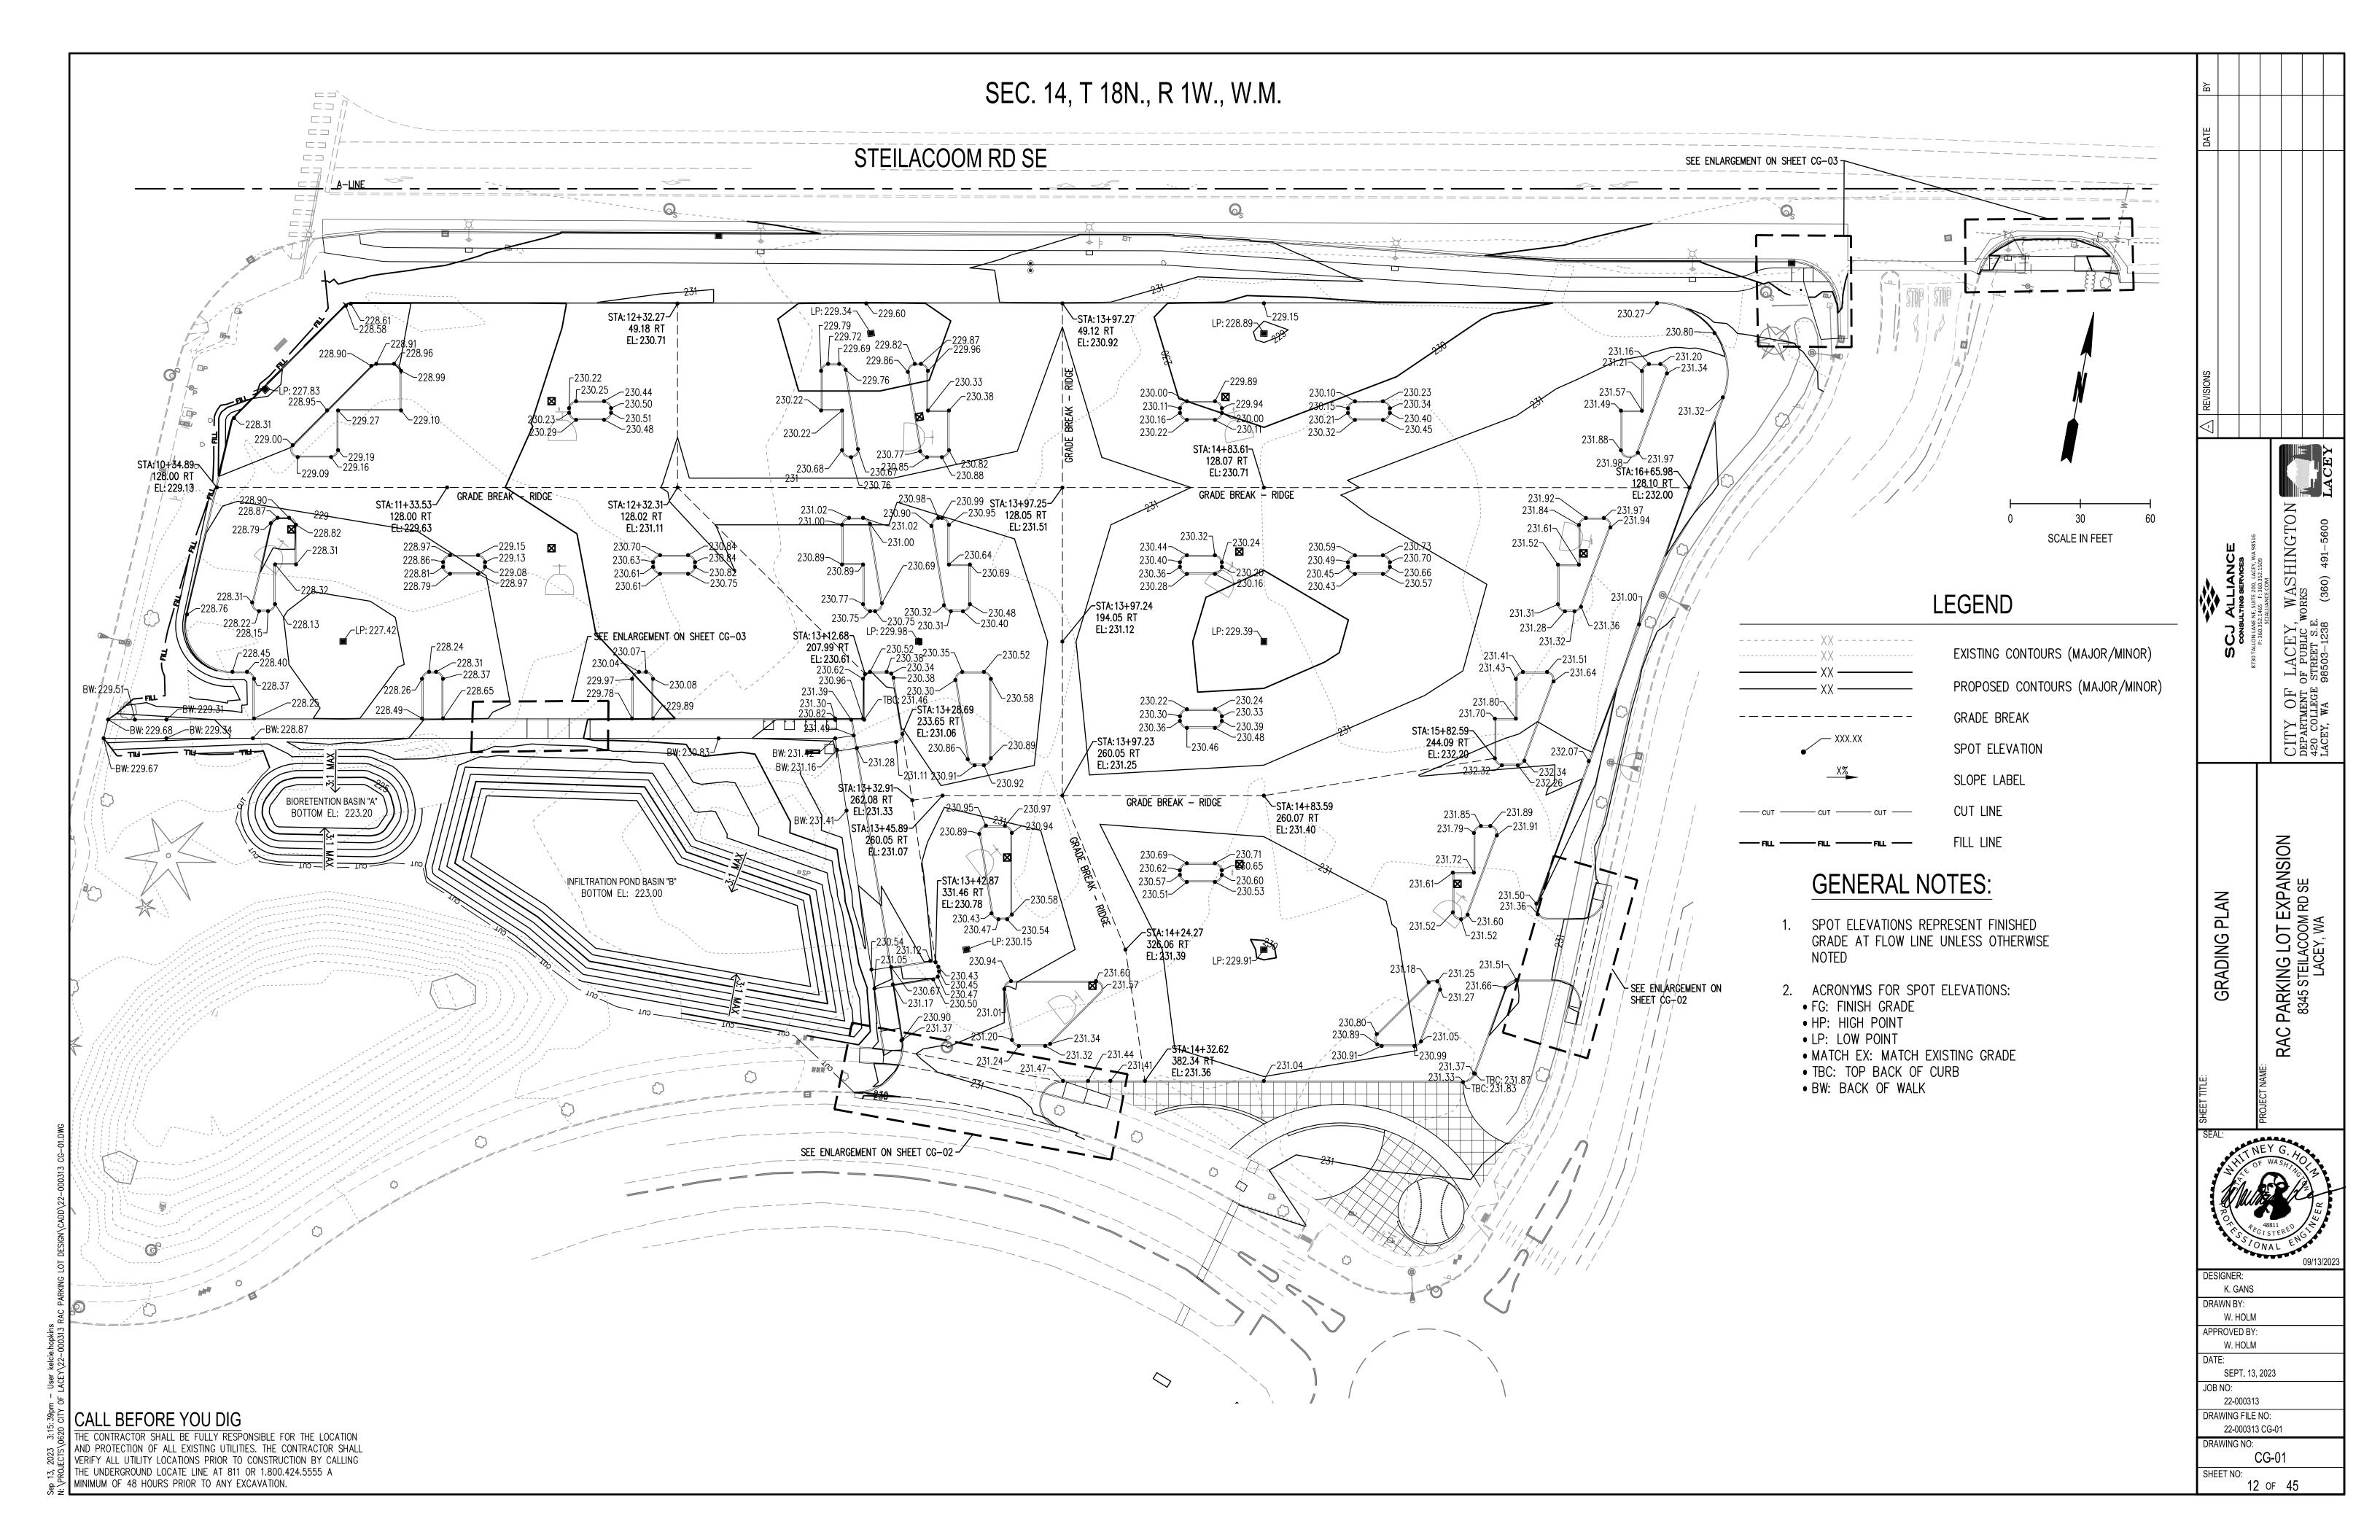
THE UNDERGROUND LOCATE LINE AT 811 OR 1.800.424.5555 A MINIMUM OF 48 HOURS PRIOR TO ANY EXCAVATION.




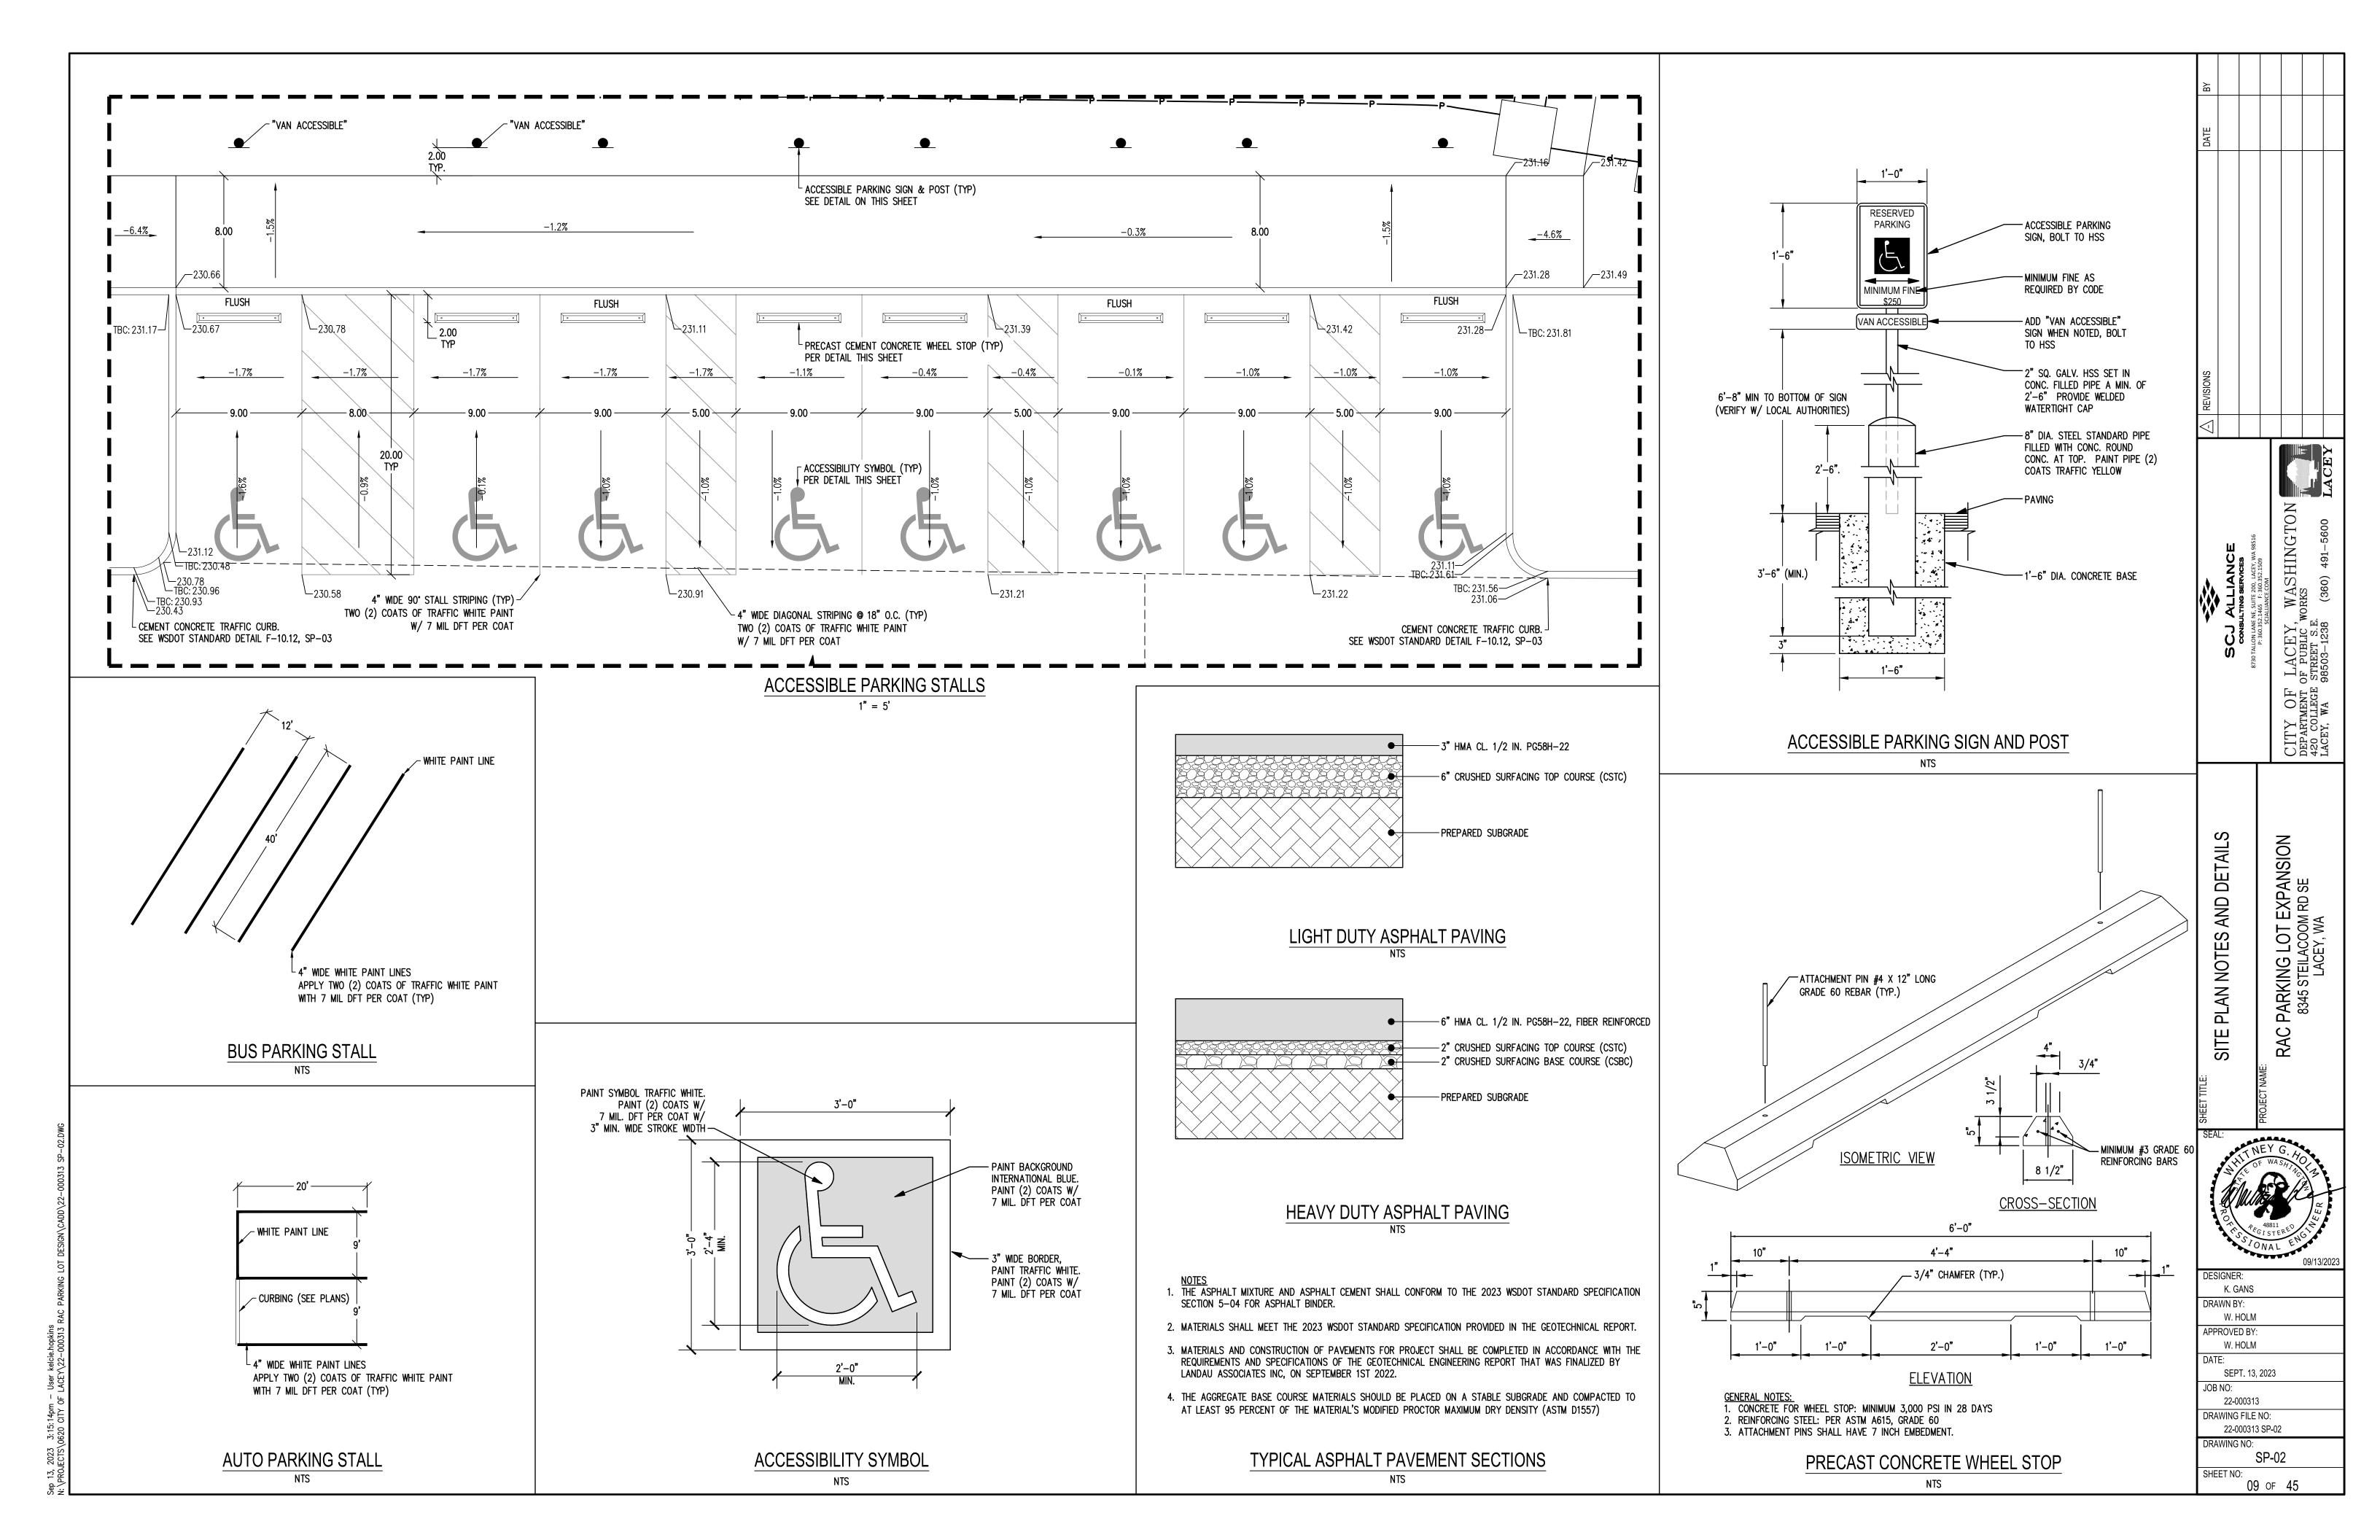


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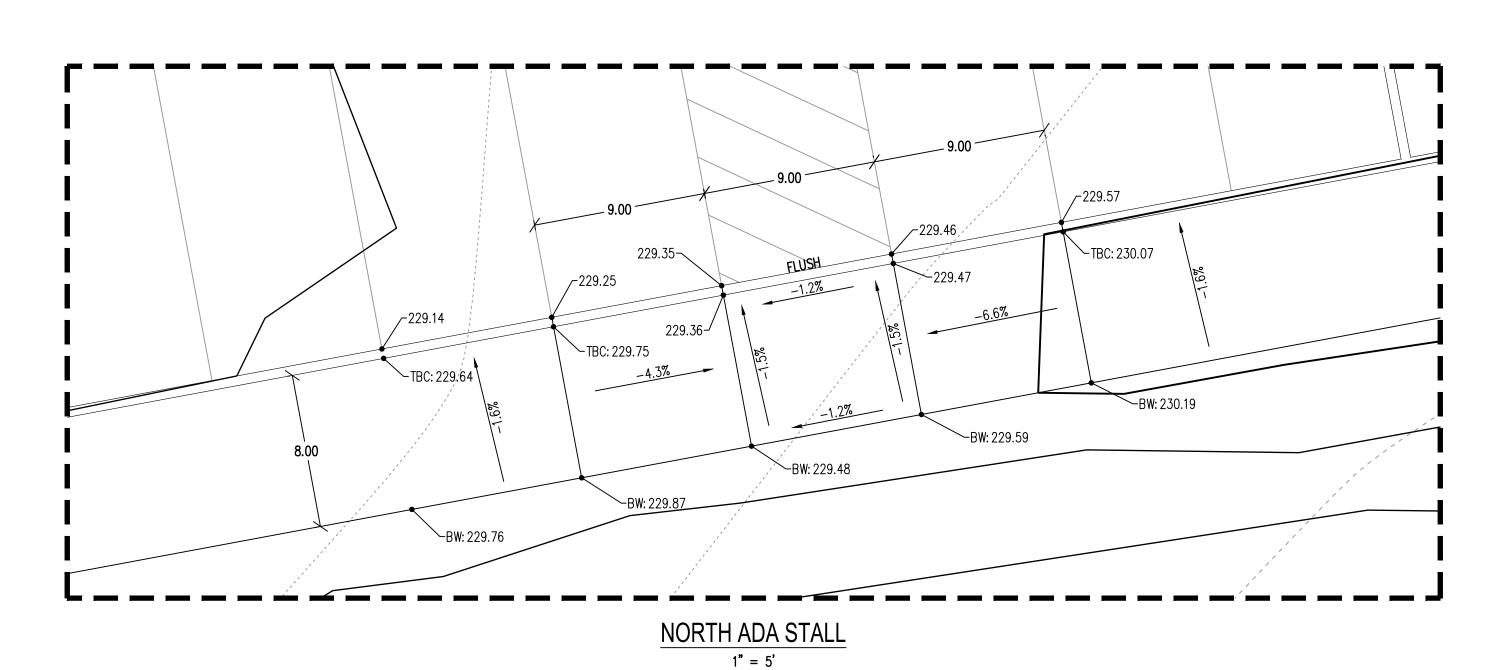


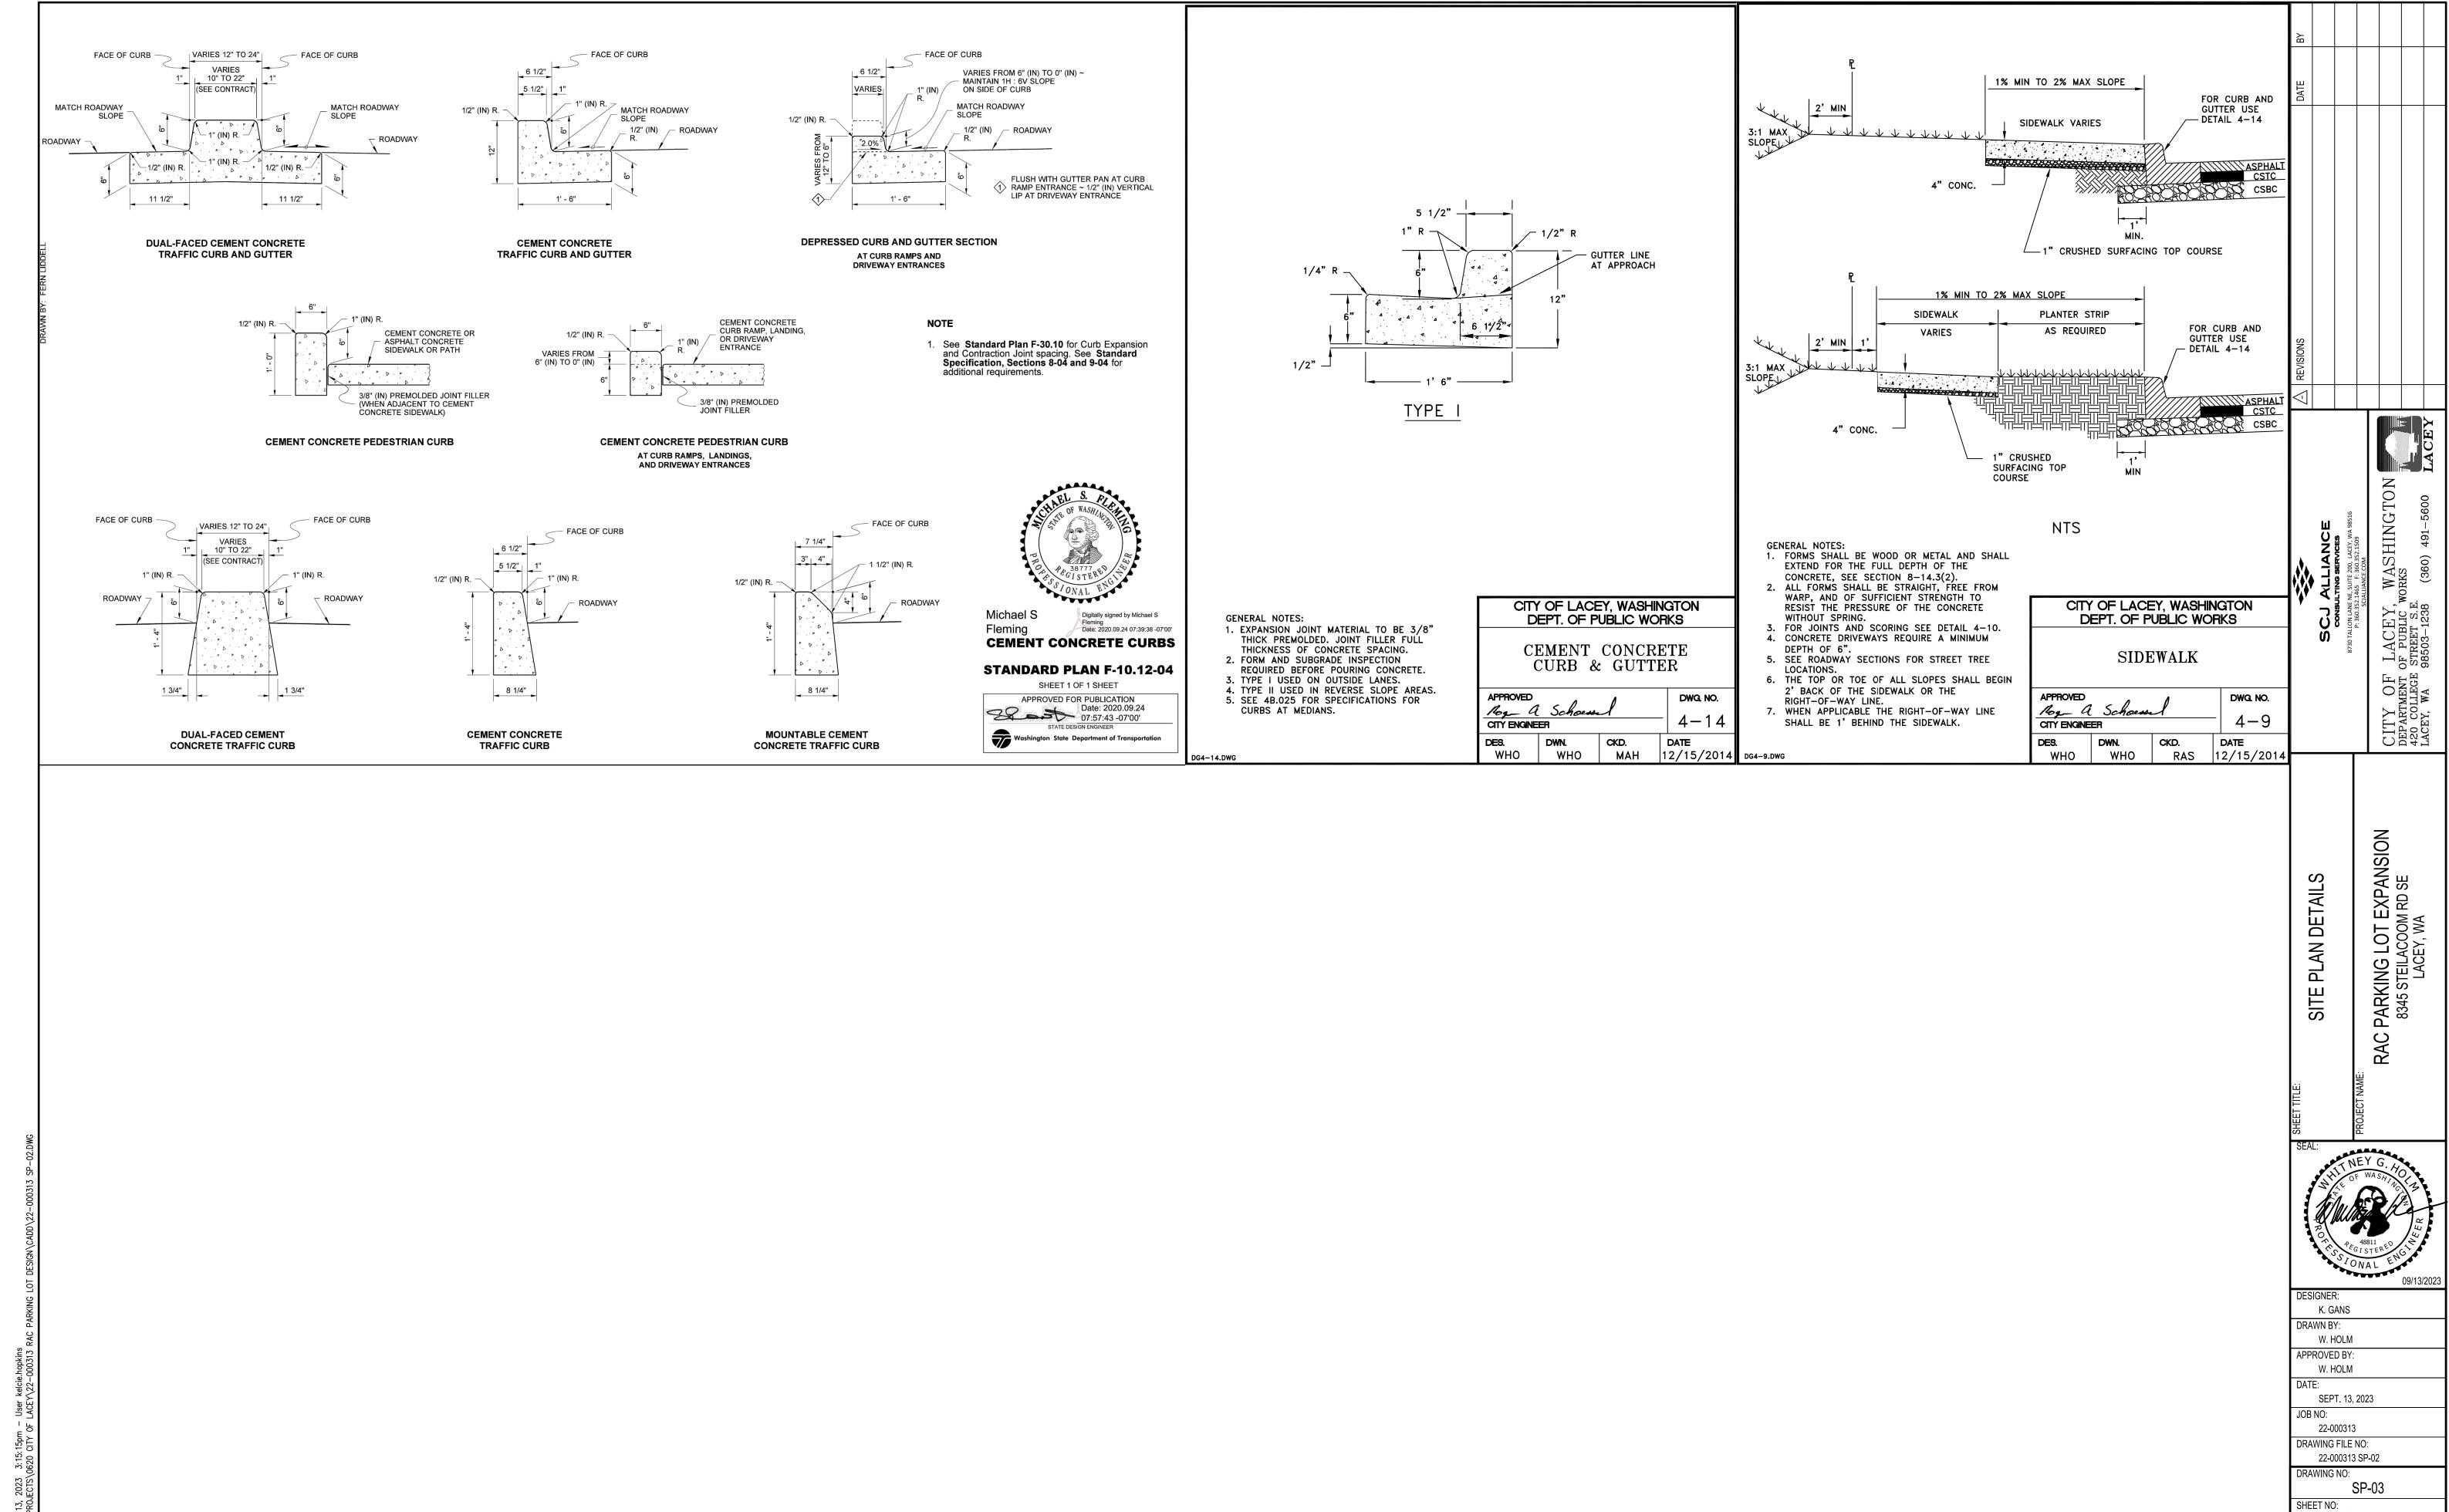


SEC. 14, T 18N., R 1W., W.M.

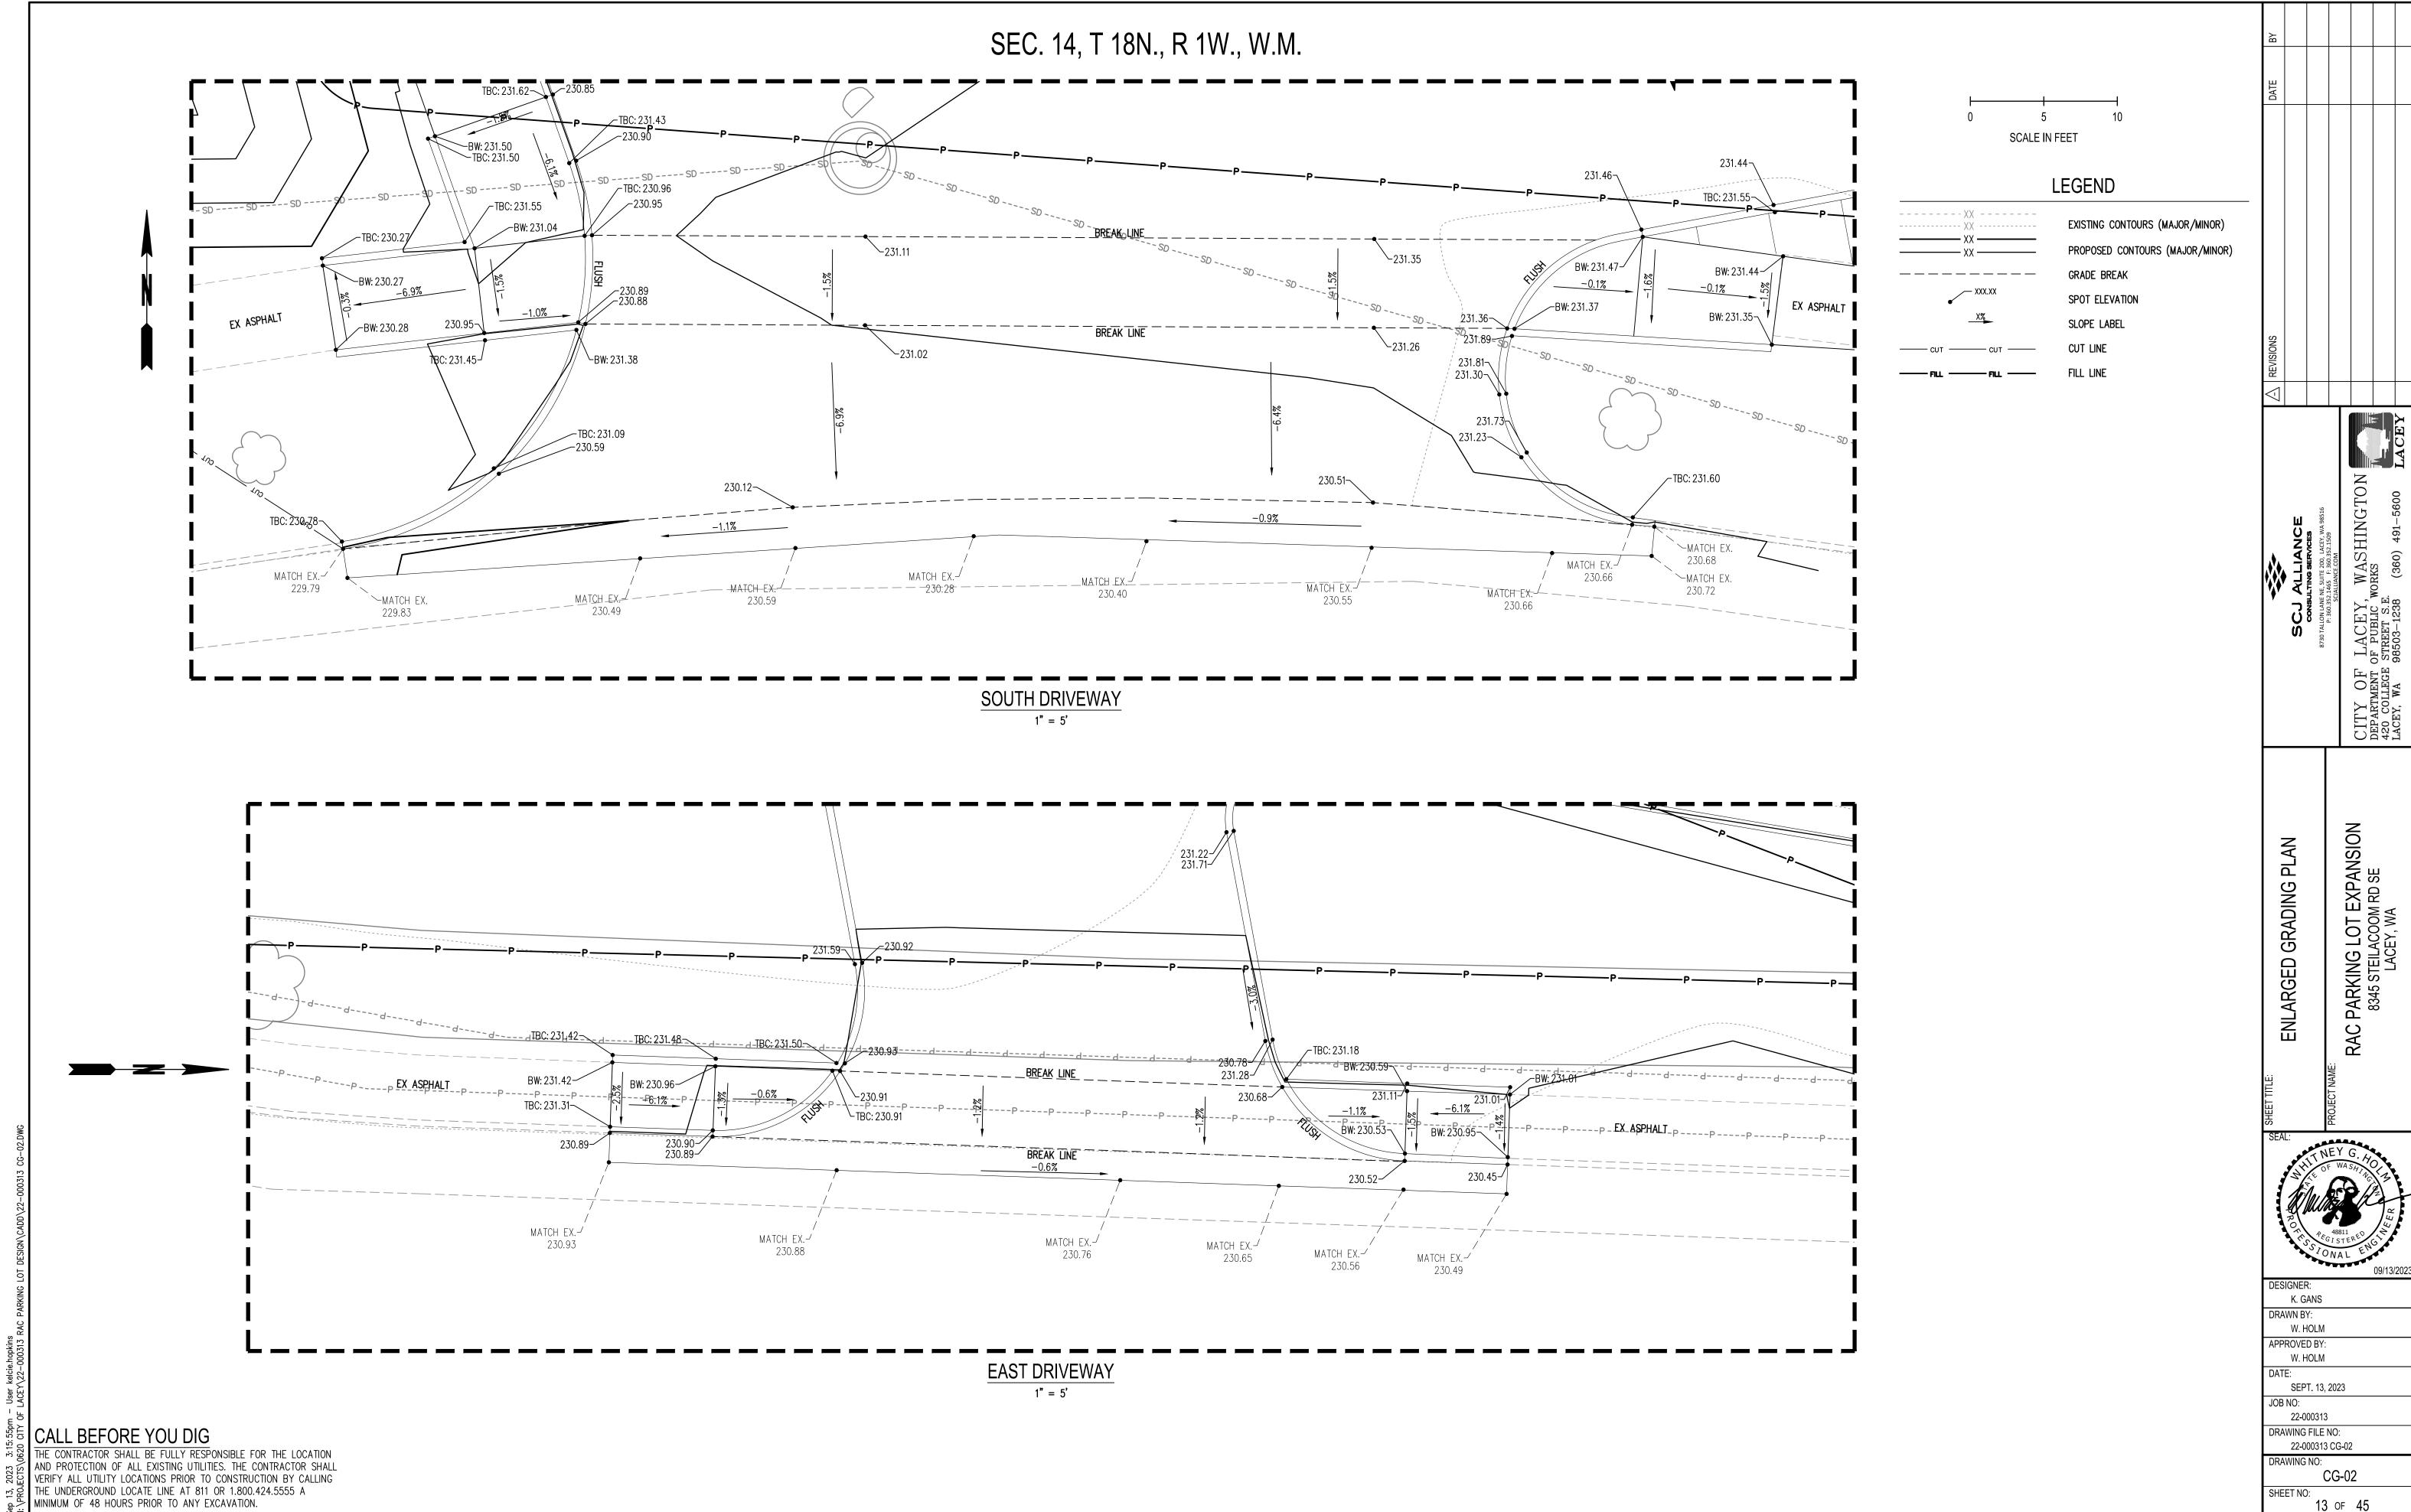

1" = 5'

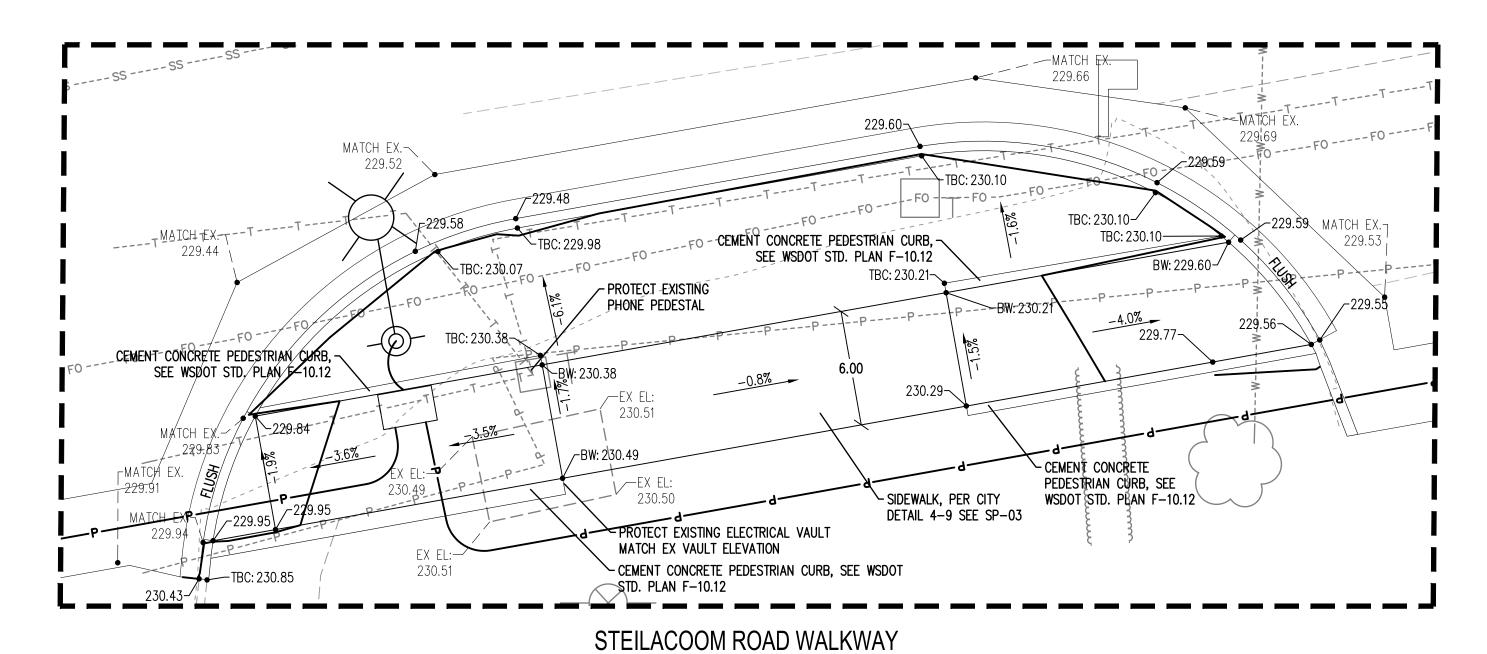


LEGEND

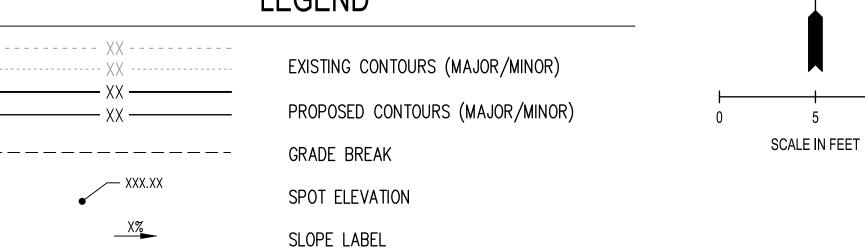

GENERAL NOTES:

- 1. SPOT ELEVATIONS REPRESENT FINISHED GRADE AT FLOW LINE UNLESS OTHERWISE NOTED
- 2. ACRONYMS FOR SPOT ELEVATIONS:
- FG: FINISH GRADE
- HP: HIGH POINT
- LP: LOW POINT
- MATCH EX: MATCH EXISTING GRADE
- TBC: TOP BACK OF CURB
- BW: BACK OF WALK

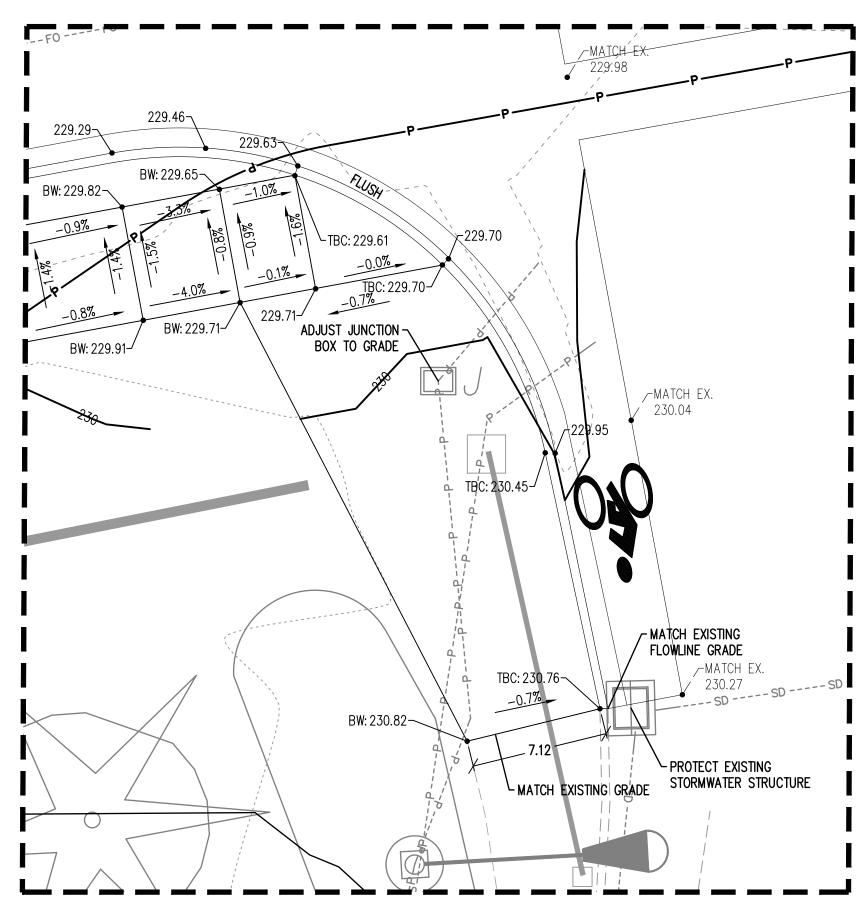


STEILACOOM ROAD RAMP

1" = 5'

REVISIONS DATE BY

					l -		I A C E
りくり ストニューション	CONSULTING SERVICES	8730 TALLON LANE NE, SUITE 200, LACEY, WA 98516 P: 360.352.1465 F: 360.352.1509	SCJALLIAINCE: COINI	CITY OF LACEY, WASHINGTON	ORKS		(360) 491-5600
7	CONSUL	8730 TALLON LANE N P: 360.352.1	#De	LACEY,	OF PUBLIC W	STREET S.E.	98503-1238
				CITY OF	DEPARTMENT OF PUBLIC WORKS	420 COLLEGE STREET S.E.	LACEY, WA 98503-1238

ENLARGED GRADING PLAN
RAC PARKING LOT EXPANSION
8345 STEILACOOM RD SE
LACEY, WA

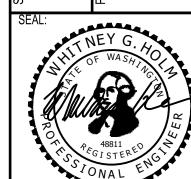


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	09/13/2023
DESIGNER:	
K. GANS	
DRAWN BY:	
W. HOLM	
APPROVED BY:	
W. HOLM	
DATE:	
SEPT. 13, 2023	
JOB NO:	
22-000313	
DRAWING FILE NO:	
22-000313 CG-02	
DRAWING NO:	

CG-03

14 of 45

SHEET NO:

THE CONTRACTOR SHALL BE FULLY RESPONSIBLE FOR THE LOCATION AND PROTECTION OF ALL EXISTING UTILITIES. THE CONTRACTOR SHALL VERIFY ALL UTILITY LOCATIONS PRIOR TO CONSTRUCTION BY CALLING THE UNDERGROUND LOCATE LINE AT 811 OR 1.800.424.5555 A MINIMUM OF 48 HOURS PRIOR TO ANY EXCAVATION.

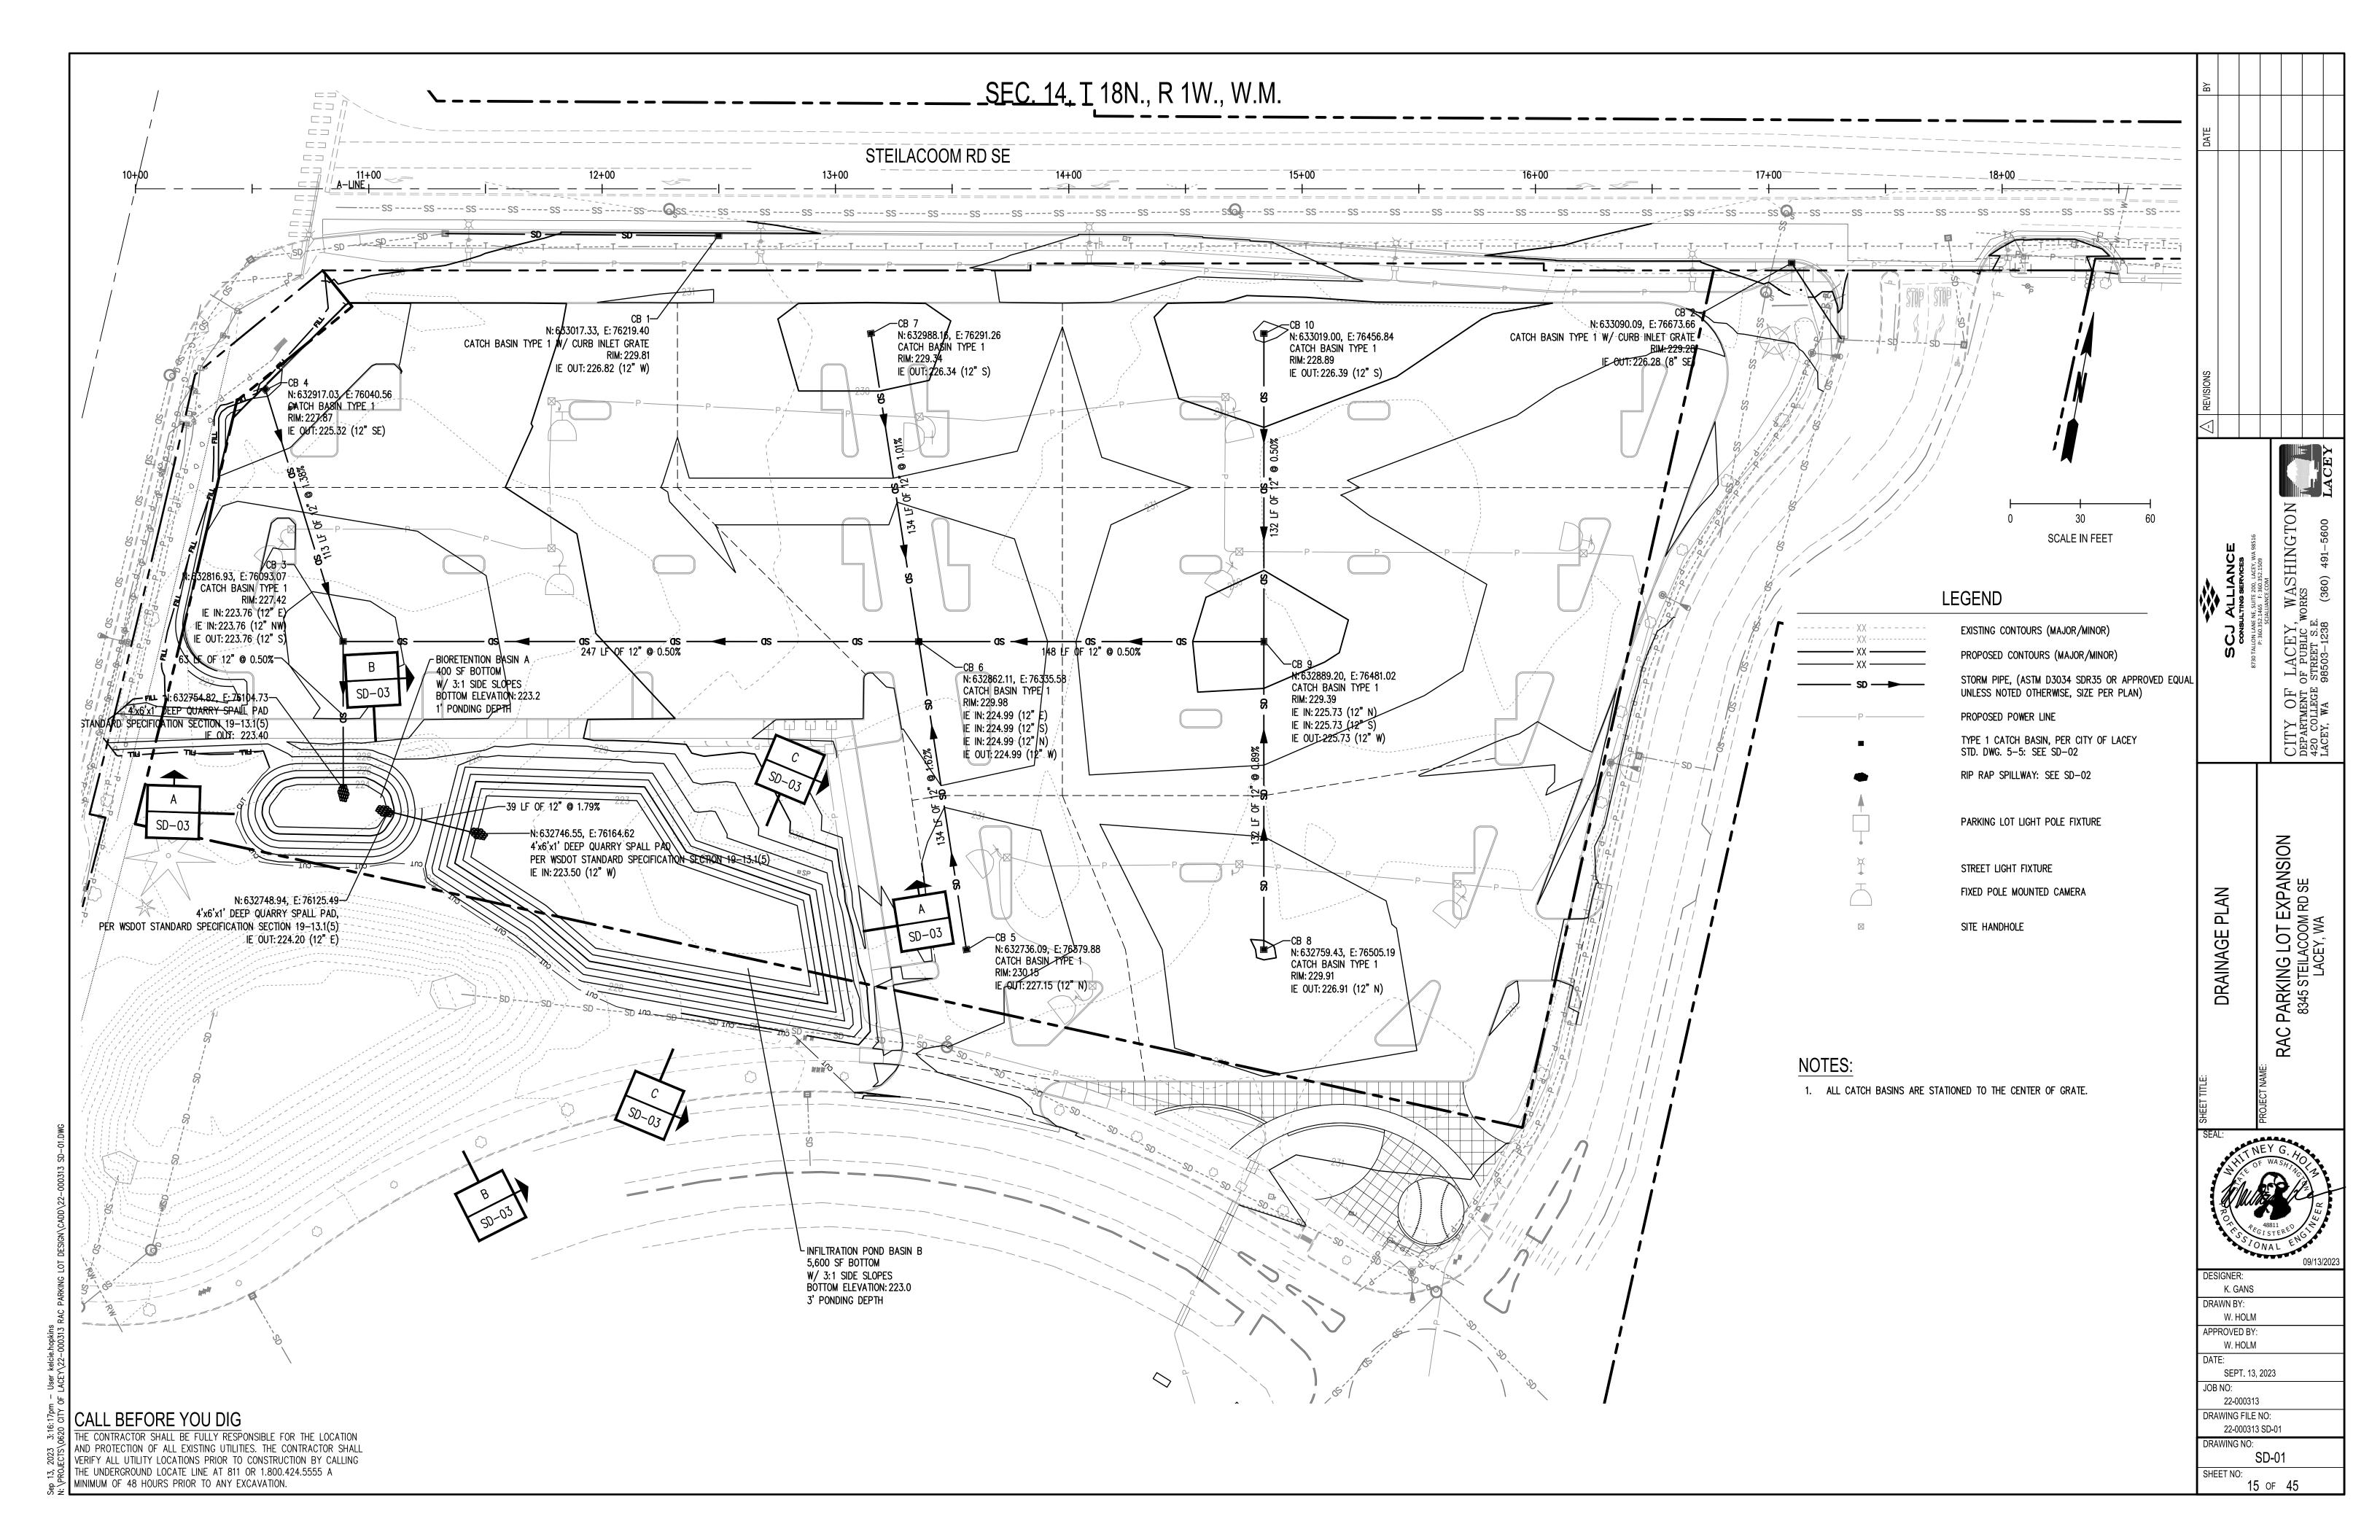



CITY OF LACEY GENERAL STORM DRAIN CONSTRUCTION NOTES


- 1. ALL APPROVALS AND PERMITS REQUIRED BY THE CITY OF LACEY SHALL BE OBTAINED BY THE CONTRACTOR PRIOR TO THE START OF CONSTRUCTION. A GRADING PERMIT FOR STORM POND CONSTRUCTION MAY BE REQUIRED.
- 2. STORM DRAIN PIPE MATERIAL SHALL BE ON THE WSDOT QUALIFIED PRODUCTS LIST FOR THE SPECIFICATION LISTED BELOW AND APPROVED BY THE CITY PRIOR TO INSTALLATION:
- A. PLAIN CONCRETE STORM SEWER PIPE OR REINFORCED CONCRETE STORM SEWER PIPE PER WSDOT STANDARD
- SPECIFICATION 9-05.7. B. SOLID WALL PVC STORM SEWER PIPE PER WSDOT STANDARD SPECIFICATION 9-05.12(1).
- C. DUCTILE IRON SEWER PIPE PER WSDOT STANDARD SPECIFICATION 9-05.13.


BE DONE BY THE CONTRACTOR.

- D. HANCOR BLUE SEAL™ AND ADVANCED DRAINAGE SYSTEMS (ADS/HANCOR) N-12 HDPE AND (ADS/HANCOR) SANITITE UP
- TO 36 INCH IN DIAMETER PER WSDOT STANDARD SPECIFICATIONS 9-05.20 AND 9-05.24.
- E. ADVANCE DRAINAGE SYSTEMS (ADS) CORRUGATED POLYPROPYLENE PIPE (CPEP) FROM 42" TO 60" IN DIAMETER PER WSDOT 9-05.24 (1) FOR USE NOT IN RIGHT OF WAY.
- F. CONTECH DUROMAXX STEEL RIB REINFORCED POLYETHYLENE PIPE, IN DIAMETERS FROM 24 INCH TO 60 INCH PER WSDOT STANDARD SPECIFICATION 9-05.22.
- 3. ALL STORM DRAINAGE SYSTEMS SHALL BE TESTED PER WSDOT STANDARD SPECIFICATION SECTION 7-04.3. TESTING SHALL
- 4. TESTING OF THE STORM SEWER SHALL INCLUDE VIDEO RECORDING OF THE MAIN BY THE CONTRACTOR. IMMEDIATELY PRIOR TO VIDEO RECORDING, ENOUGH WATER SHALL BE RUN DOWN THE LINE SO IT COMES OUT THE LOWER CATCH BASIN. A COPY OF THE VIDEO RECORDING SHALL BE SUBMITTED TO THE CITY OF LACEY. ACCEPTANCE OF THE LINE WILL NOT BE MADE UNTIL AFTER THE RECORDING HAS BEEN REVIEWED AND APPROVED BY THE CITY. TESTING SHALL TAKE PLACE AFTER ALL UNDERGROUND UTILITIES ARE INSTALLED AND COMPACTION OF THE ROADWAY SUBGRADE IS COMPLETE.
- 5. SPECIAL STRUCTURES, OIL/WATER SEPARATORS, AND OUTLET CONTROLS SHALL BE INSTALLED PER PLANS AND MANUFACTURERS' RECOMMENDATIONS. WHERE OIL/WATER SEPARATORS ARE CONNECTED TO A SEWER SYSTEM, THEY SHALL BE INSTALLED WITH A P-TRAP OR CHECK VALVE TO PREVENT ODORS.
- 3. ALL DISTURBED AREAS SHALL BE STABILIZED IN ACCORDANCE WITH CORE REQUIREMENT 2 OF THE CURRENT CITY OF LACEY STORMWATER DESIGN MANUAL. FOR SITES WHERE VEGETATION HAS BEEN PLANTED THROUGH HYDROSEEDING, THE FINANCIAL GUARANTEE WILL NOT BE RELEASED UNTIL THE VEGETATION HAS BEEN THOROUGHLY ESTABLISHED.
- . Where connections require "field verifications". Connection points will be exposed by contractor and fittings VERIFIED 48 HOURS PRIOR TO DISTRIBUTING SHUT-DOWN NOTICES.
- 8. ALL CATCH BASINS/MANHOLES SHALL HAVE PADS PER LACEY STANDARD DETAIL.
- 9. ANY CHANGES TO THE DESIGN SHALL FIRST BE REVIEWED AND APPROVED IN WRITING BY THE PROJECT ENGINEER AND THE CITY OF LACEY.
- 10. ALL STORM PIPE SHALL BE A MINIMUM OF 12-INCH DIAMETER FOR MAINS AND 8- INCH DIAMETER FOR LATERALS CROSSINGS. WHEN PRIVATE STORMWATER (I.E. ROOF, LOT, OR FOOTING DRAINS) CANNOT BE INFILTRATED ON INDIVIDUAL LOTS, THE MINIMUM STANDARD PIPING CONNECTION TO THE PUBLIC SYSTEM SHALL BE 8- INCH PVC. THE 8-INCH MAIN USED FOR CONNECTION SHALL BEGIN AT THE RIGHT OF-WAY. THE CONNECTION TO THE CATCH BASIN OR MANHOLE SHALL BE CORED.
- 11. ALL STORM MAINS AND STORMWATER TREATMENT AND/OR FLOW CONTROL BMPS/FACILITIES AREAS SHALL BE STAKED FOR GRADE AND ALIGNMENT BY AN ENGINEERING OR SURVEY FIRM LICENSED TO PERFORM SUCH WORK.
- 12. THE MINIMUM STAKING OF STORM SEWER SYSTEMS SHALL BE AS FOLLOWS:
- A. STAKE LOCATION OF ALL CATCH BASINS, MANHOLES, AND OTHER FIXTURES FOR GRADE AND ALIGNMENT.
- B. STAKE LOCATION, SIZE, AND DEPTH OF STORMWATER TREATMENT AND/OR FLOW CONTROL BMPS/FACILITIES.
- C. STAKE FINISHED GRADE OF ALL STORMWATER FEATURES, INCLUDING BUT NOT LIMITED TO CATCH BASIN/MANHOLE RIM ELEVATIONS, OVERFLOW STRUCTURES, WEIRS, AND INVERT ELEVATIONS OF ALL PIPES IN CATCH BASINS, MANHOLES, AND PIPES THAT DAYLIGHT.
- 13. PIPE SIZE, SLOPE, COVER, ETC., SHALL BE AS SPECIFIED IN THE CITY OF LACEY DEVELOPMENT GUIDELINES AND PUBLIC WORKS STANDARDS.
- 14. ALL DRIVEWAY CULVERTS SHALL BE OF SUFFICIENT LENGTH TO PROVIDE A MINIMUM 3:1 SLOPE FROM THE EDGE OF THE DRIVEWAY TO THE BOTTOM OF THE DITCH AT THE CULVERT END. CULVERTS SHALL HAVE BEVELED END SECTIONS TO MATCH THE SIDE SLOPE.
- 15. IF DRAINAGE OUTLETS (STUB-OUTS) ARE TO BE PROVIDED FOR EACH INDIVIDUAL LOT, THE STUB-OUTS SHALL CONFORM TO THE FOLLOWING:
- A. EACH OUTLET SHALL BE SUITABLY LOCATED AT THE LOWEST ELEVATION ON THE LOT. SO AS TO SERVICE ALL FUTURE ROOF DOWNSPOUTS, FOOTING DRAINS, DRIVEWAYS, YARD DRAINS, AND ANY OTHER SURFACE OR SUBSURFACE DRAINS NECESSARY TO RENDER THE LOTS SUITABLE FOR THEIR INTENDED USE. EACH OUTLET SHALL HAVE FREE-FLOWING. POSITIVE DRAINAGE TO AN APPROVED STORM WATER CONVEYANCE SYSTEM OR TO AN APPROVED OUTFALL LOCATION.
- B. OUTLETS ON EACH LOT SHALL BE LOCATED WITH A FIVE-FOOT-HIGH, 2-INCH BY 4-INCH STAKE MARKED "STORM" OR "Drain." The Stub-out shall visibly extend above surface level and be secured to the stake.
- C. DRAINAGE EASEMENTS ARE REQUIRED FOR DRAINAGE SYSTEMS DESIGNED TO CONVEY FLOWS THROUGH INDIVIDUAL LOTS.
- D. THE DEVELOPER AND/OR CONTRACTOR IS RESPONSIBLE FOR COORDINATING THE LOCATIONS OF ALL STUB-OUT CONVEYANCE LINES WITH RESPECT TO THE UTILITIES (E.G., POWER, GAS, TELEPHONE, TELEVISION).
- E. ALL INDIVIDUAL STUB-OUTS SHALL BE PRIVATELY OWNED AND MAINTAINED BY THE LOT HOMEOWNER.
- 16. THE STORM DRAINAGE SYSTEM SHALL BE CONSTRUCTED ACCORDING TO APPROVED PLANS ON FILE WITH THE CITY. ANY MATERIAL DEVIATION FROM THE APPROVED PLANS WILL REQUIRE WRITTEN APPROVAL FROM THE CITY AND SHALL BE CORRECTED IN THE AS-BUILT DRAWINGS.
- 17. ALL AREAS SUBJECT TO CLEARING AND GRADING THAT HAVE NOT BEEN COVERED BY IMPERVIOUS SURFACE, INCORPORATED INTO A DRAINAGE FACILITY, OR ENGINEERED AS STRUCTURAL FILL OR SLOPE SHALL BE AMENDED IN ACCORDANCE WITH THE CURRENT CITY OF LACEY STORMWATER DESIGN MANUAL AND THEN SEEDED, PLANTED, AND MULCHED OR SIMILARLY STABILIZED AFTER CONSTRUCTION TO THE SATISFACTION OF THE CITY. FOR SITES WHERE GRASS HAS BEEN PLANTED THROUGH HYDROSEEDING, THE PERFORMANCE BOND WILL NOT BE RELEASED UNTIL THE GRASS HAS BEEN THOROUGHLY ESTABLISHED, UNLESS OTHERWISE APPROVED BY THE CITY.
- 18. ALL EROSION CONTROL AND STORMWATER FACILITIES SHALL BE REGULARLY INSPECTED AND MAINTAINED BY THE CONTRACTOR DURING THE CONSTRUCTION PHASE OF THE DEVELOPMENT PROJECT.
- 19. NO FINAL CUT OR FILL SLOPE SHALL EXCEED 2:1 WITHOUT STABILIZATION BY ROCKERY OR BY A STRUCTURAL RETAINING
- 20. THE PROJECT ENGINEER SHALL VERIFY THE LOCATIONS, WIDTHS, THICKNESSES, AND ELEVATIONS OF ALL EXISTING PAVEMENTS AND STRUCTURES, INCLUDING UTILITIES AND OTHER FRONTAGE IMPROVEMENTS, WHICH ARE TO INTERFACE WITH NEW WORK. THE CONTRACTOR SHALL PROVIDE ALL TRIMMING, CUTTING, SAW CUTTING, GRADING, LEVELING, SLOPING, COATING, AND OTHER WORK, INCLUDING MATERIALS AS NECESSARY TO CAUSE THE INTERFACE WITH EXISTING WORKS TO BE PROPER, WITHOUT CONFLICT, ACCEPTABLE TO THE ENGINEER AND THE CITY, COMPLETE IN PLACE, AND READY TO USE.
- 21. COMPACTION OF ALL FILL AREAS SHALL BE PER CURRENT APWA SPECIFICATIONS. FILL SHALL BE PROVIDED IN 6-INCH MAXIMUM LIFTS AND SHALL BE COMPACTED TO 95 PERCENT OF ITS MAXIMUM RELATIVE DENSITY. DEVIATION FROM THIS STANDARD MAY BE APPROVED BY THE DIRECTOR, OR DESIGNEE, WHERE RECOMMENDED BY THE LICENSED PROFESSIONAL ENGINEER FOR PLANNED OR EXISTING INFILTRATION FACILITIES.

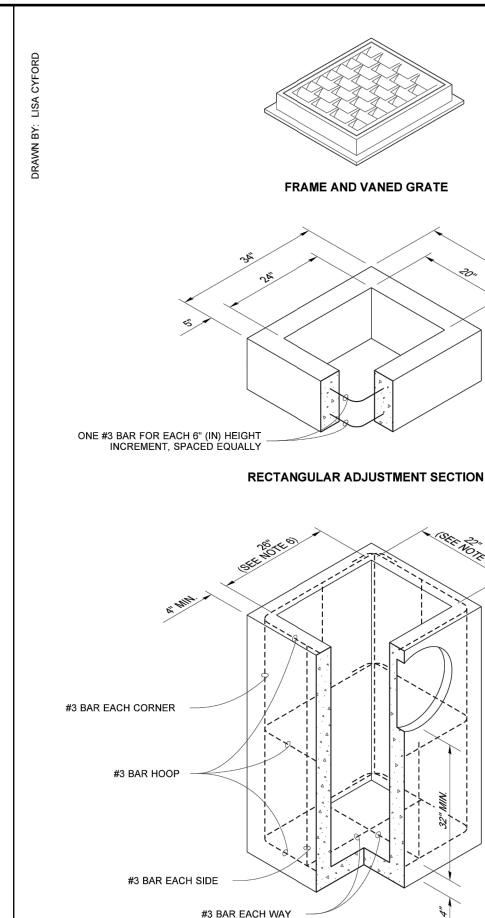


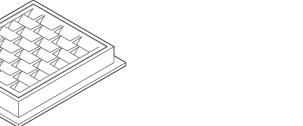

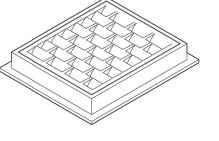

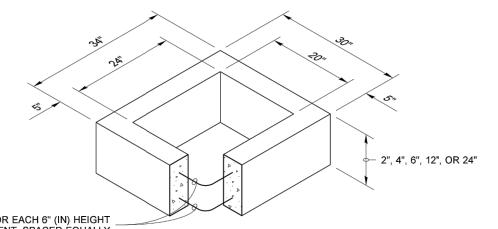

PRECAST BASE SECTION

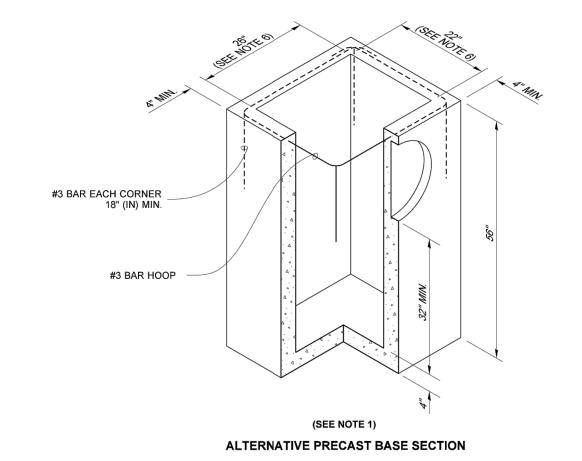

SIDE VIEW

1. CONCRETE PADS FOR ALL CURB INLET BASINS

ASSEMBLIES SHALL BE EAST JORDAN IRON

ASSEMBLIES SHALL BE DUCTILE IRON AND

WORKS OR OLYMPIC FOUNDRY WITH CITY OF

INSTALLATIONS ON ARTERIALS AND BOULEVARDS

STRUCTURE REGARDLESS OF THE TYPE OF PIPE

OR WHEN STORM PIPING IS TOO SHALLOW TO

MEET THE MINIMUM 2' OF COVER WHERE THE STORM PIPE ENDS UP IN THE ROADWAY

5. USE A 2" RECTANGULAR ADJUSTMENT SECTION

6. DEVIATION FROM THE COMPACTION STANDARDS

MAY BE APPROVED BY THE DIRECTOR, OR

DESIGNEE, WHERE RECOMMENDED BY THE

LICENSED PROFESSIONAL ENGINEER FOR PLANNED OR EXISTING INFILTRATION FACILITIES.

TURNED LENGTHWISE TO ELIMINATE THE GAP

SHALL BE A MINIMUM OF 3' X 3' X 8".

2. ALL STORM MANHOLE LID AND RING

LACEY LOGO LIDS WHEN AVAILABLE.

4. THIS APPLICATION SHALL BE USED FOR

3. ALL STORM MANHOLE LID AND RING

MANUFACTURED IN THE USA.


COMPACTED AT A MIN. 95%

GENERAL NOTES:

BEING USED.

DG5-5.DWG

UNDER THE FRAME.

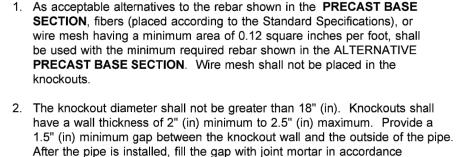

NOTES

with Standard Specification Section 9-04.3. 3. The maximum depth from the finished grade to the lowest pipe invert shall be 5' (ft).


4. The frame and grate may be installed with the flange down, or integrally cast into the adjustment section with flange up.

5. The Precast Base Section may have a rounded floor, and the walls may be sloped at a rate of 1:24 or steeper.

6. The opening shall be measured at the top of the Precast Base Section.

7. All pickup holes shall be grouted full after the basin has been placed.

CURB &

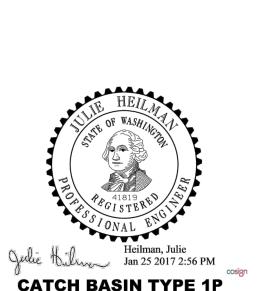

(FOR PARKING LOT) STANDARD PLAN B-5.60-02

Washington State Department of Transportation

-CURB INLET

ADJUSTMENT


GRATE

SHEET 1 OF 1 SHEET APPROVED FOR PUBLICATION Jan 26 2017 6:49 AM STATE DESIGN ENGINEER



DET

 \overline{S} LOT EXPAN ACOOM RD SE SEY, WA NOT PARKING | 8345 STEILA LACE DRAINAGE \circ ORM

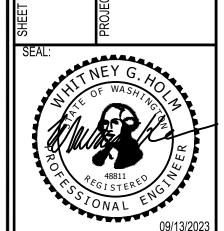

ESIGNER:

RAWN BY:

K. GANS

W. HOLM

W. HOLM

22-000313

AWING FILE NO:

RAWING NO:

22-000313 SD-02

SD-02

16 of 45

SEPT. 13, 2023

PROVED BY:

CITY OF LACEY, WASHINGTON DEPT. OF PUBLIC WORKS


CATCH BASIN INSTALLATION APPROVED DWG. NO. a Sc CITY ENGINEER DES CKD DATE

4. 44 FRONT VIEW <u>Ö</u>/

THE CITY OF LACEY LOGO LIDS SHALL BE USED WHEN AVAILABLE

CURB INLET GRATE &


WHO WHO RAS 08/24/201

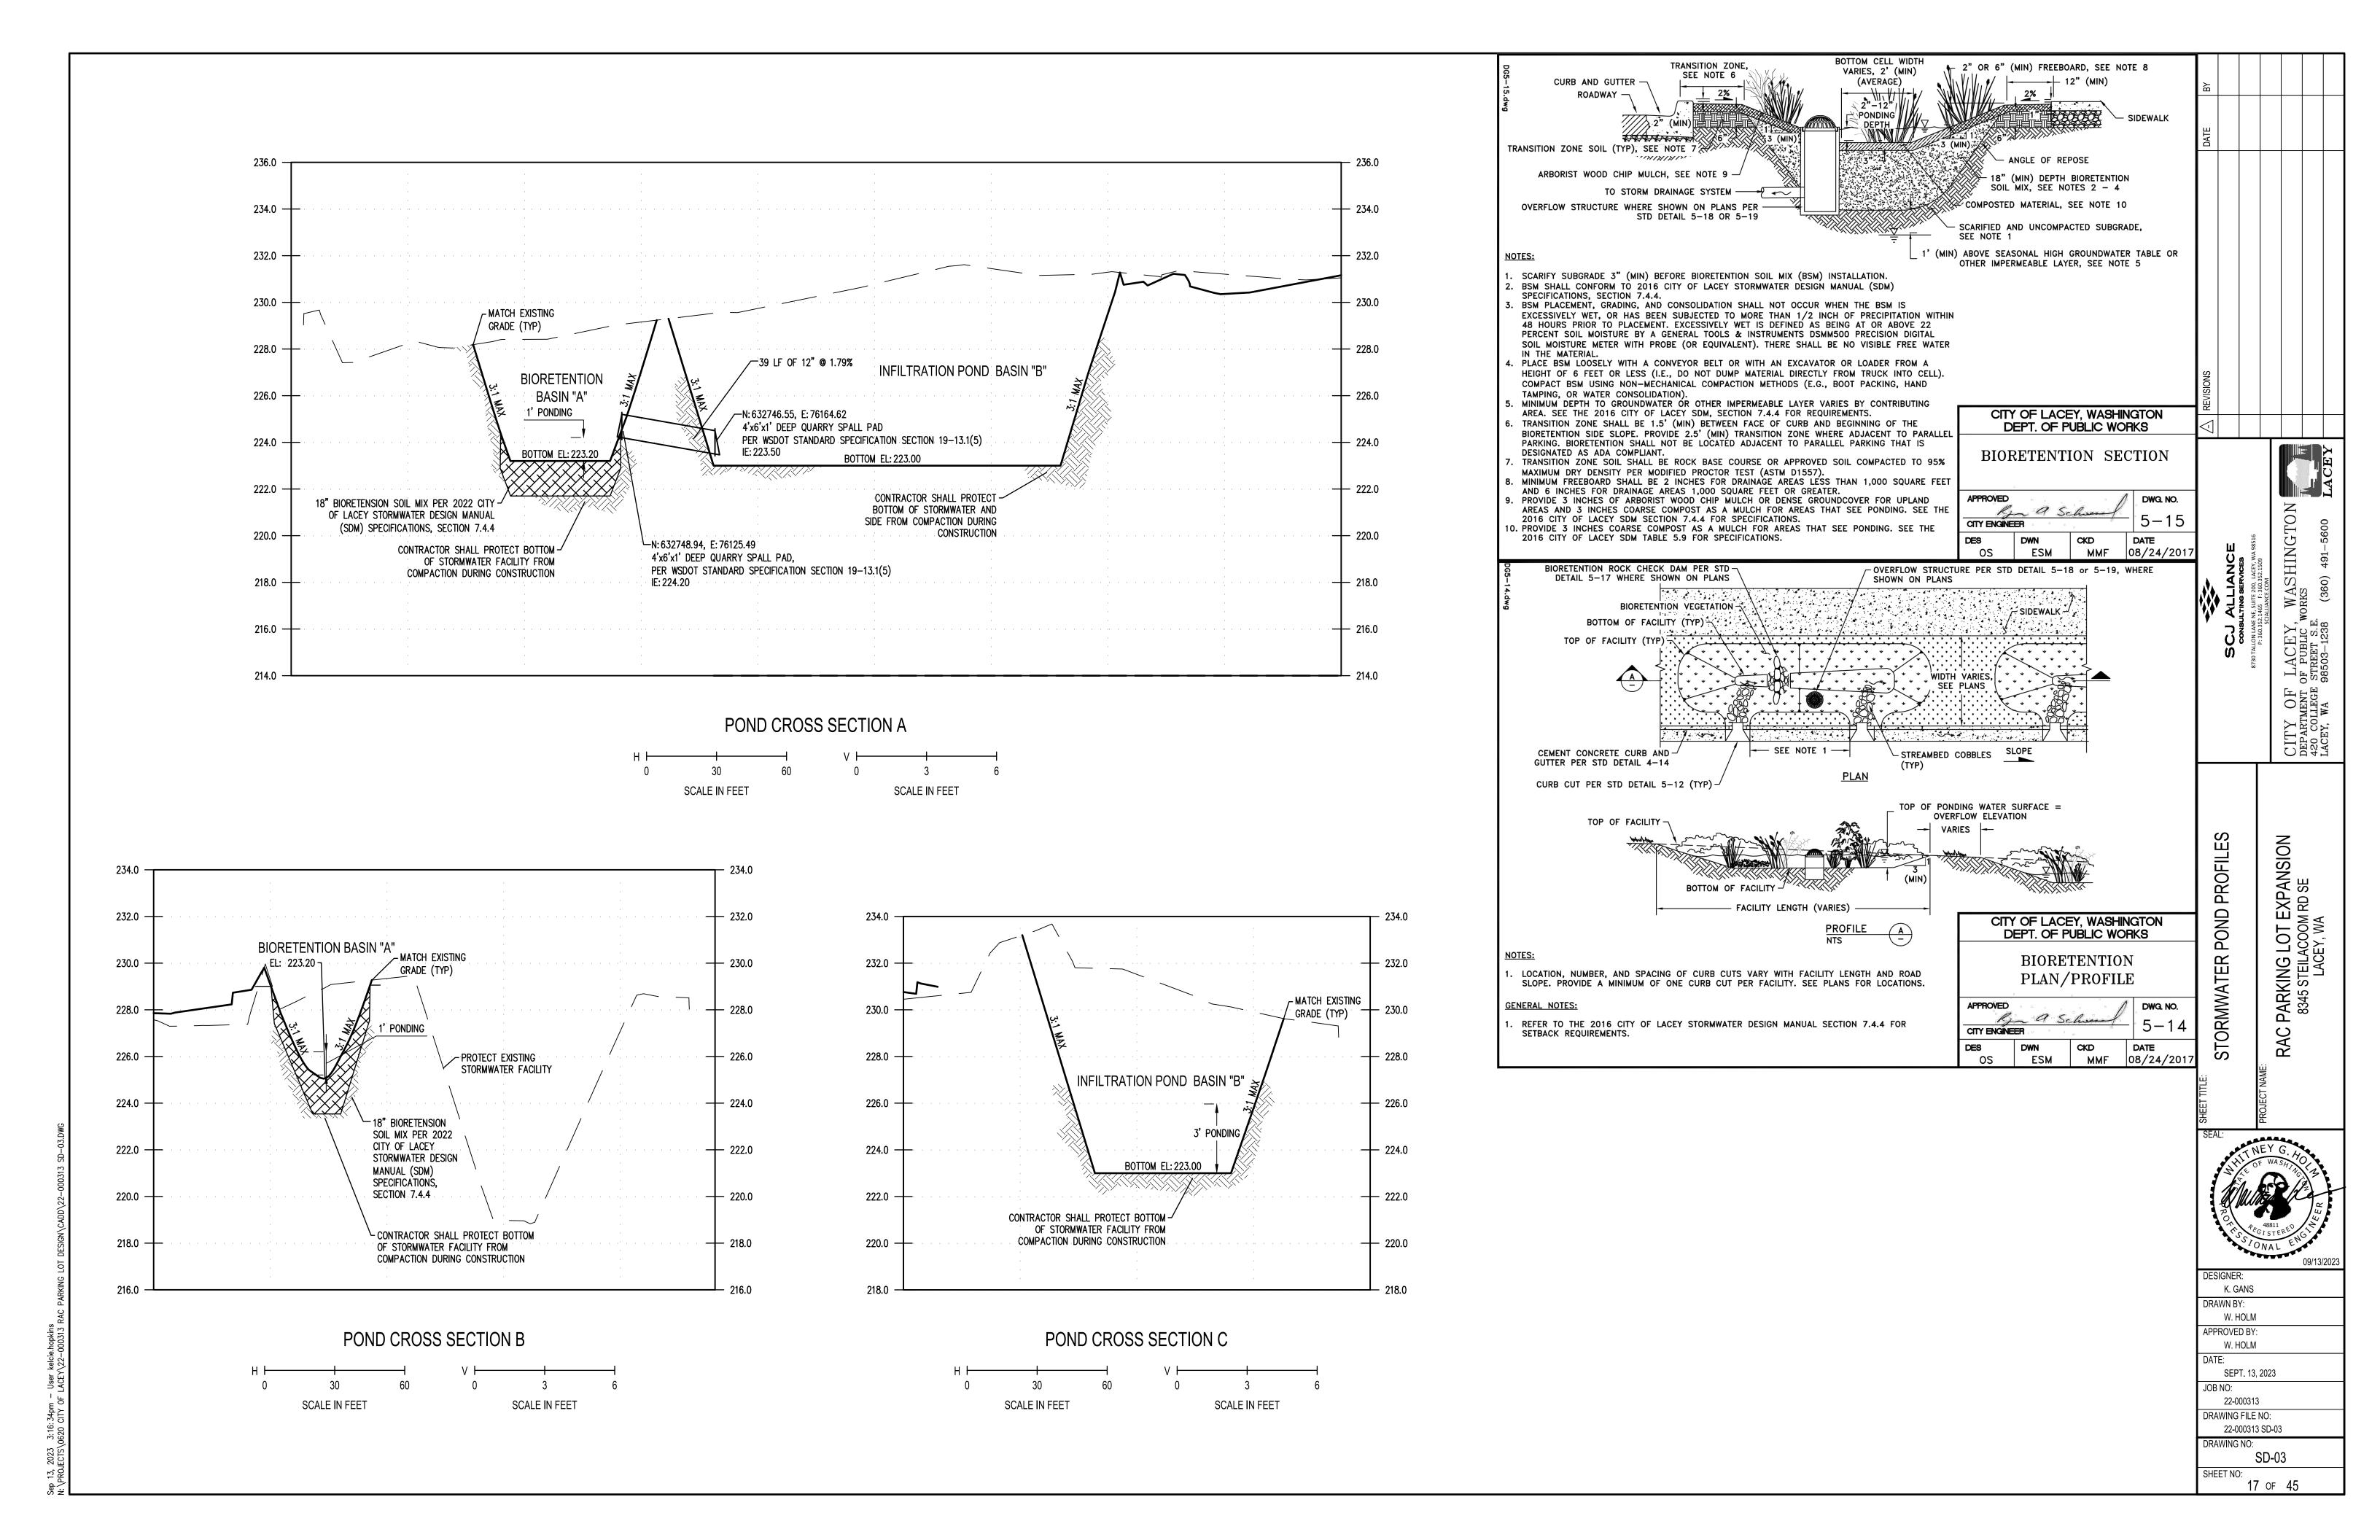


234.0 -232.0 -- 232.0 230.0 -- 230.0 228.0 -- 228.0 134 LF OF 12" @ 1.62% 134 LF OF 12" @ 1.01% N: 632736.09, E: 76379.88 CATCH BASIN TYPE 1 RIM: 230.15 IE OUT: 227.15 (12" N) 226.0 -- 226.0 CB 7 N: 632988.16, E: 76291.26 CATCH BASIN TYPE 1 RIM: 229.34 IE OUT: 226.34 (12" S) CB 6
N: 632862.11, E: 76335.58
CATCH BASIN TYPE 1
RIM: 229.98
IE IN: 224.99 (12" E)
IE IN: 224.99 (12" S)
IE IN: 224.99 (12" N)
IE OUT: 224.99 (12" W) 224.0 — - 224.0 222.0 -- 222.0 220.0 STORM PROFILE 1

SCALE IN FEET

SCALE IN FEET

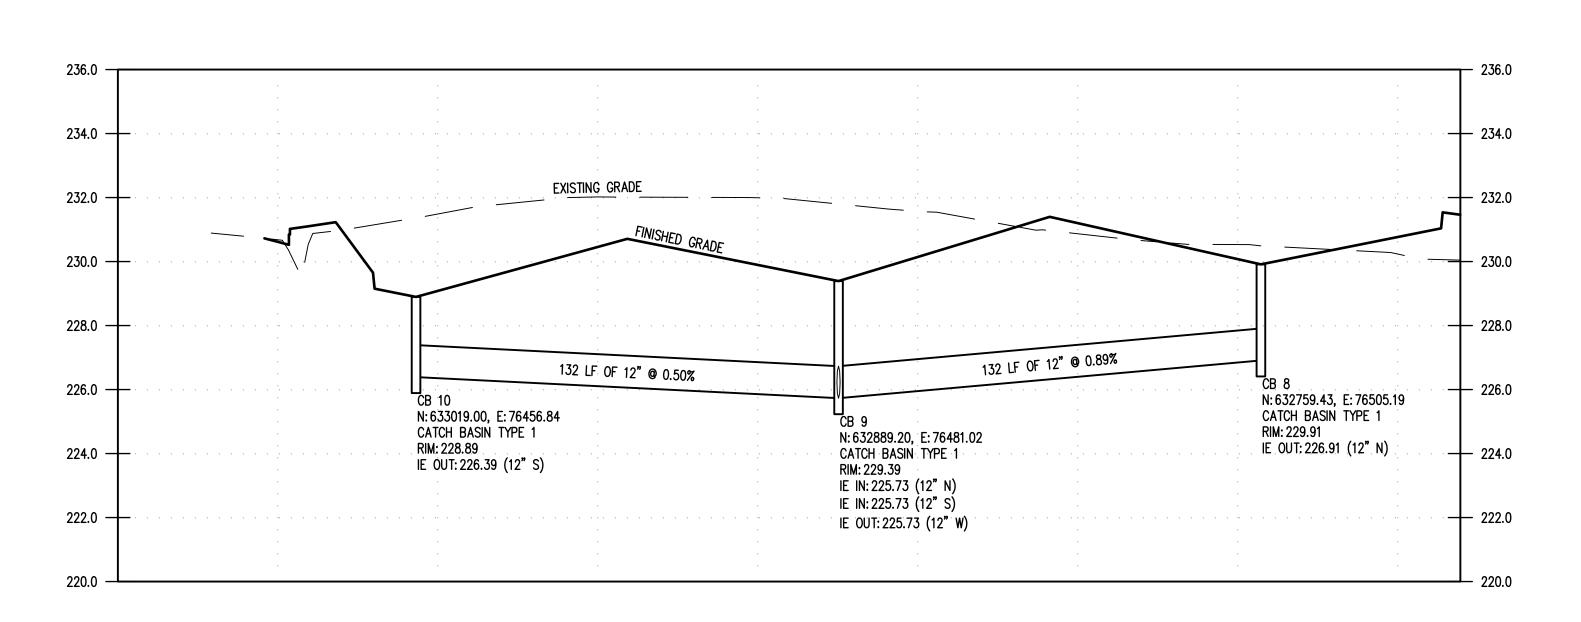

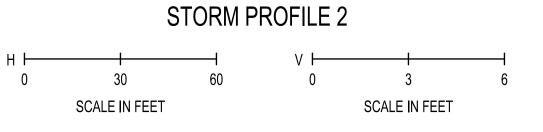

∠ REVISIONS	
SCJ ALLIANCE CONSULTING SERVICES 8730 TALLON LANE NE, SUITE 200, LACEY, WA 98516	CITY OF LACEY, WASHINGTON DEPARTMENT OF PUBLIC WORKS 420 COLLEGE STREET S.E. LACEY, WA 98503-1238 (360) 491-5600 LACEY
SHEET TITLE: STORM PIPE PROFILES	PROJECT NAME: RAC PARKING LOT EXPANSION 8345 STEILACOOM RD SE LACEY, WA
SEAL:	AEY G. HOLE WASHING ISTERED ON A L ENGLAND O9/13/2023
W. HOLM	

22-000313 DRAWING FILE NO:

DRAWING NO:

SHEET NO:

22-000313 SD-04

SD-04

18 of 45

3, 2023 3:16:44pm — User kelcie.hopkins ROJECTS\0620 CITY OF LACEY\22—000313 RAC PARKING LOT DESIGN\CADD\22—000313 S

- 230.0 230.0 — 228.0 228.0 148 LF OF 12" @ 0.50% 226.0 — 226.0 247 LF OF 12" @ 0.50% N: 632889.20, E: 76481.02 CATCH BASIN TYPE 1 RIM: 229.39 N: 632862.11, E: 76335.58 CATCH BASIN TYPE 1 RIM: 229.98 IE IN: 224.99 (12" E) IE IN: 224.99 (12" S) IE IN: 224.99 (12" N) IE OUT: 224.99 (12" W) 224.0 **—** - 224.0 IE IN: 225.73 (12" N)
IE IN: 225.73 (12" S) N: 632816.93, E: 76093.07 CATCH BASIN TYPE 1 RIM: 227.42 IE IN: 223.76 (12" E) 222.0 222.0 IE OUT: 225.73 (12" W) IE IN: 223.76 (12" NW) 220.0 IE OUT: 223.76 (12" S) 218.0 -STORM PROFILE 3 SCALE IN FEET SCALE IN FEET 232.0 -BIORETENTION BASIN "A" MATCH EXISTING GRADE GRADE (TYP) 230.0 230.0 FINISHED GRADE-228.0 -228.0 EXISTING STORMWATER **FACILITY** 226.0 226.0 PROTECT EXISTING STORMWATER FACILITY 113 LF OF 12" @ 1.38% 63 LF OF 12" @ 0.50% N: 632917.03, E: 76040.56 CATCH BASIN TYPE 1 RIM: 227.87 IE OUT: 225.32 (12" SE) 224.0 224.0 —N: 632754.82∖ E: 76104.73 4'x6'x1' DEEP\QUARRY SPALL PAD N: 632816.93, E: 76093.07 CATCH BASIN TYPE 1 RIM: 227.42 PER WSDOT STANDARD SPECIFICATION SECTION /19-13.1(5) 222.0 222.0 — 18" BIORETENSION SOIL \
MIX PER 2022 CITY OF \
LACEY STORMWATER IE IN: 223.76 (12" E)
IE IN: 223.76 (12" NW) 220.0 220.0 -IE OUT: 223.76 (12" S) DESIGN MANUAL (SDM) SPECIFICATIONS, SECTION 7.4.4 CONTRACTOR SHALL PROTECT BOTTOM OF STORMWATER FACILITY FROM COMPACTION DURING CONSTRUCTION 218.0 -218.0 216.0 STORM PROFILE 4 SCALE IN FEET SCALE IN FEET

DESIGNER: K. GANS DRAWN BY: W. HOLM APPROVED BY: W. HOLM

NOISN

DETAIL(

STORM PIPE


S PARKING LOT EXPANS 8345 STEILACOOM RD SE LACEY, WA


RAC


SEPT. 13, 2023


JOB NO: 22-000313 DRAWING FILE NO:

22-000313 SD-04 DRAWING NO: SD-05 SHEET NO: 19 of 45

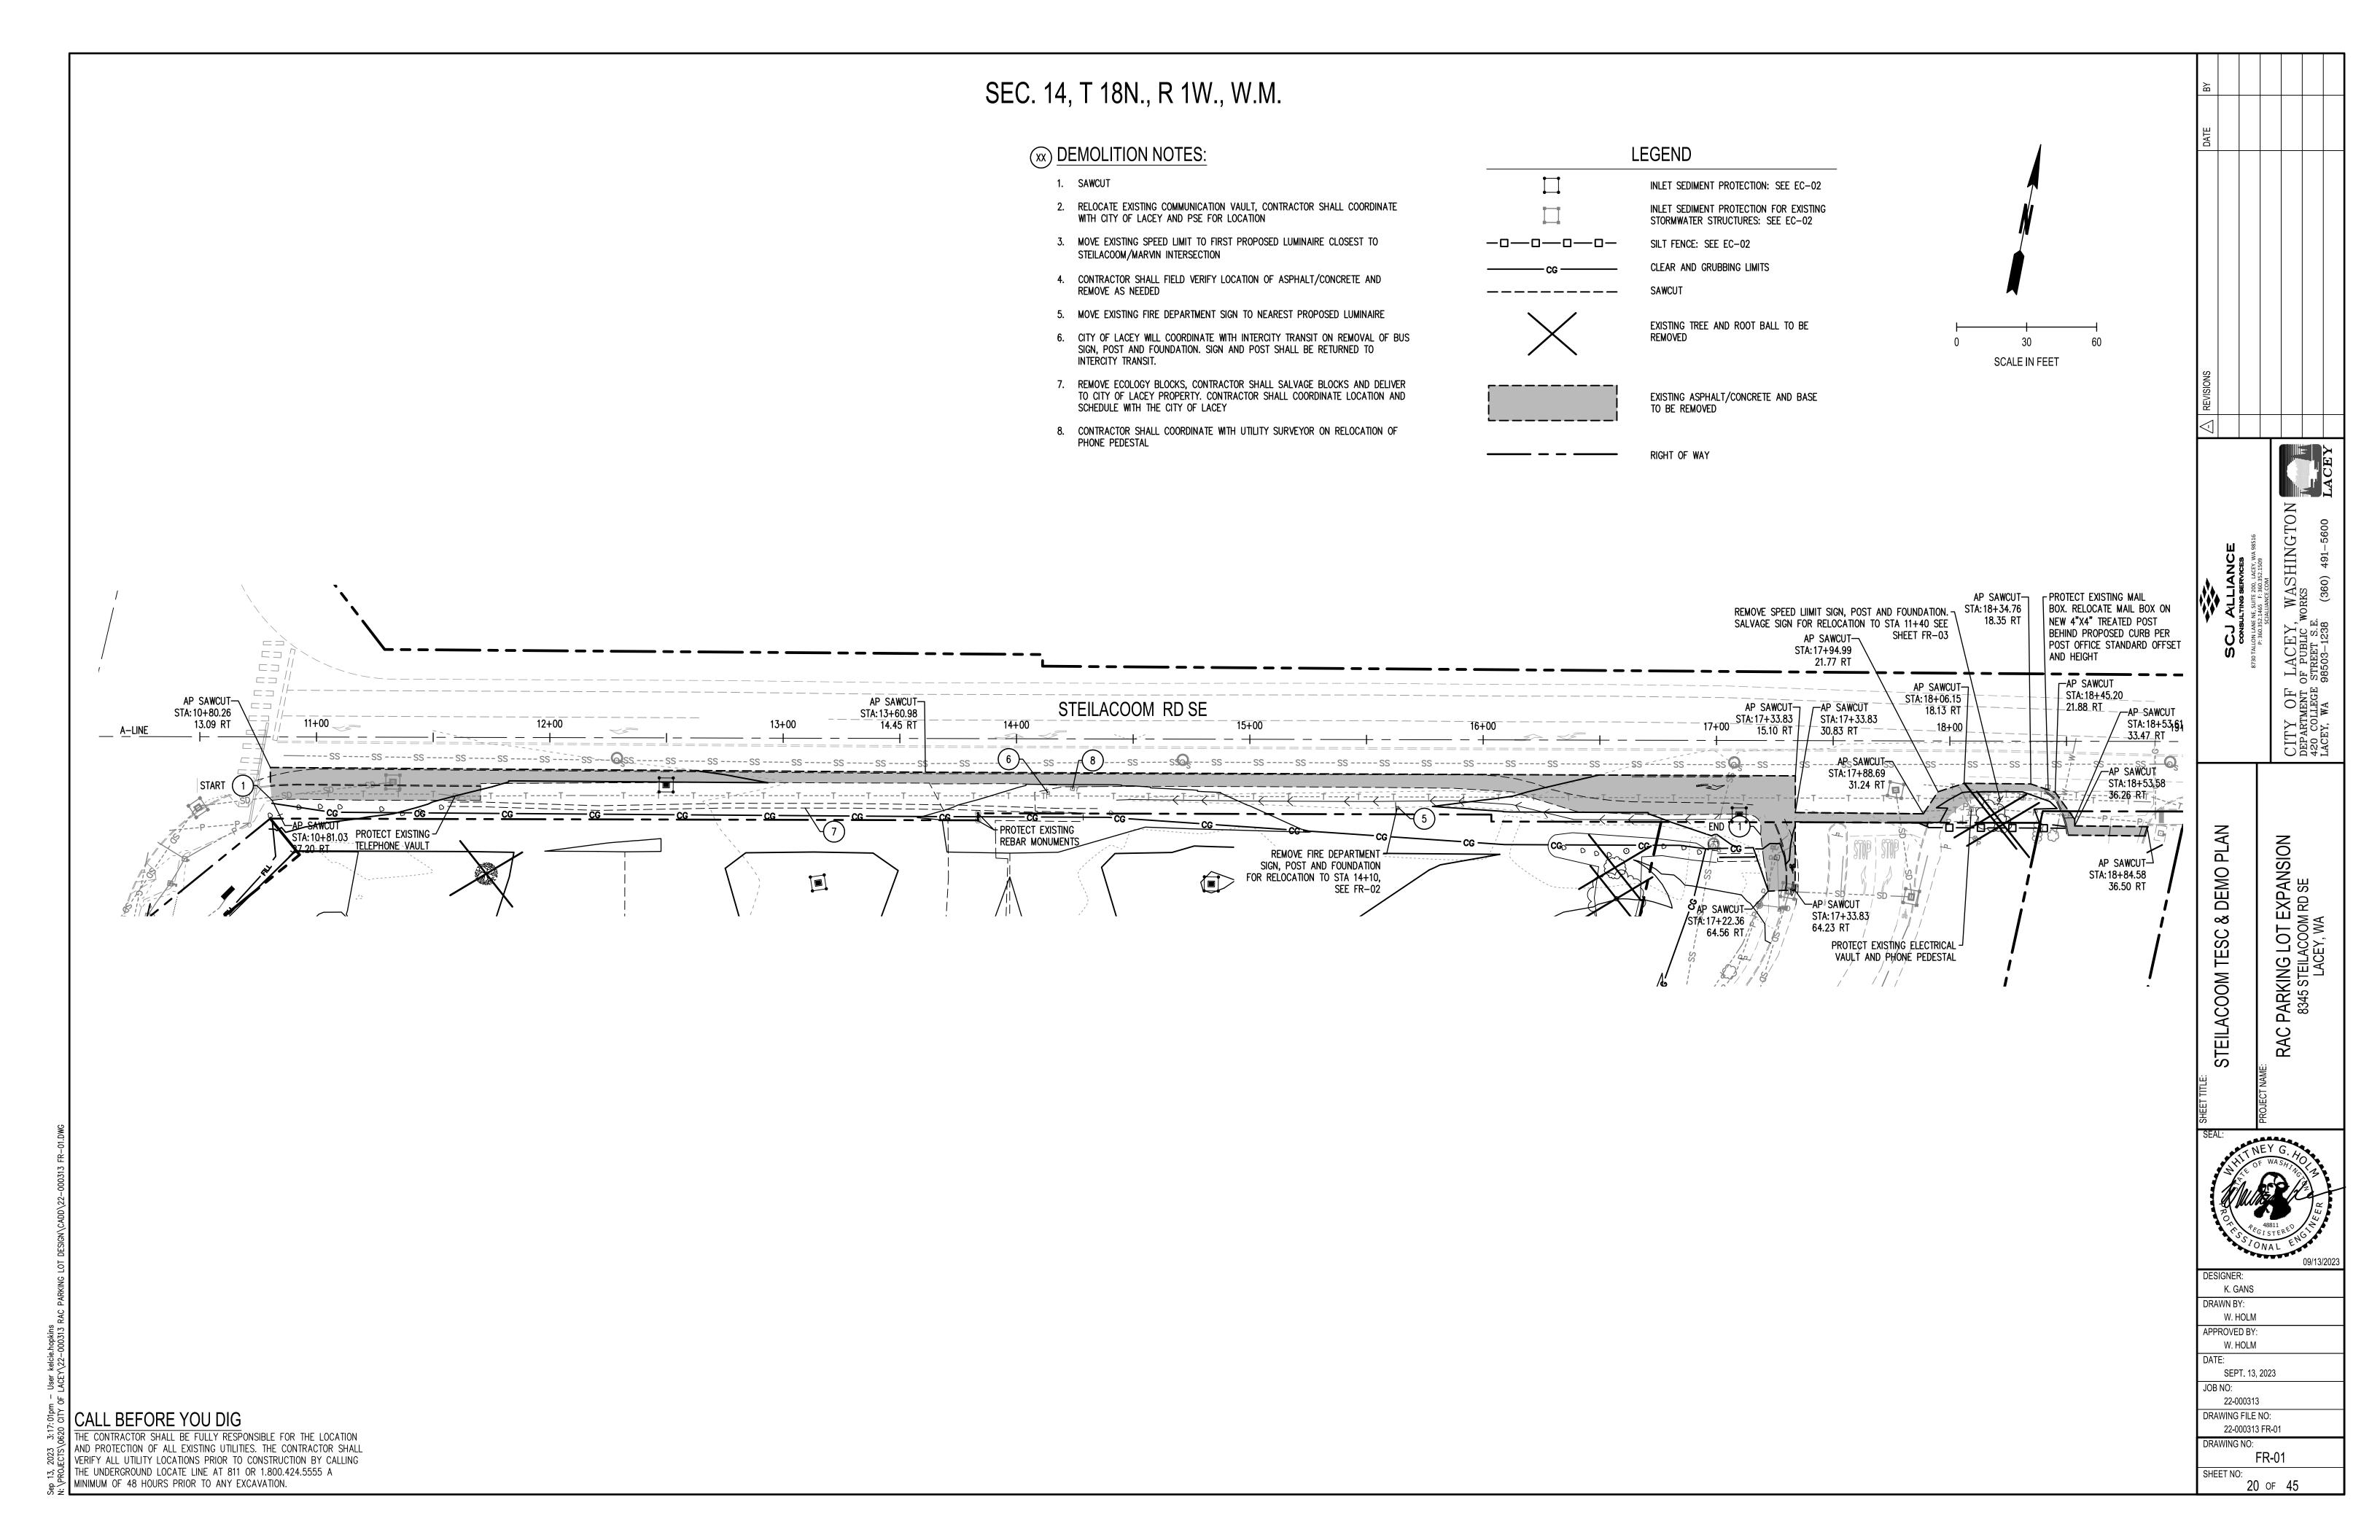

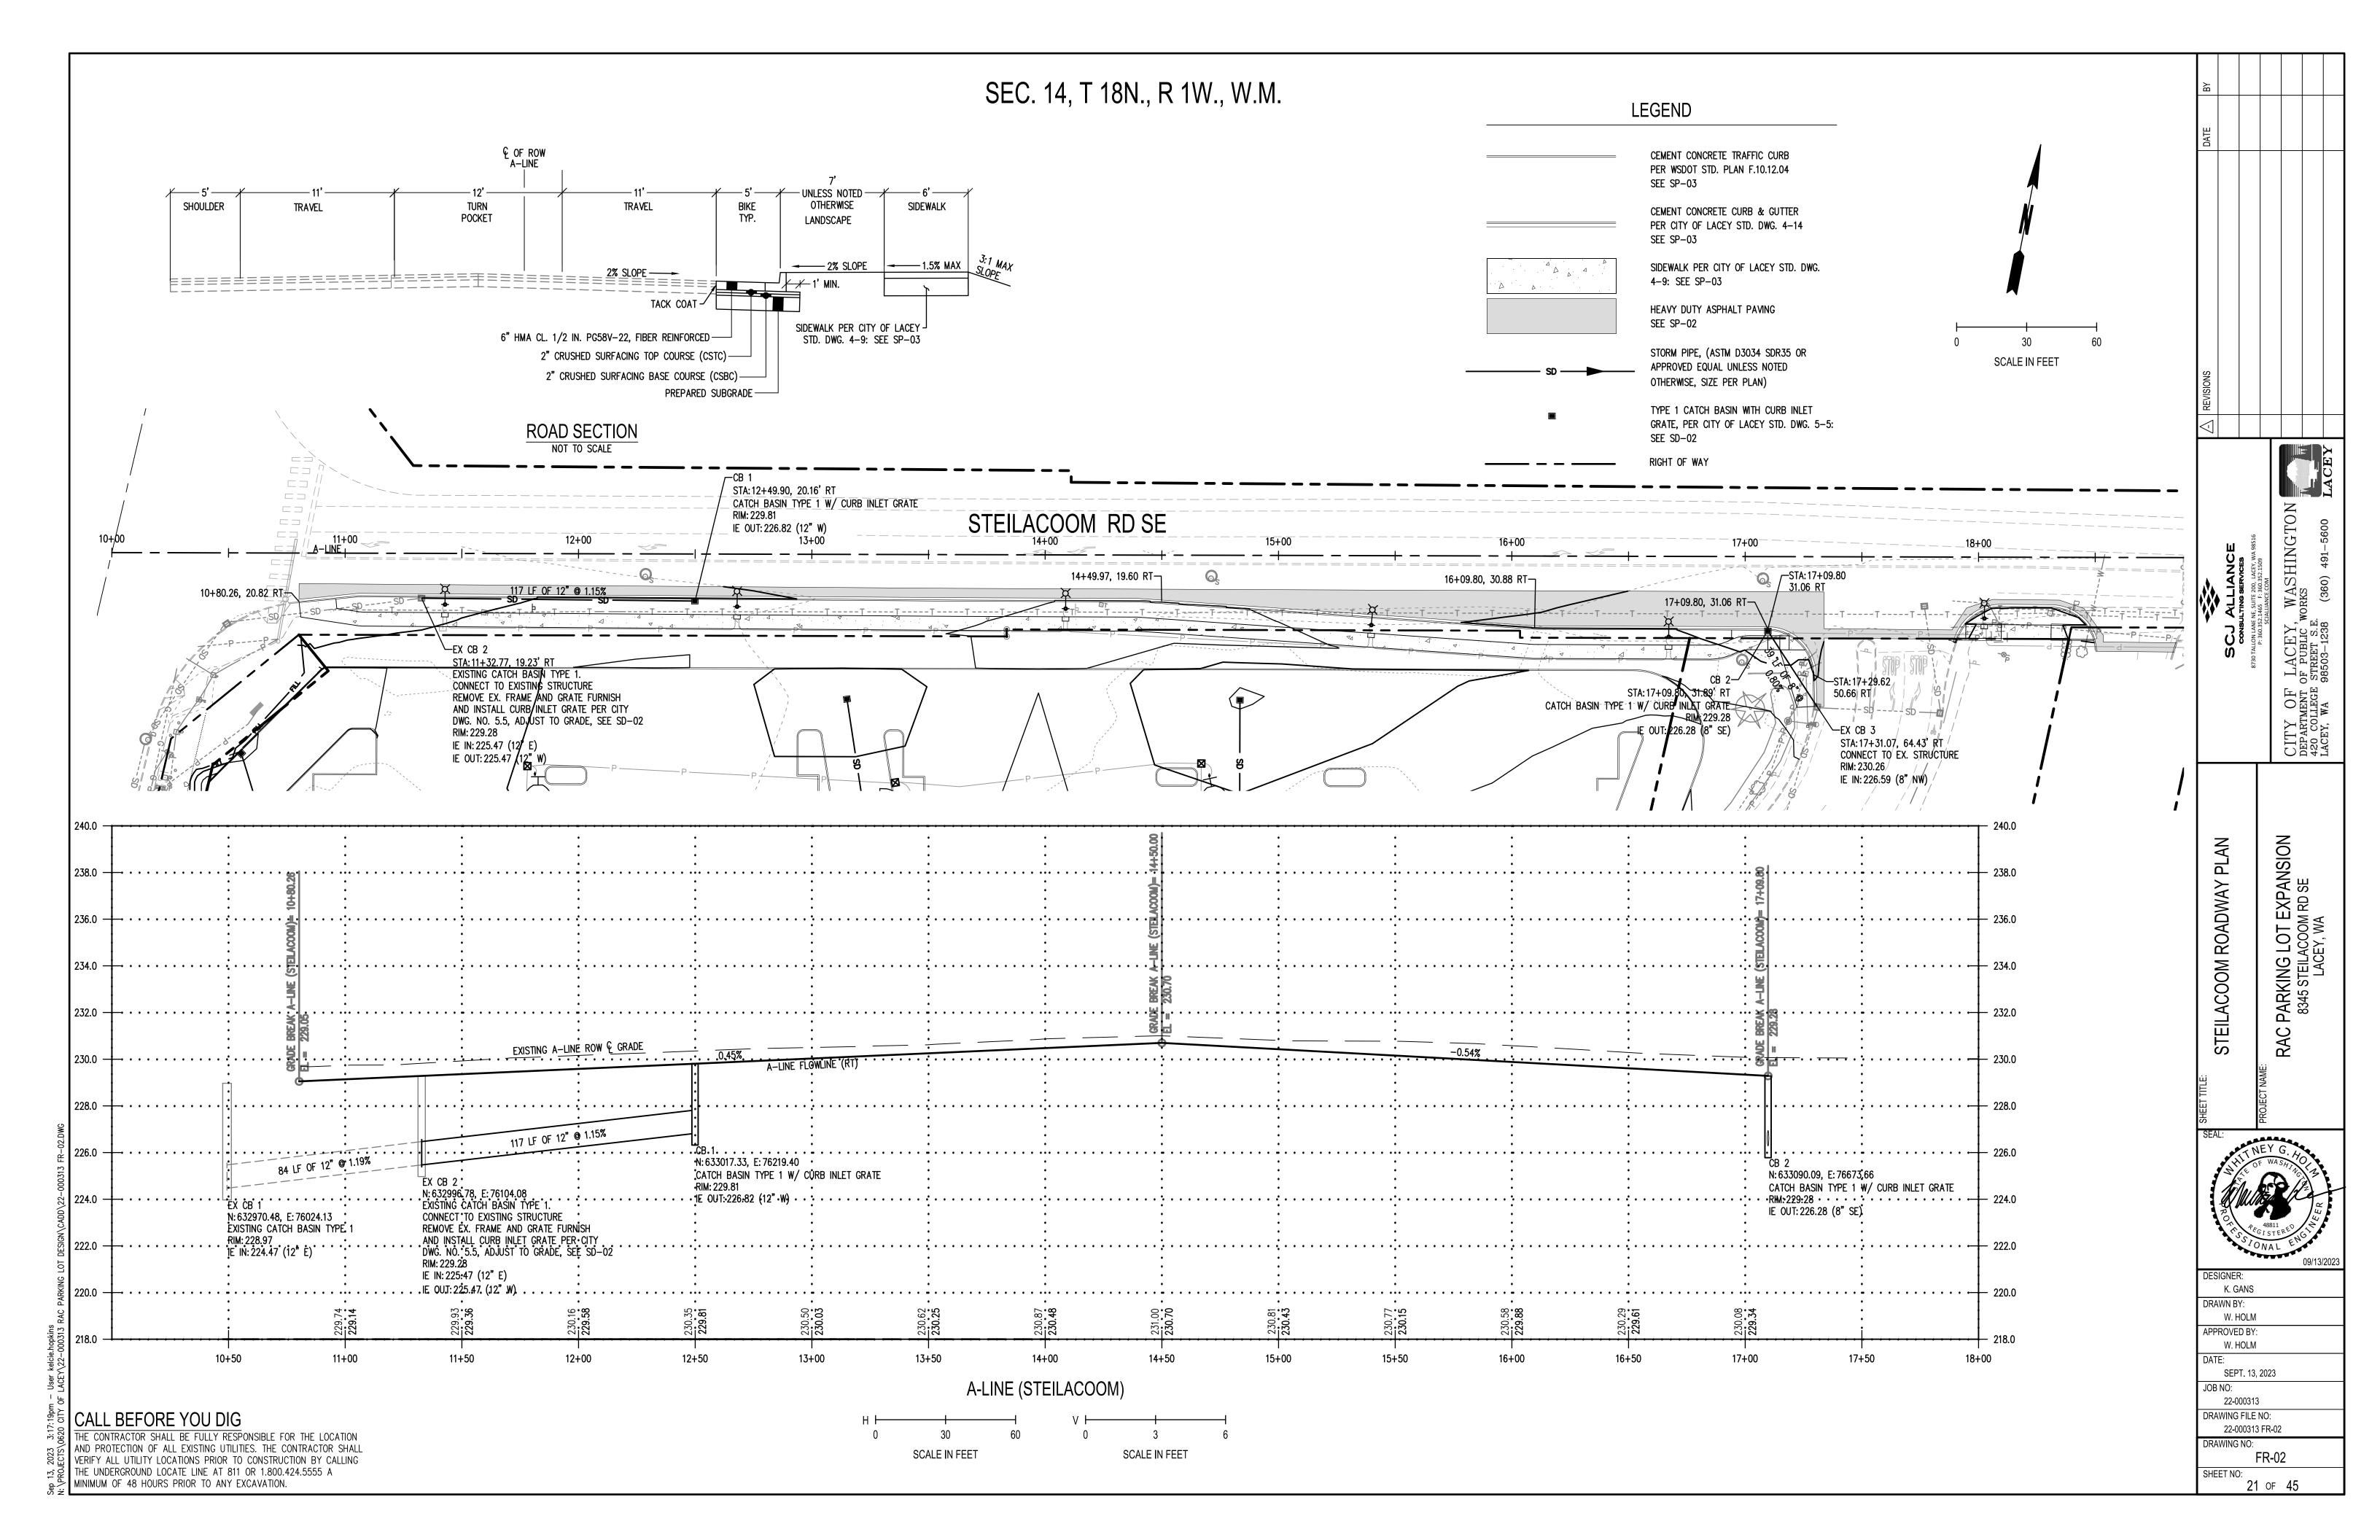

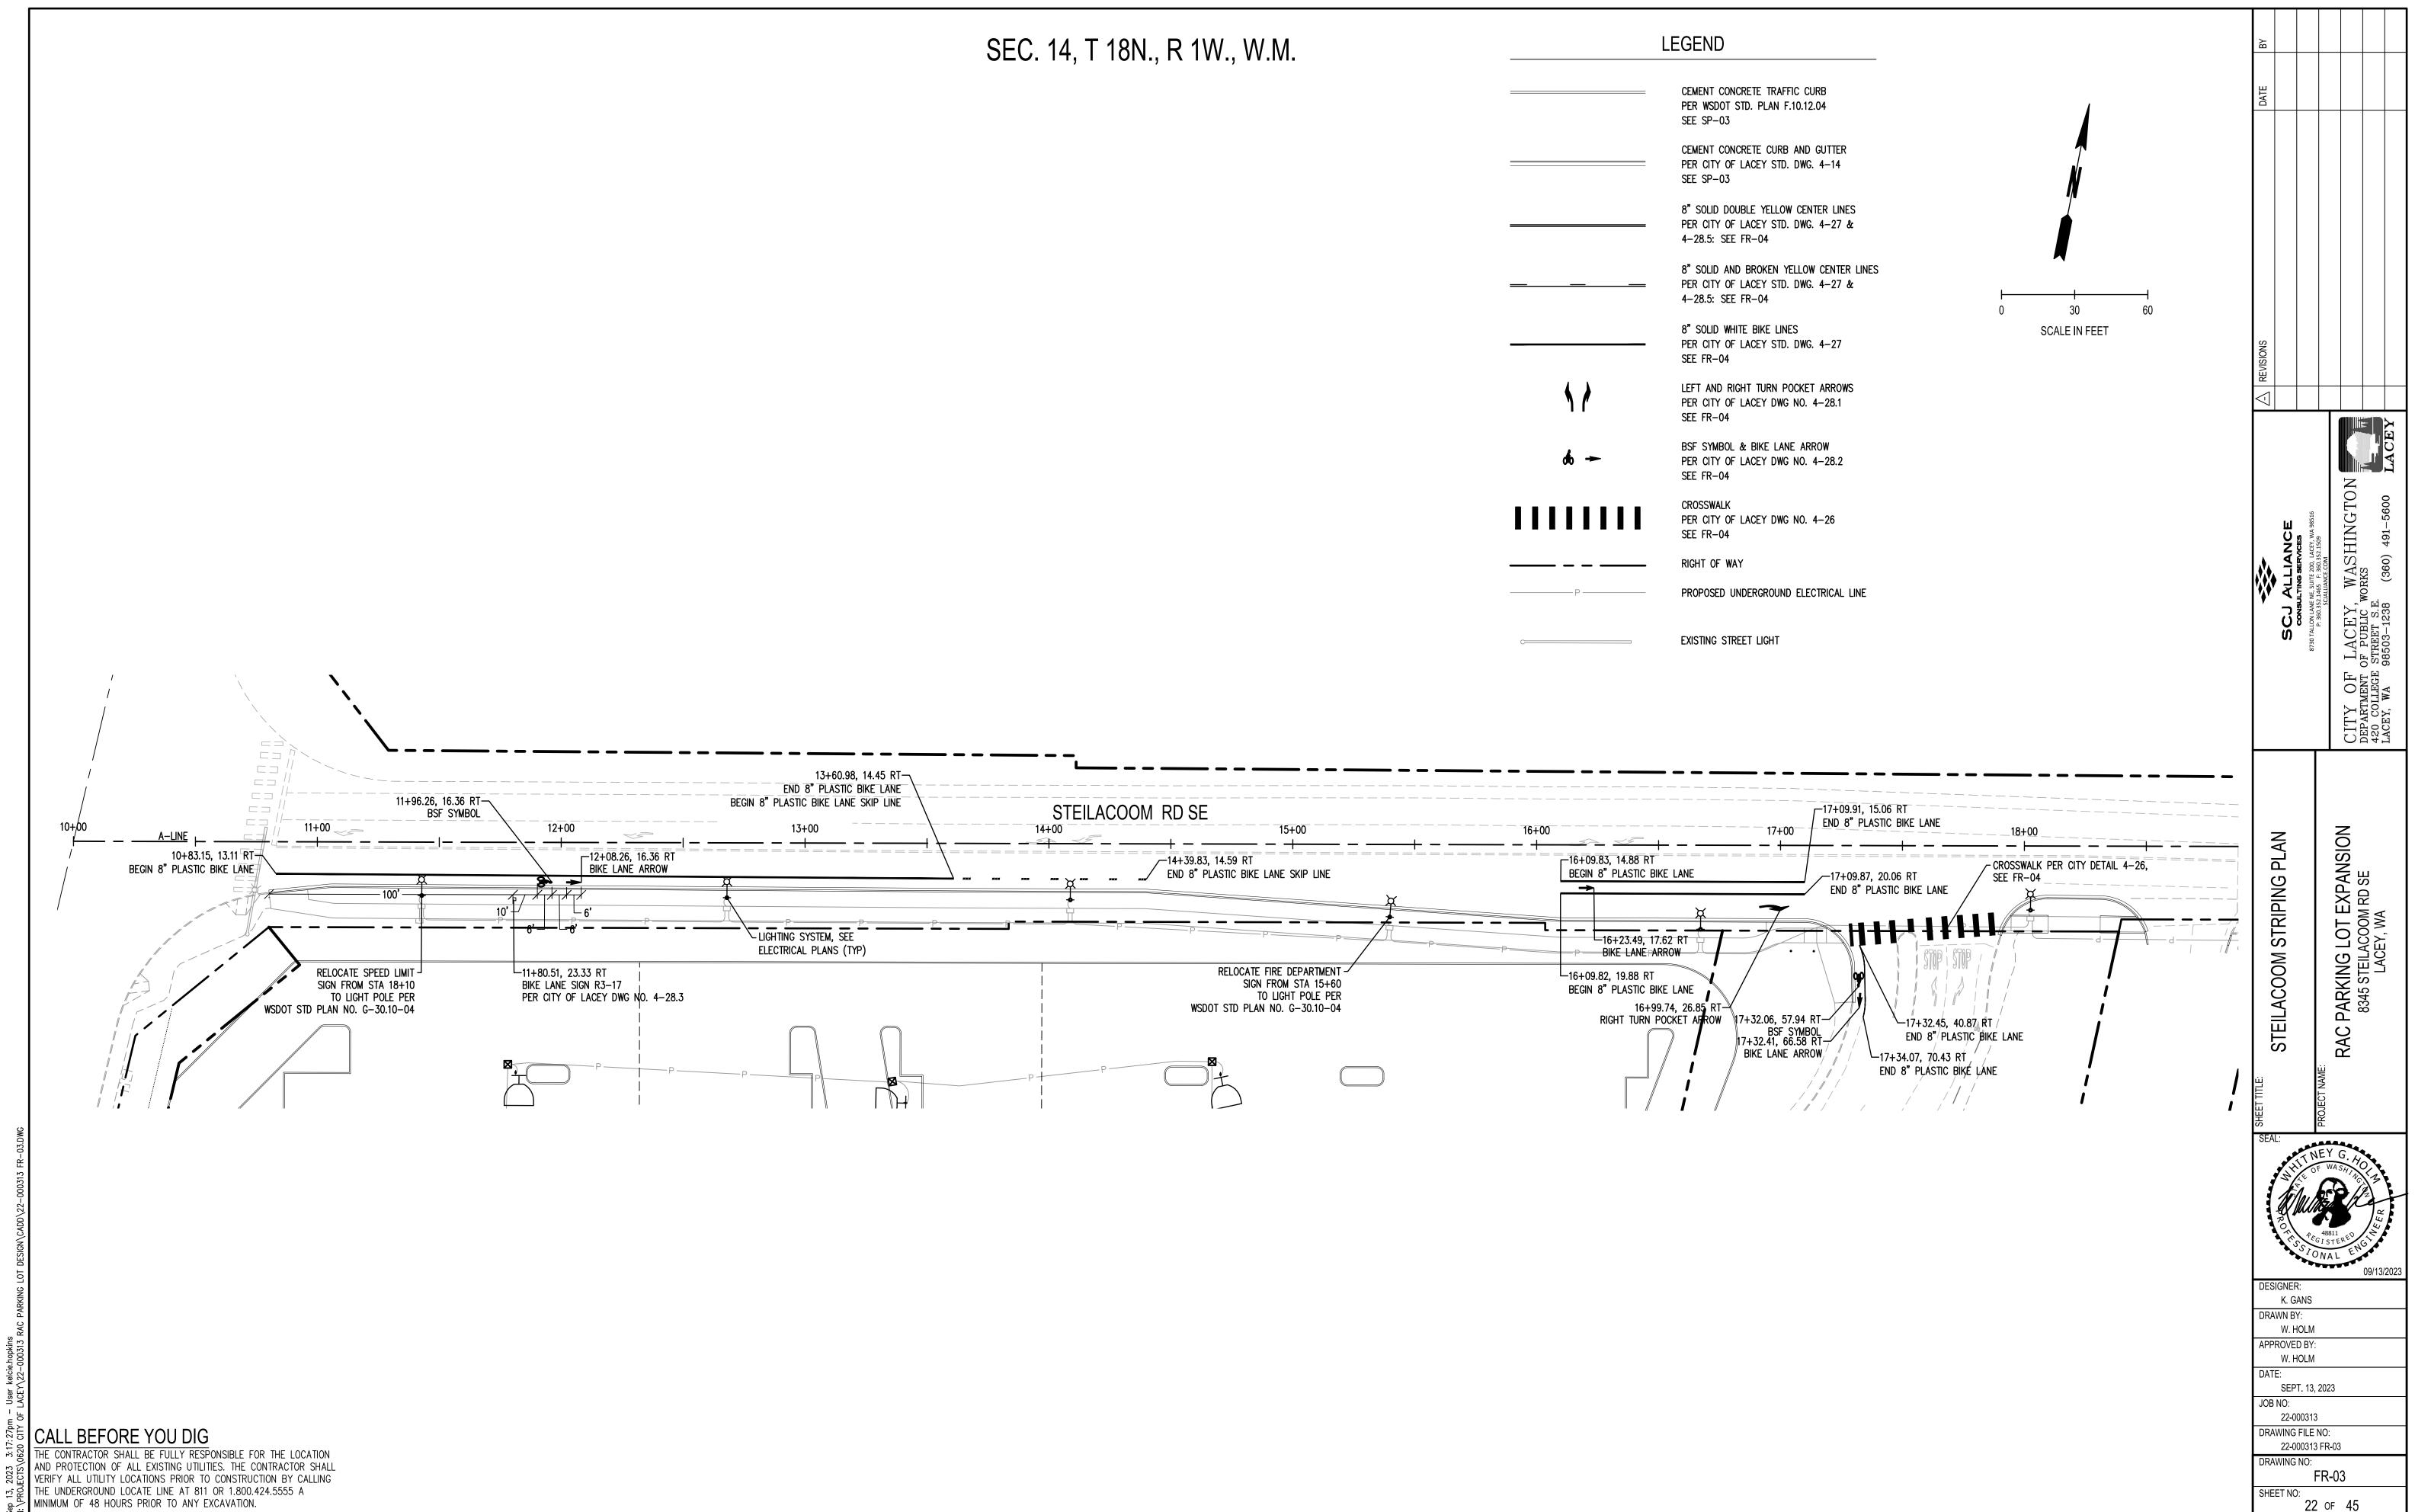

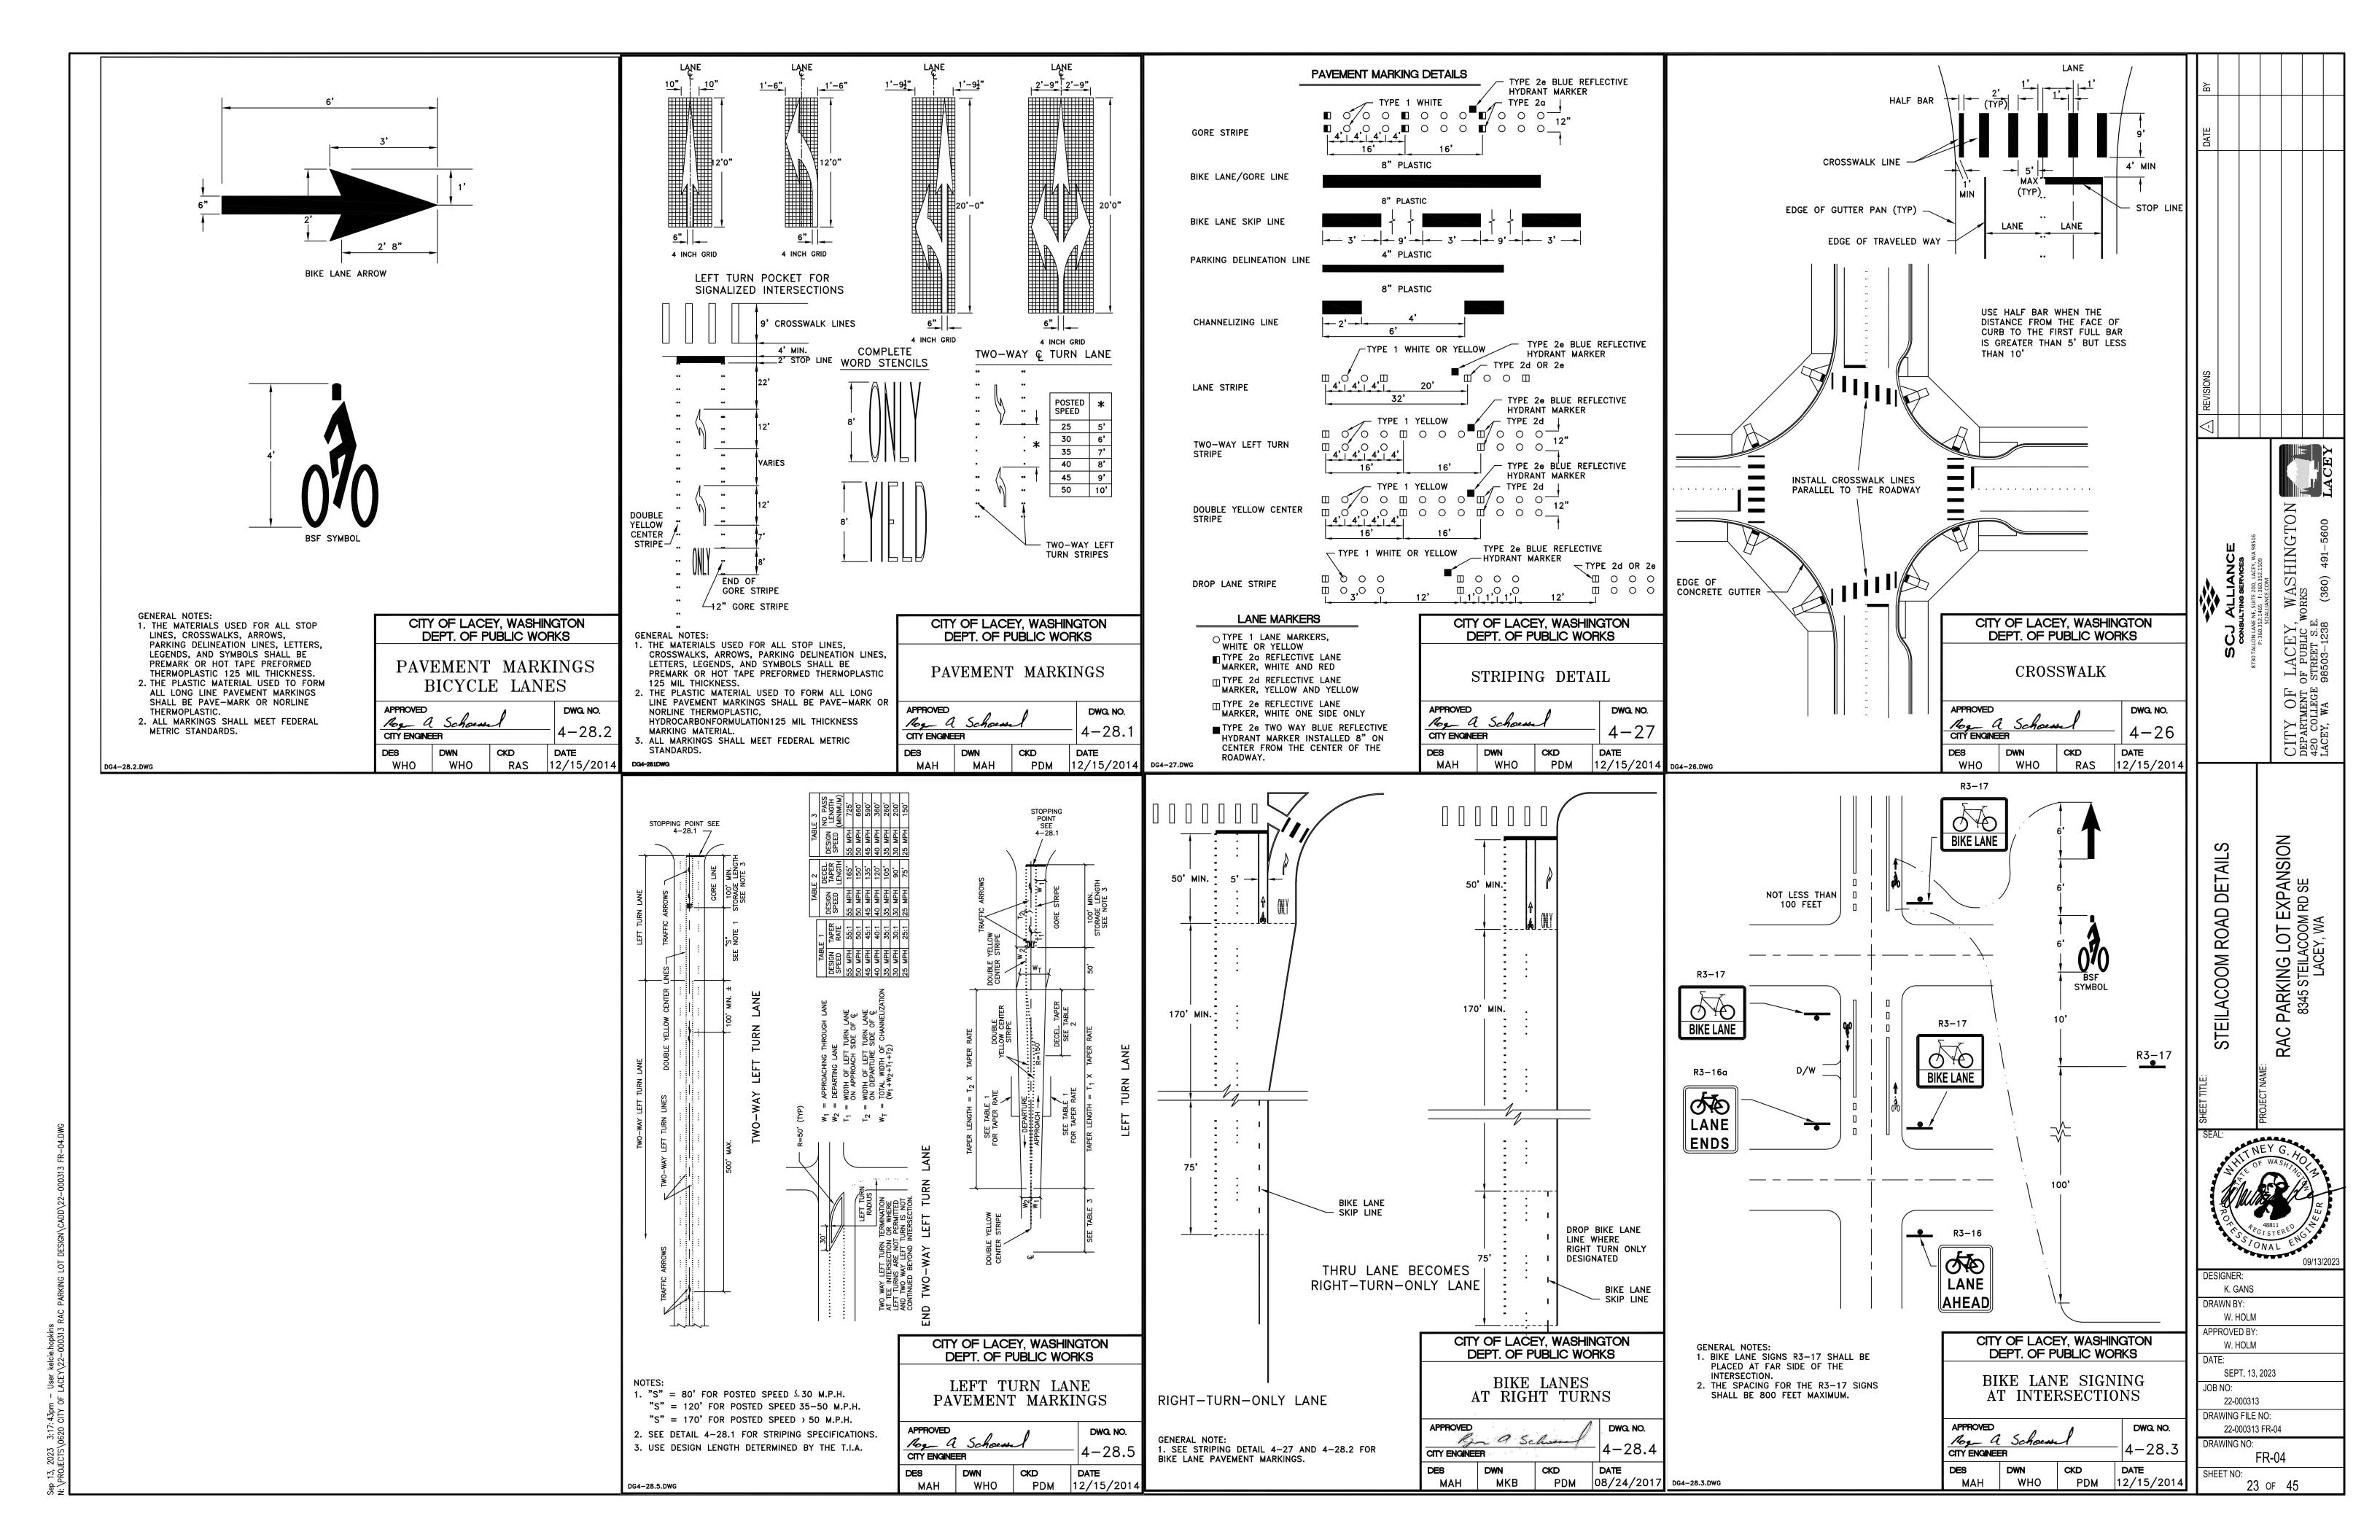

DESCRIPTION

DETAIL

HYDROSEED STANDARD LAWN MIX, SEE SPECIFICATIONS FOR ADDITIONAL INFORMATION

COLORED & STAMPED CONCRETE UTILIZING MEDIUM GRAY COLOR WITH CHARGREEN RELEASE AGENT WITH SAND BLAST FINISH. TOOLED CONTROL JOINTS

AS NOTED IN DETAIL.

COLORED CONCRETE WITH BOMANITE -COBBLESTONE GRAY (OR APPROVED EQUAL). WITH 5 O.C. TOOLED SCORING - SEE CIVIL PLANS FOR

CONCRETE DETAILS.

DESCRIPTION

STANDARD CONCRETE

PLAZA SEAT WALL, STANDARD CONCRETE COLOR 5/LS-05

> ADD SPECIFIED ROOT BARRIER ALONG NEW CONCRETE SIDEWALK WITHIN 8' OF TREE TRUNK.

6" CONCRETE MOW STRIP

5` X 5` KIVA TREE GRATE AS AVAILABLE FROM URBAN ACCESSORIES (PH: 877-487-0488) OR APPROVED

BASEBALL STITCHING - BRICKS SET ON END,

EQUAL

10 CAULKED EXPANSION JOINT - AT 15' O.C. OR AS

ADDITIONAL INFORMATION.

CENTERED ALONG EXPANSION JOINT.

11 TOOLED CONTROL JOINT, SEE DETAIL FOR

STREET TREE WITH EDGING - TYP. ALL NEW STREET **TREES**


GENERAL NOTES (ALL SHEETS)

SHOWN

- SOIL PREPARATION (LAWN AND ALL LANDSCAPE AREAS). SPREAD TOPSOIL 'A' TO A DEPTH OF 12" IN ALL BEDS AND 3" DEPTH IN LAWN AREAS. SPREAD 100 LBS./1000 S.F. OF DOLOMITE LIME (IN LAWN AREAS ONLY), 150 LBS./1000 S.F. OF AGRICULTURAL GYPSUM AND 15 LBS./1000 S.F. OF 16-8-8 COMMERCIAL FERTILIZER OVER SOIL AMENDMENT. ROTO-TILL ALL OF THE ABOVE TO A 6"-8" DEPTH AND GRADE SMOOTH, COMPACTING AS REQUIRED AND REMOVING ALL ROCKS, CLODS AND DEBRIS.
- 2. ALL PLANTING BEDS TO BE DRESSED WITH 3" OF BARK MULCH.

SHEET NOTES

- REFER TO DETAILS AND SPECIAL PROVISIONS FOR ADDITIONAL INFORMATION.
- 2. ALL PLANTS MUST BE APPROVED BY PROJECT ENGINEER PRIOR TO INSTALLATION.
- NO PLANT SUBSTITUTIONS SHALL BE PERMITTED WITHOUT PRIOR APPROVAL OF PROJECT ENGINEER.
- PLANT LIST QUANTITIES ARE SHOWN FOR REFERENCE ONLY. CONTRACTOR IS RESPONSIBLE FOR VERIFYING ALL QUANTITIES IN LIST WITH ACTUAL PLAN CALL-OUTS, AND INSTALLING PLANTINGS PER THE LANDSCAPE PLAN. GROUNDCOVER QUANTITIES SHALL BE ADJUSTED AS REQUIRED FOR FIELD CONDITIONS AT THE SPECIFIED SPACING.
- ALL WORK SHALL BE PERFORMED TO THE SATISFACTION OF THE PROJECT ENGINEER.

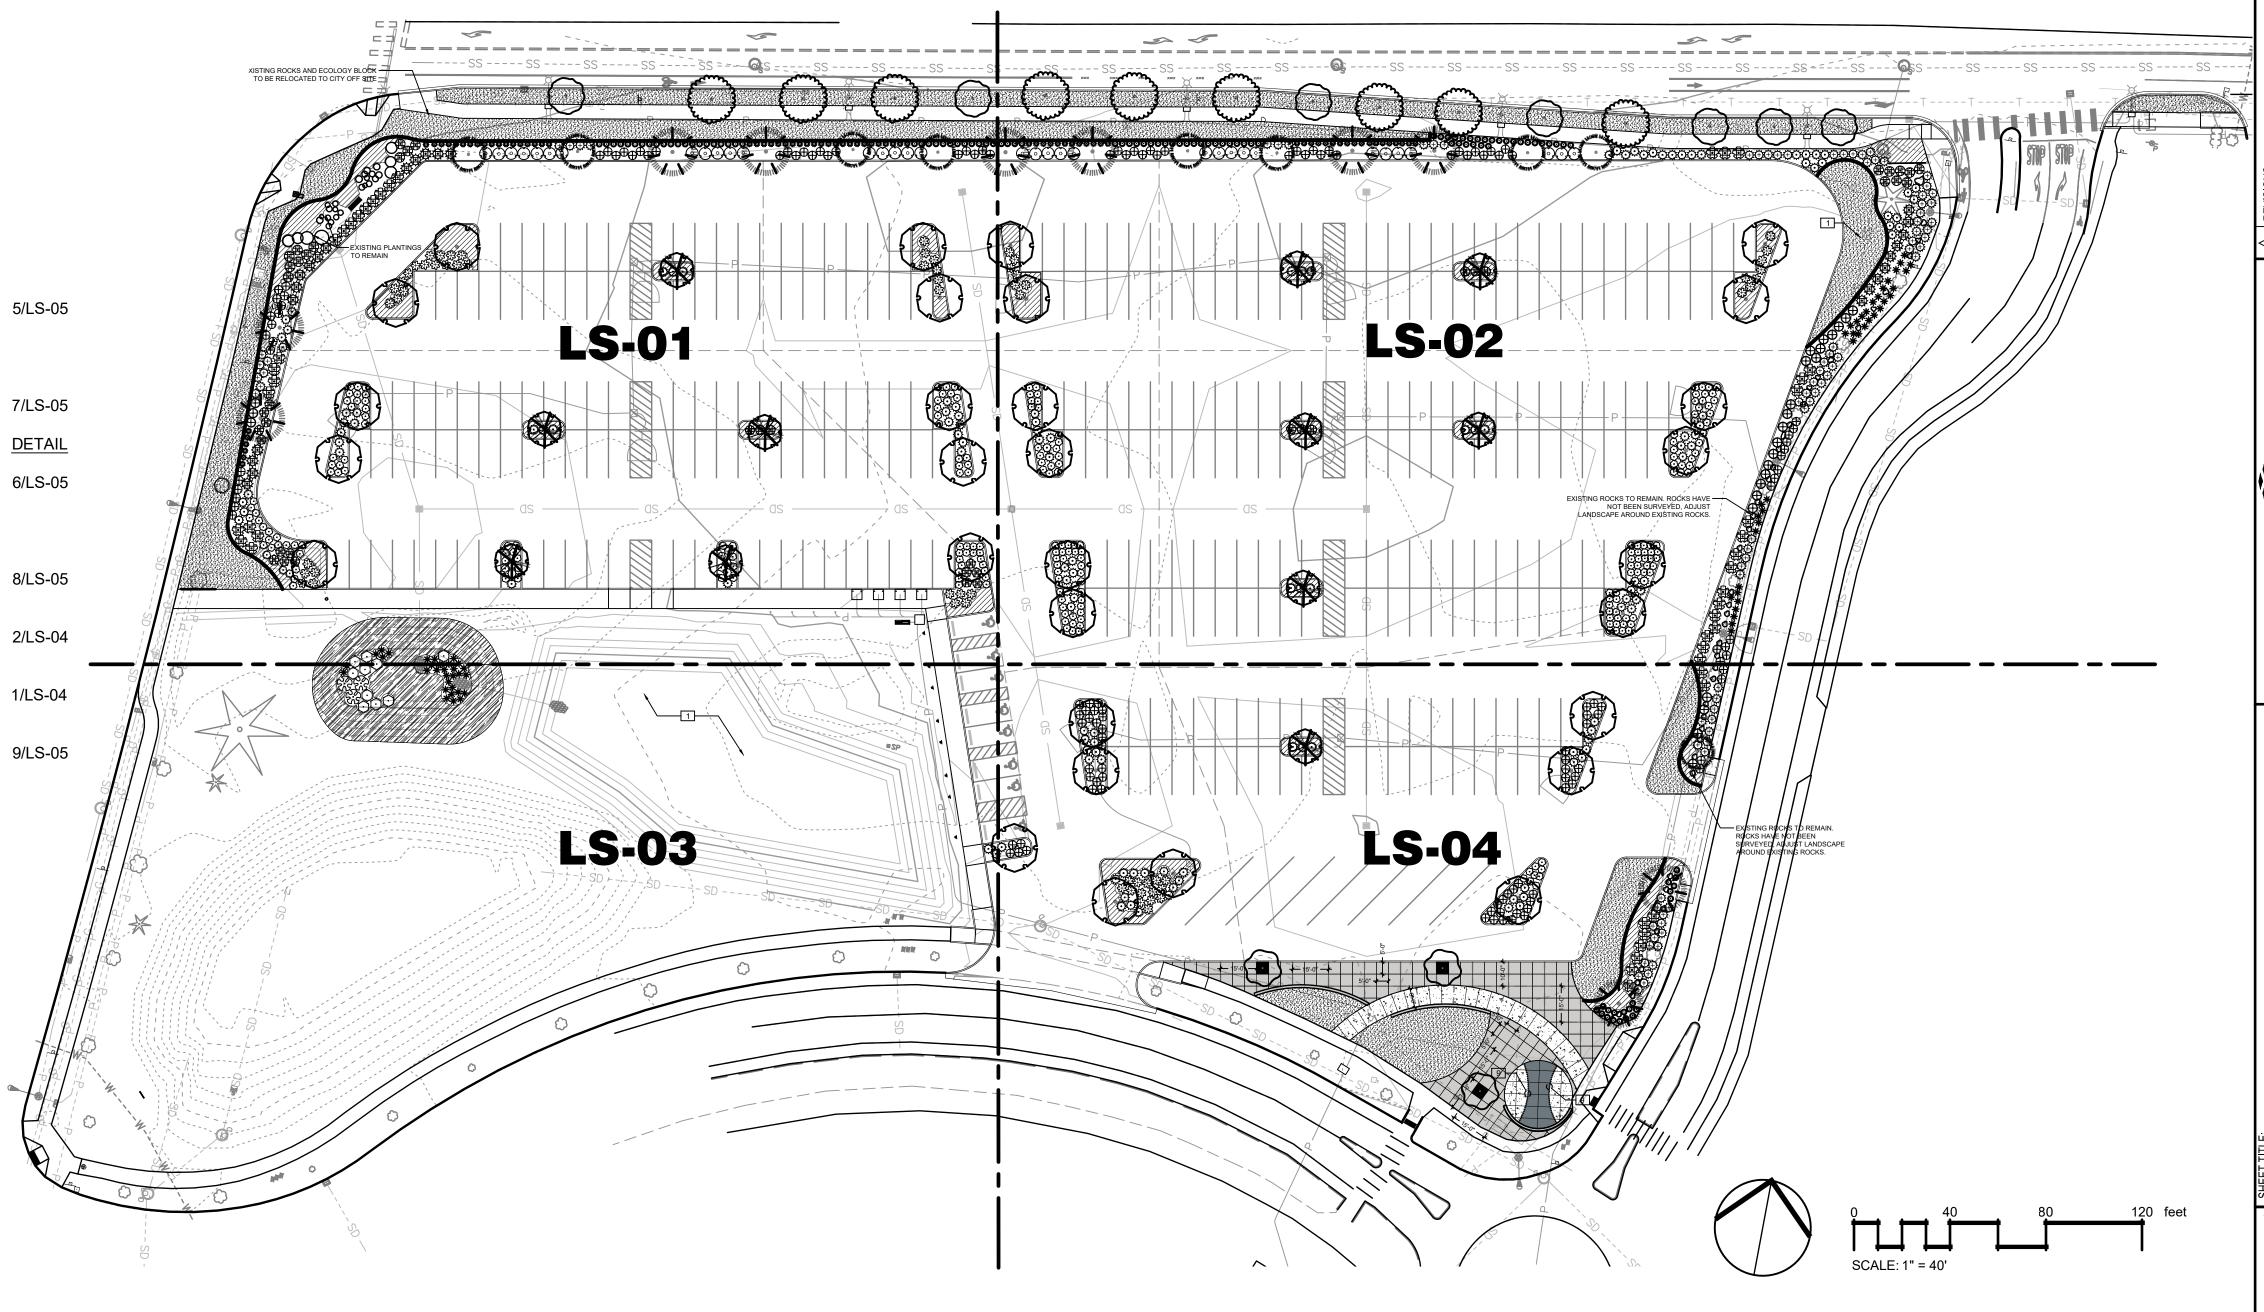

CITY OF DEPARTMENT 420 COLLEGE

SION

PLAN

LANDSCAPE

NORTHWEST

DESIGNER:

DRAWN BY:

APPROVED BY: J. GLANDER

JOB NO:

T. GRANTHAM

T. GRANTHAM

SEPT. 13, 2023

22-000313 X-LS

LS-00

25 of 45

22-000313

DRAWING FILE NO:

DRAWING NO:

SHEET NO:

THE CONTRACTOR SHALL BE FULLY RESPONSIBLE FOR THE LOCATION AND PROTECTION OF ALL EXISTING UTILITIES. THE CONTRACTOR SHALL VERIFY ALL UTILITY LOCATIONS PRIOR TO CONSTRUCTION BY CALLING THE UNDERGROUND LOCATE LINE AT 811 OR 1.800.424.5555 A MINIMUM OF 48 HOURS PRIOR TO ANY EXCAVATION.

CALL BEFORE YOU DIG


PLANT SC	<u>HED</u>			
TREES	QTY	BOTANICAL / COMMON NAME	SIZE	DESC.
	5	ACER GRISEUM 'JFS KW8AGRI' FIREBURST PAPERBARK MAPLE	2" CAL.	2" CAL., 8`-10` HT.
	10	CERCIDIPHYLLUM JAPONICUM KATSURA 5' BRANCHING HT.	2" CAL., B&B/ CONT.	12`-14` HT.
	4	CHAMAECYPARIS NOOTKATENSIS 'PENDULA' WEEPING ALASKA CEDAR	8` HT. MIN.	B&B/ CONT.
THE THE PARTY OF T	4	CHAMAECYPARIS OBTUSA 'GRACILIS' SLENDER HINOKI CYPRESS	8` HT. MIN.	B&B/ CONT.
0	2	CORNUS KOUSA KOUSA DOGWOOD	1 1/2" CAL	6`-8` HT., B&B
£()	3	FAGUS SYLVATICA 'ROSEOMARGINATA' PINK EDGED BEECH	2" CAL., B&B/ CONT.	12`-14` HT.
SHRUBS	QTY	BOTANICAL / COMMON NAME	SIZE	SPACING
(18	ABELIA X GRANDIFLORA 'LITTLE RICHARD' ' LITTLE RICHARD' ABELIA	5 GAL	4` O.C.
\$; ;}	33	BERBERIS THUNBERGII 'CRIMSON PYGMY' 'CRIMSON PYGMY' BARBERRY	2 GAL	3.5` O.C.
EW.	47	CALAMAGROSTIS X ACUTIFLORA 'KARL FOERSTER' 'KARL FOERSTER' GRASS	2 GAL	3° O.C.
	18	CEANOTHUS X 'JULIA PHELPS' CEANOTHUS	5 GAL	6` O.C.
\bigoplus	38	DAPHNE ODORA WINTER DAPHNE	2 GAL	3.5` O.C.
*	10	JUNCUS EFFUSUS SOFT RUSH	1 GAL	3' O.C.
	15	KALMIA LATIFOLIA `MINUET` 'MINUET' KALMIA	5 GAL	5` O.C.
MAKE.	33	NANDINA DOMESTICA 'FIREHOUSE' 'FIREHOUSE' NANDINA	2 GAL	2-1/2` O.C.
₹ • }	37	PIERIS JAPONICA `MOUNTAIN FIRE` 'MOUNTAIN FIRE' PIERIS	5 GAL	4` O.C.
\odot	95	POTENTILLA FRUTICOSA 'FLOPPY DISC' 'FLOPPY DISC' CINQUIFOIL	1 GAL	3` O.C.
	17	PRUNUS LAUROCERASUS 'OTTO LUYKEN' 'OTTO LUYKEN' LAUREL	21"-24" HT., B&B	5` O.C.
\odot	4	ROSA NUTKANA NOOTKA ROSE	1 GAL	5` O.C.
	11	SPIRAEA DOUGLASII DOUGLAS SPIREA	5 GAL	4` O.C.
\oplus	3	SPIRAEA JAPONICA 'GOLDMOUND' 'GOLDMOUND' SPIREA	3 GAL	4` O.C.
}+ }	11	TSUGA CANADENSIS `GENTSH WHITE` 'GEBTSH WHITE' HEMLOCK	5 GAL	4` O.C.
GROUND COVERS	QTY	BOTANICAL / COMMON NAME	SIZE	SPACING
	477	CAREX OBNUPTA SLOUGH SEDGE	4"POT	18" O.C.
	255	PRUNUS LAUROCERASUS 'MOUNT VERNON' 'MT. VERNON' LAUREL	1 GAL	2-1/2` O.C.

REFERENCE NOTES SCHEDULE LS-01


SYMBOL	DESCRIPTION	<u>DETAIL</u>
1	HYDROSEED STANDARD LAWN MIX, SEE SPECIFICATIONS FOR ADDITIONAL INFORMATION	
 6	INSTALL SPECIFIED ROOT BARRIER ALONG NEW CONCRETE SIDEWALK WITHIN 8' OF TREE TRUNK OF THIS EXISTING TREE TO REMAIN.	1/LS-03
 7	6" CONCRETE MOW STRIP	7/LS-05
12	STREET TREE WITH EDGING - TYP. ALL NEW STREET TREES	1/LS-03
13	REMOVABLE BOLLARD	9/LS-05


CALL BEFORE YOU DIG

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CITY DEPART 420 COI LACEY.

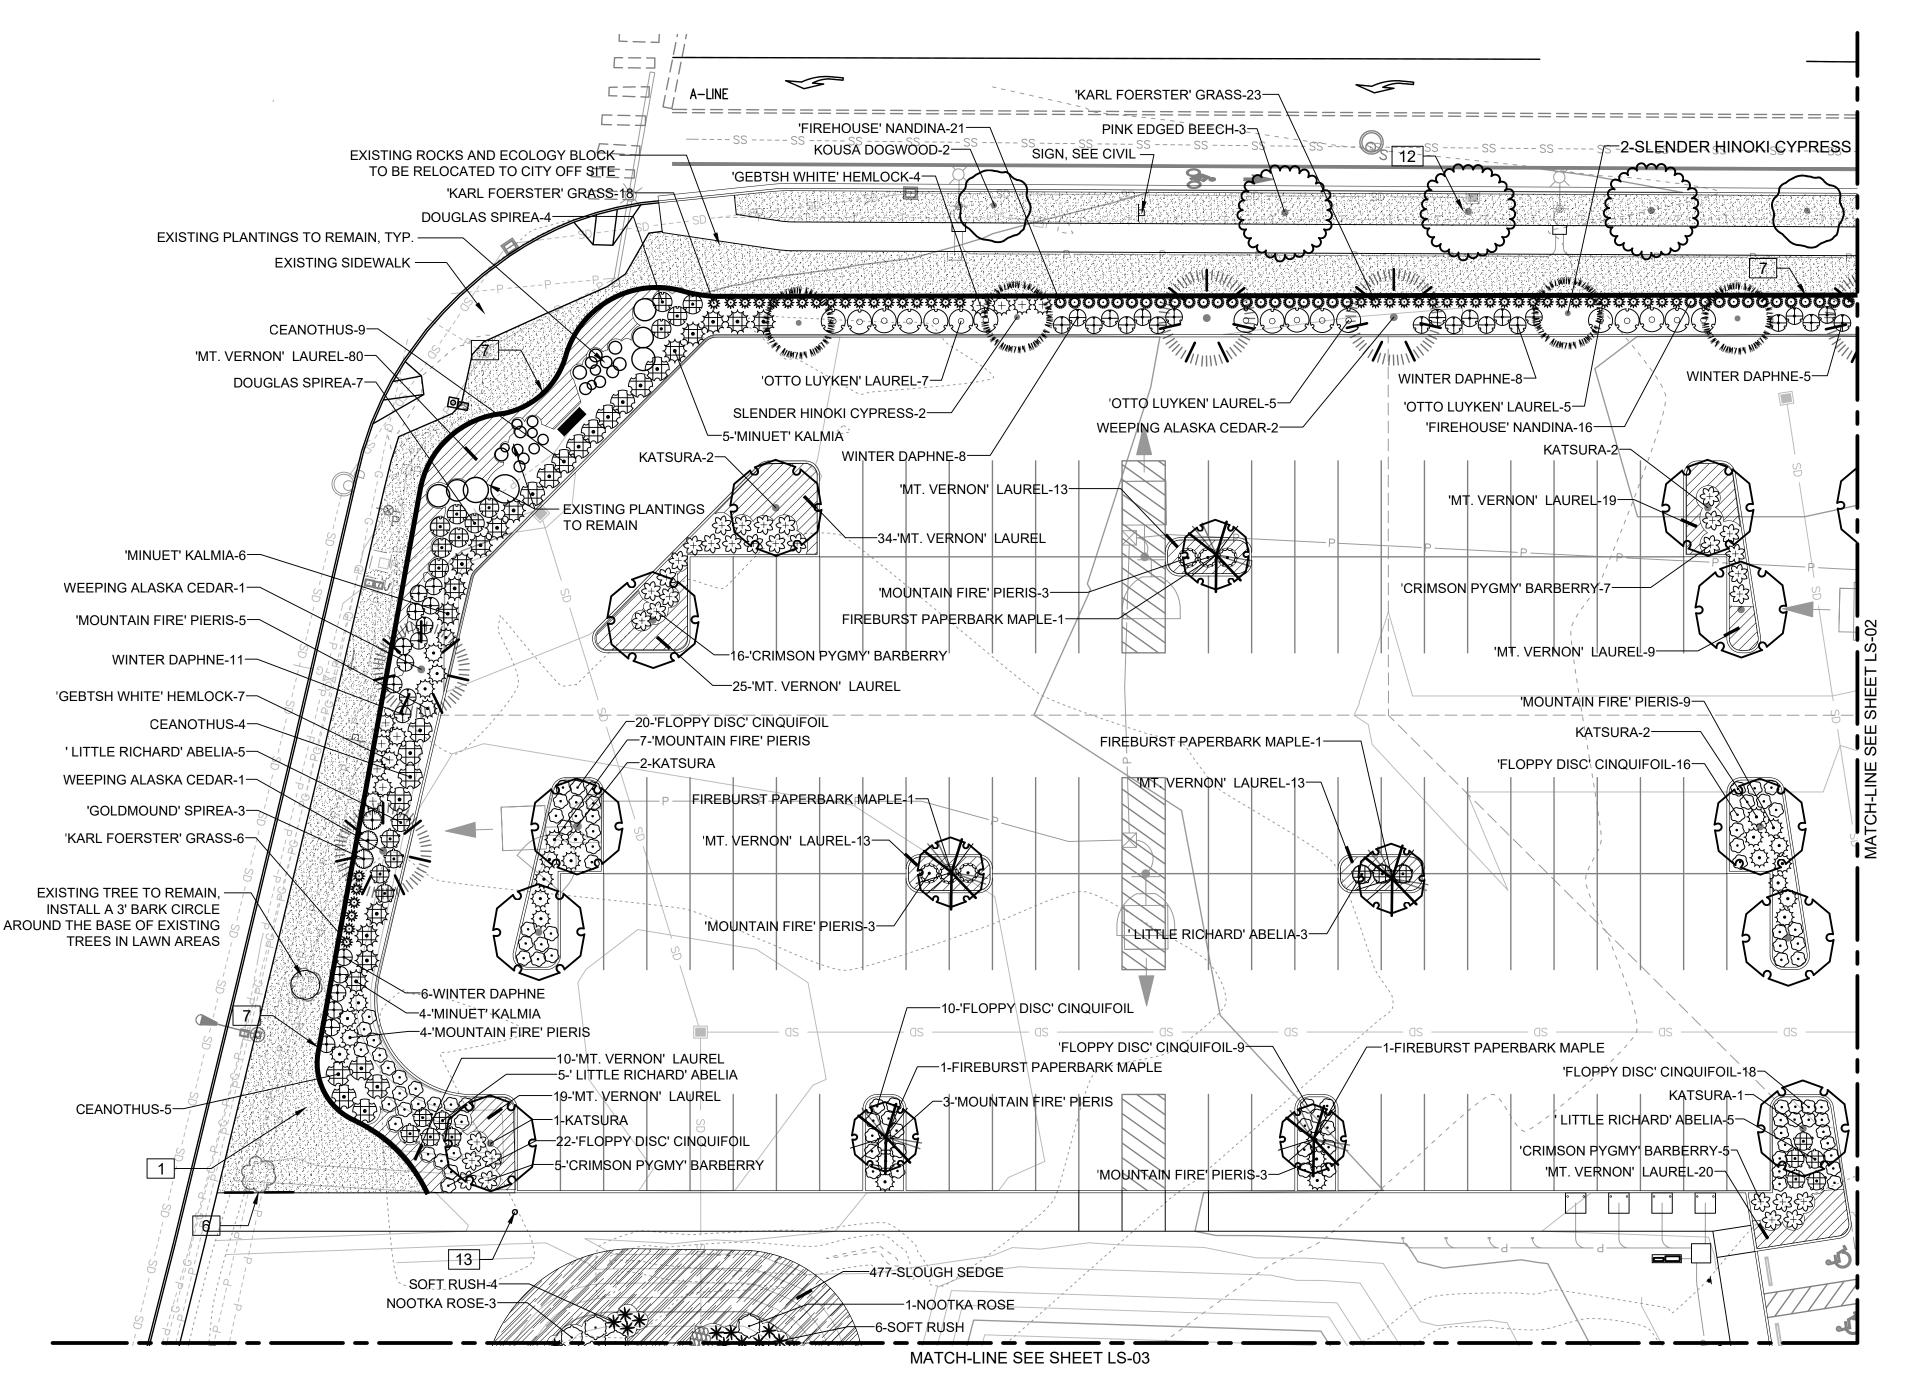NOISN

LANDSAPE

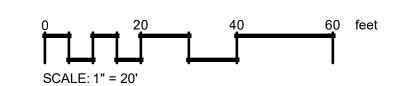NORTHEAST

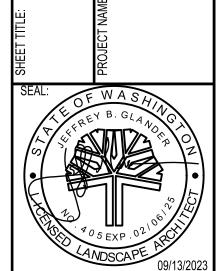S PARKING LOT EXPANS 8345 STEILACOOM RD SE LACEY, WA

RAC

DESIGNER:
T. GRANTHAM


DRAWN BY:
T. GRANTHAM


APPROVED BY:
J. GLANDER

DATE:
SEPT. 13, 2023

JOB NO:
22-000313

DRAWING FILE NO:

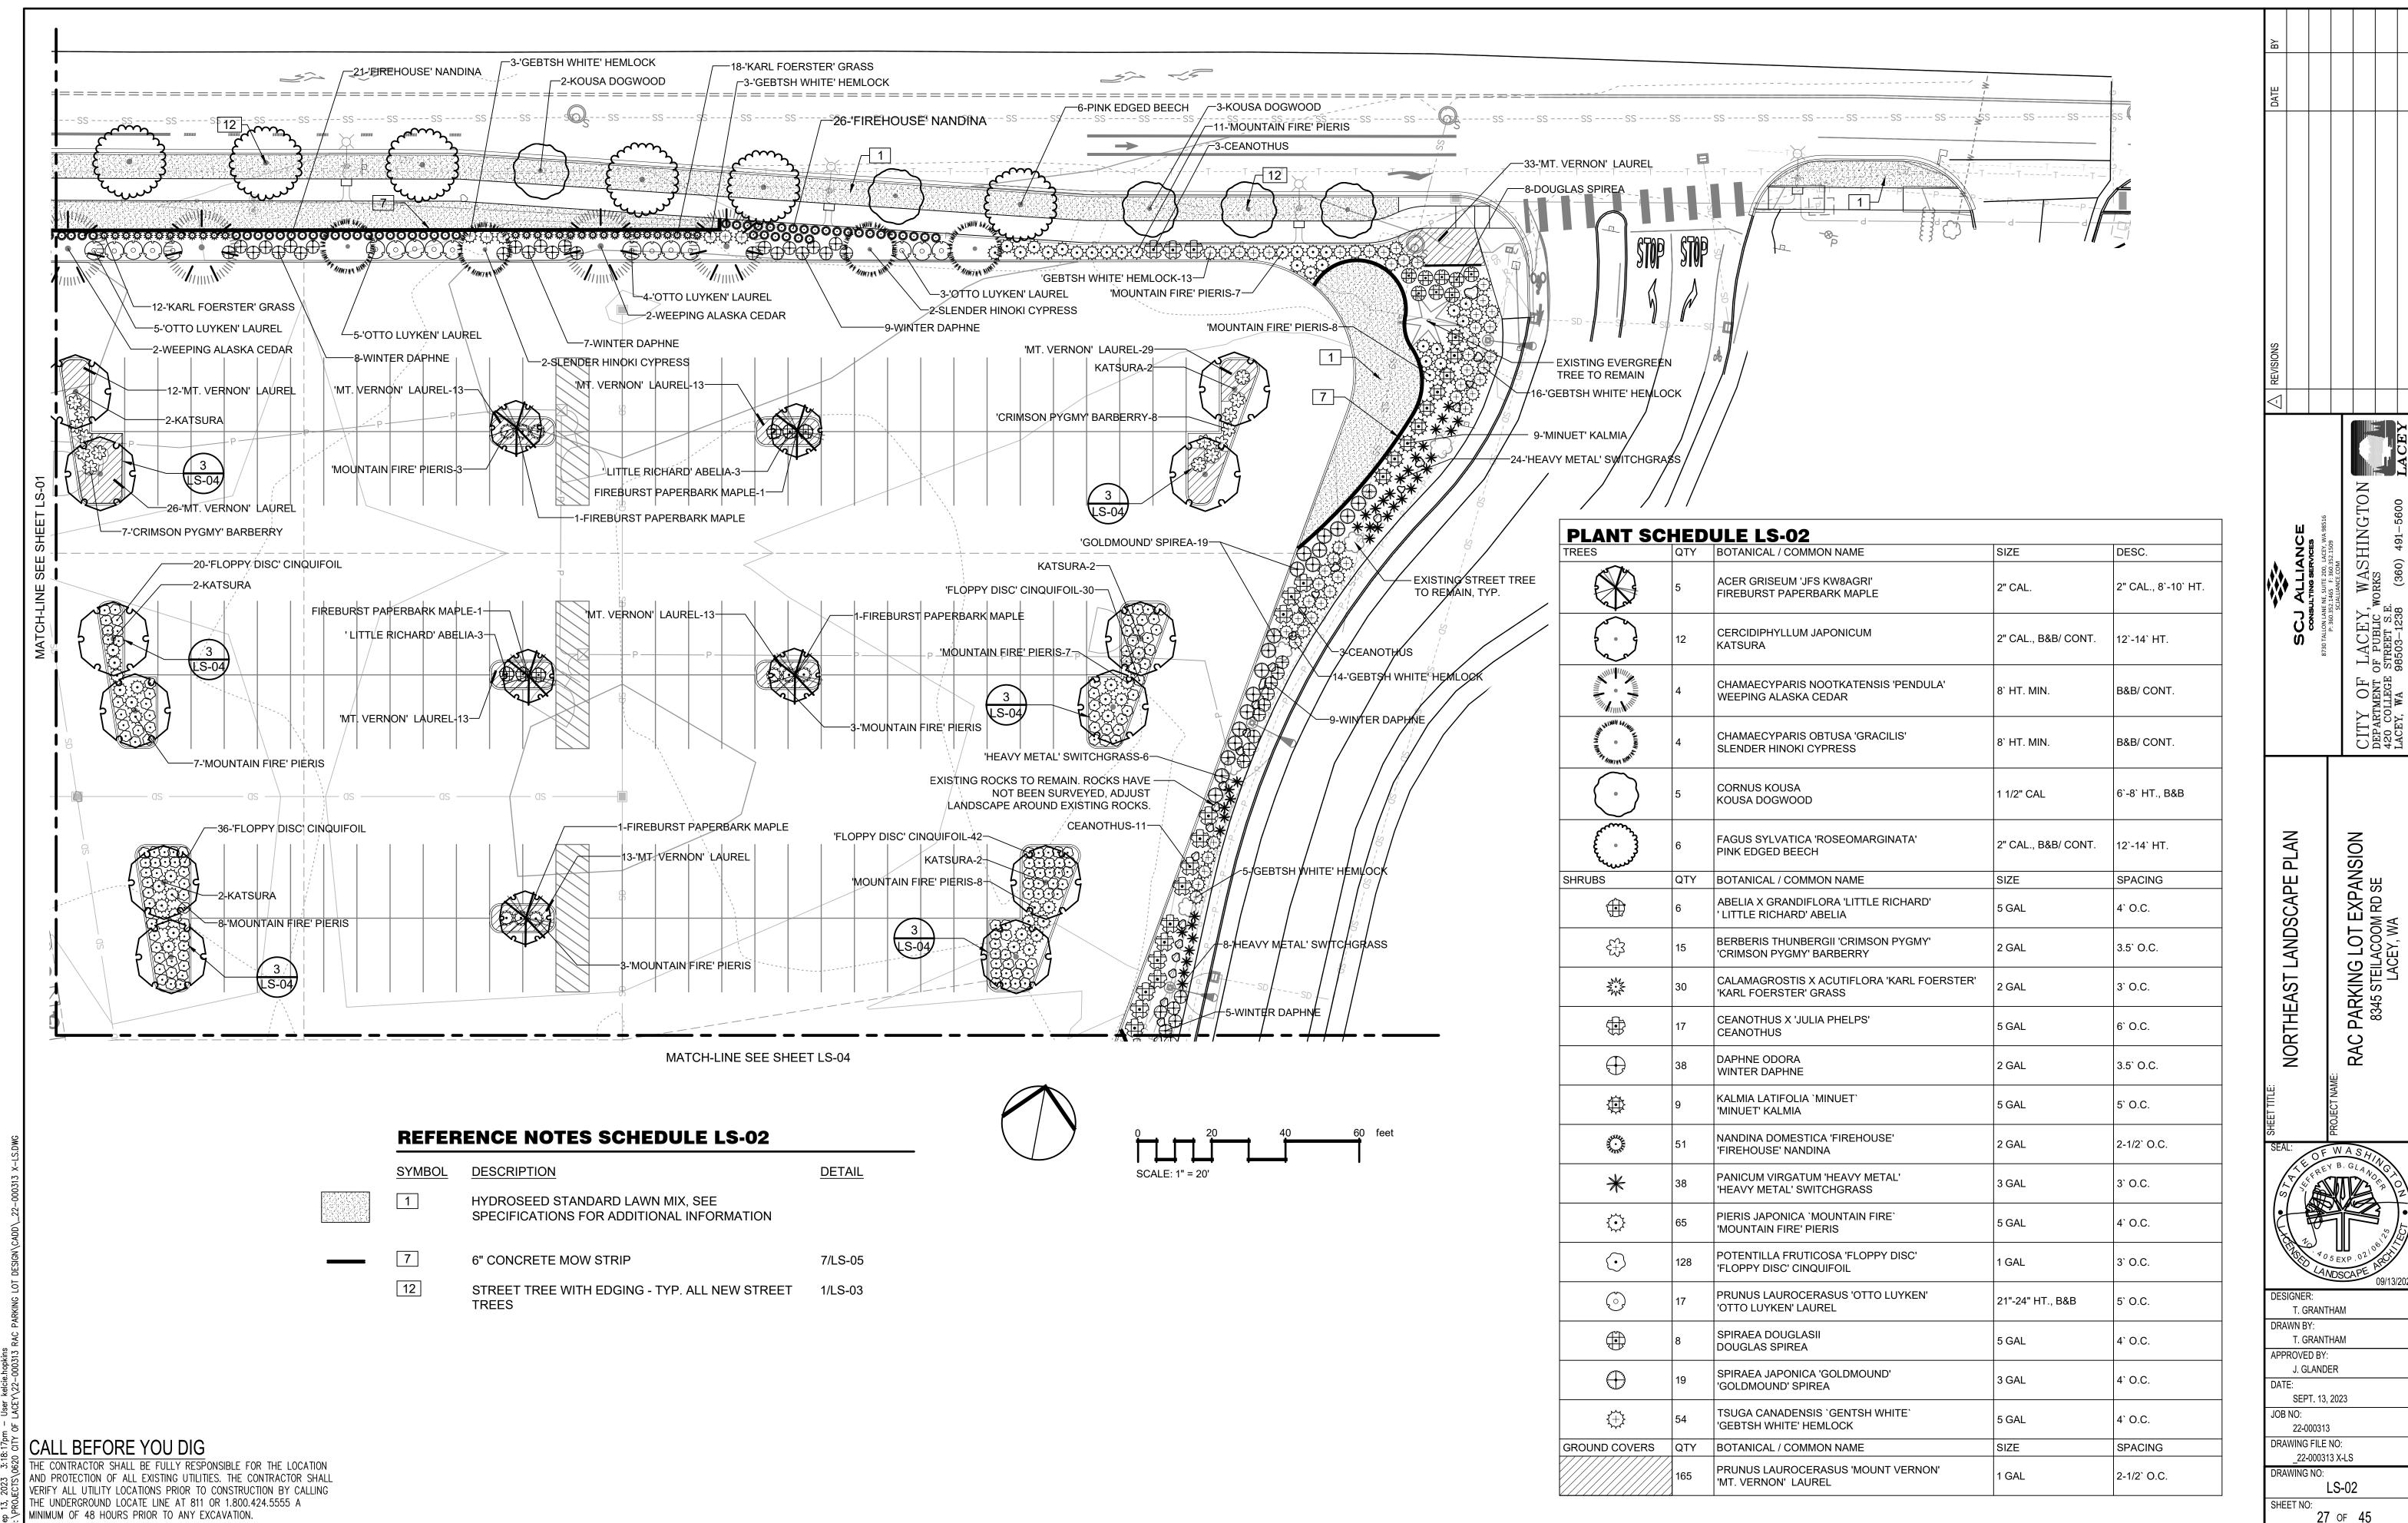

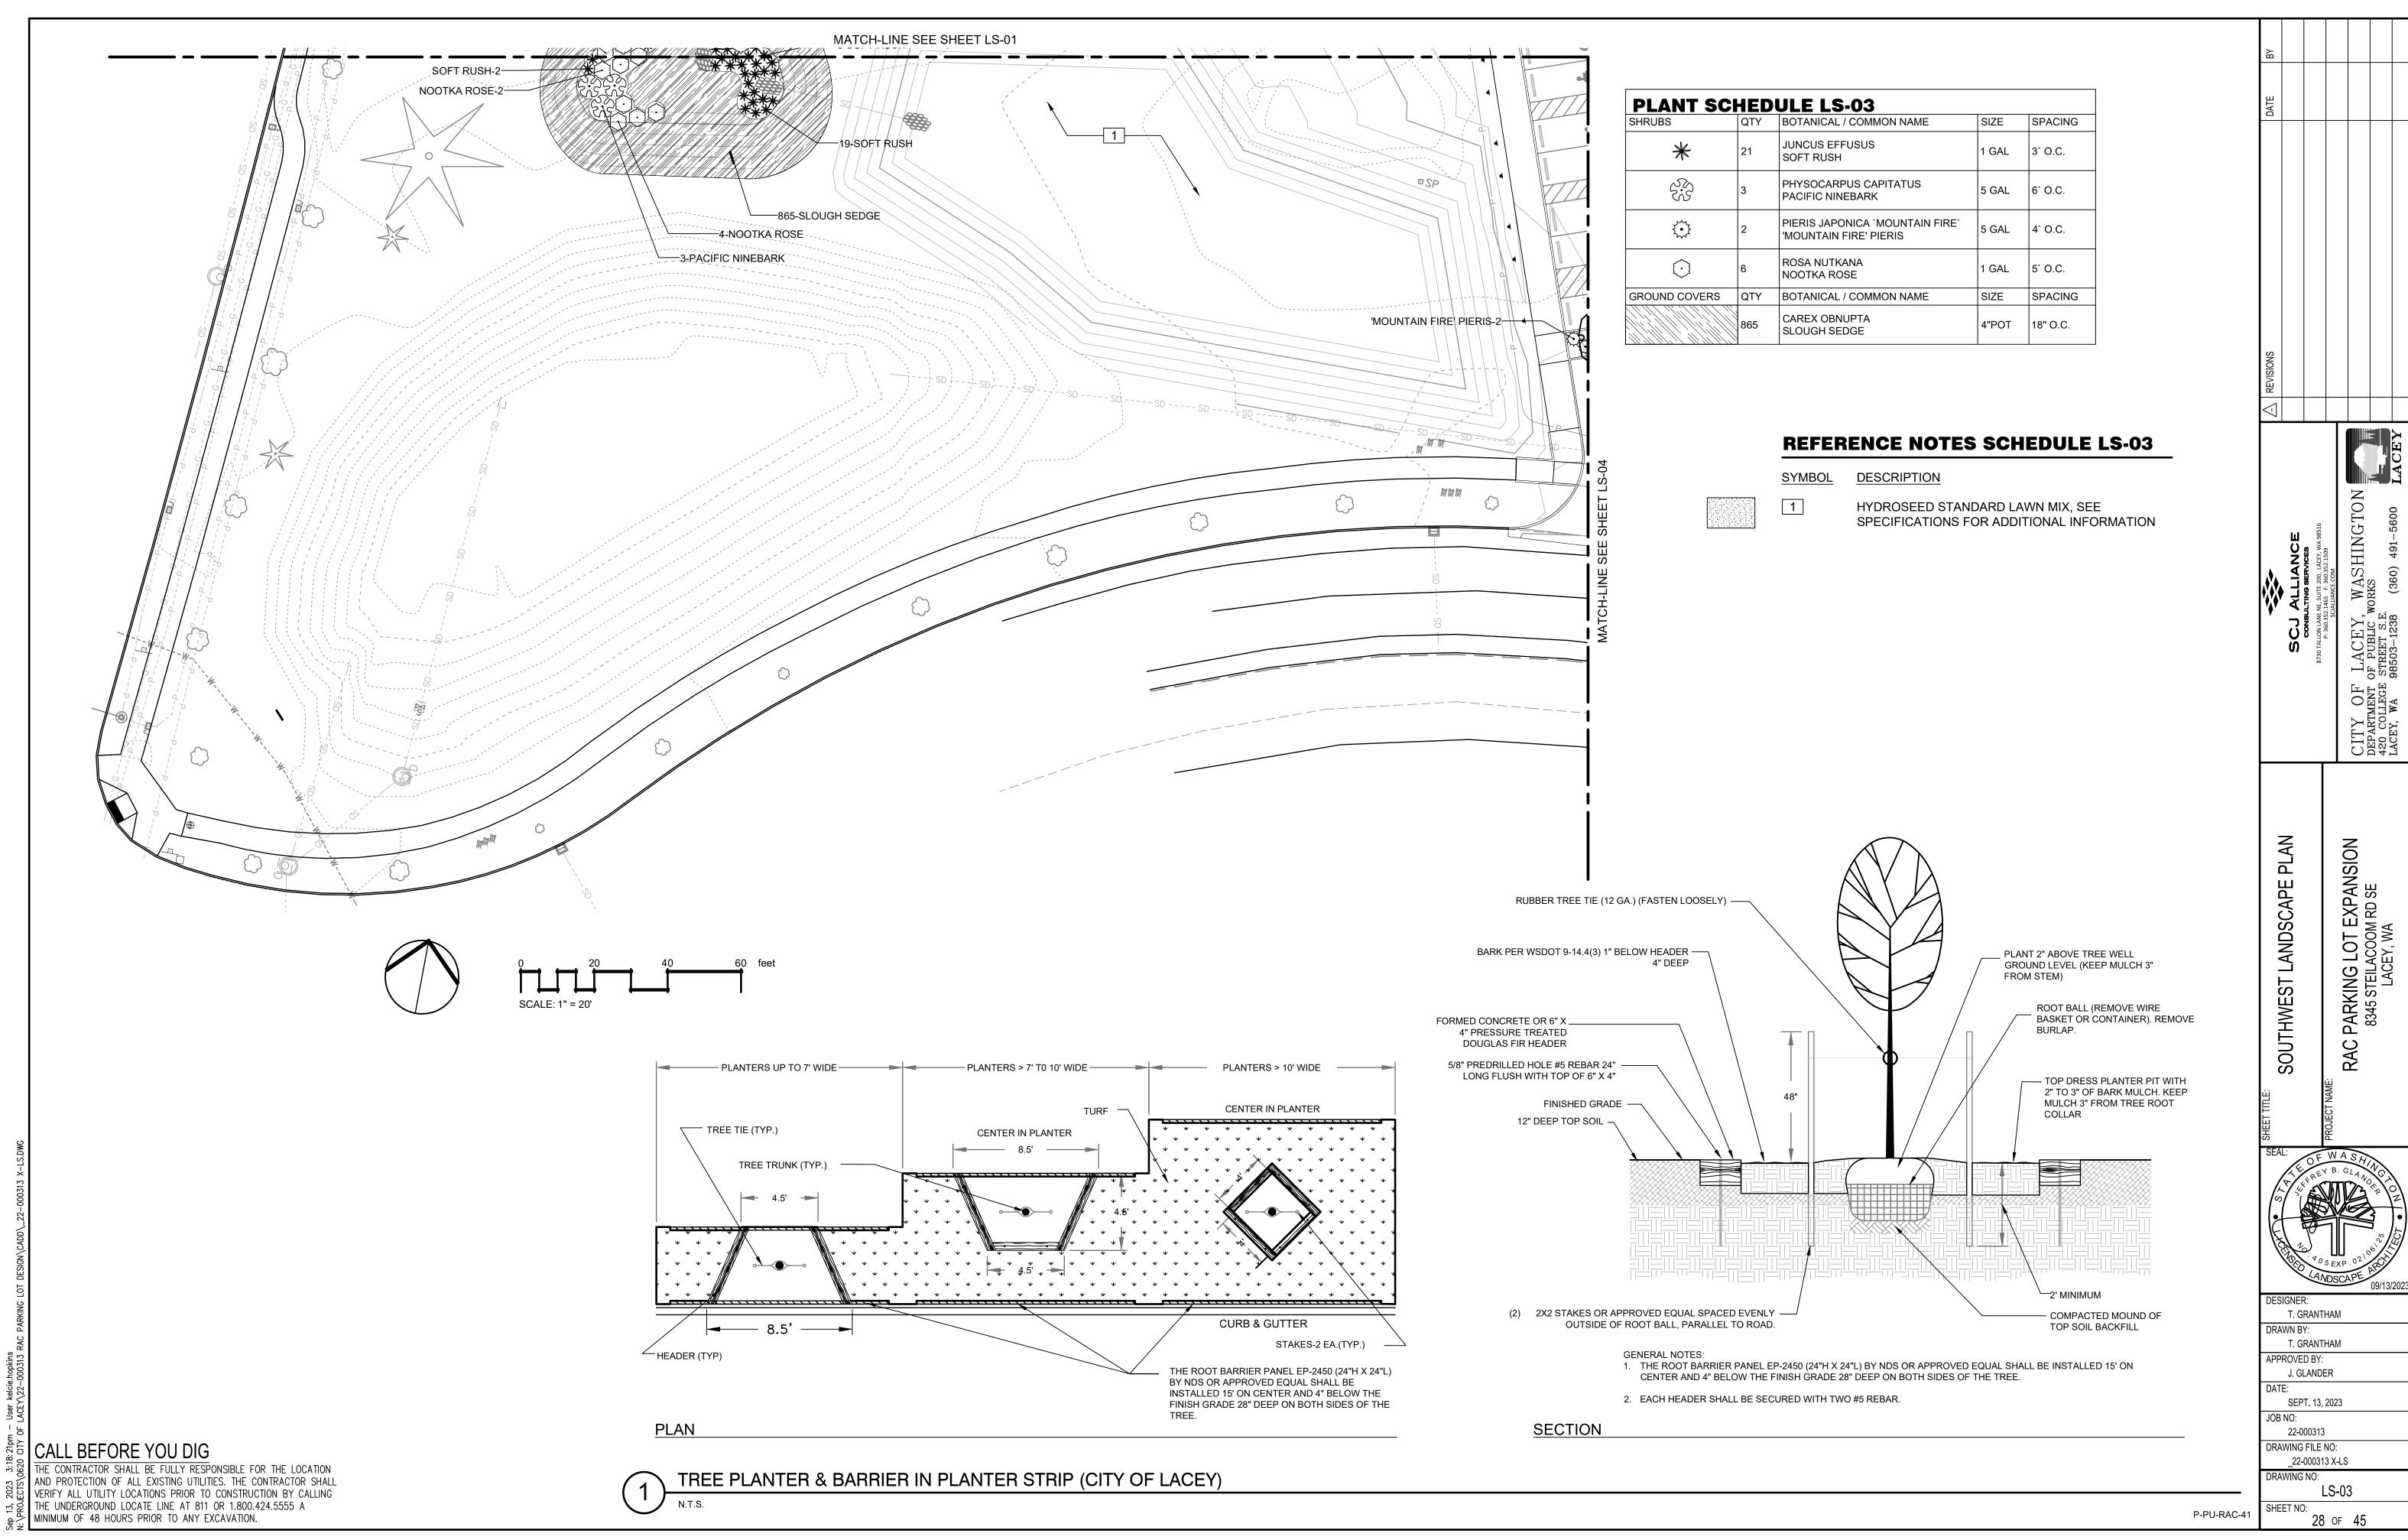

REFERENCE NOTES SCHEDULE LS-04

DESCRIPTION DETAIL HYDROSEED STANDARD LAWN MIX, SEE

SPECIFICATIONS FOR ADDITIONAL INFORMATION

COLORED & STAMPED CONCRETE UTILIZING MEDIUM GRAY COLOR WITH CHARGREEN RELEASE AGENT WITH SAND BLAST FINISH. TOOLED CONTROL JOINTS

> COLORED CONCRETE WITH BOMANITE -COBBLESTONE GRAY (OR APPROVED EQUAL). WITH 5 O.C. TOOLED SCORING - SEE CIVIL PLANS FOR

4 STANDARD CONCRETE

AS NOTED IN DETAIL.

CONCRETE DETAILS.

5/LS-05 PLAZA SEAT WALL, STANDARD CONCRETE COLOR


6" CONCRETE MOW STRIP 7/LS-05 **DETAIL DESCRIPTION** 5` X 5` KIVA TREE GRATE AS AVAILABLE FROM URBAN 6/LS-05

ACCESSORIES (PH: 877-487-0488) OR APPROVED **EQUAL**

BASEBALL STITCHING - BRICKS SET ON END, 8/LS-05 CENTERED ALONG EXPANSION JOINT.

TOOLED CONTROL JOINT, SEE DETAIL FOR

SHOWN

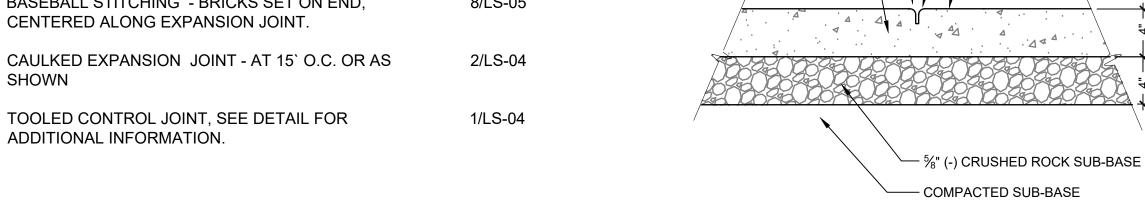


TOOLED CONTROL JOINT, SEE ———

4" THICK CONCRETE PAVING, — REINFORCE AS PER PLANS

MATERIAL PLAN FOR LOCATION

NOTE: CONTROL JOINTS AS SHOWN ON PLANS. IF NOT INDICATED ON PLANS LOCATE AT 5'-0" O.C. - VERIFY WITH LANDSCAPE ARCHITECT

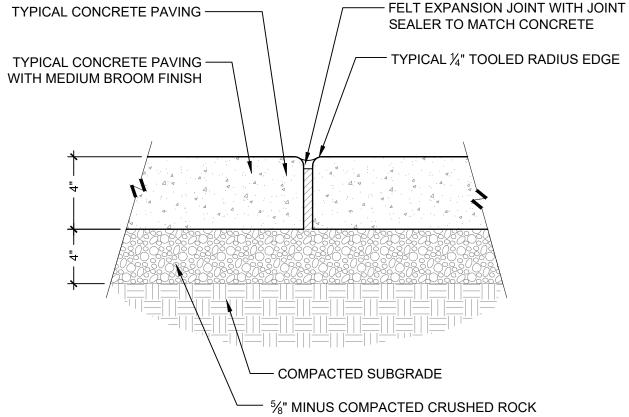

MATCH-LINE SEE SHEET LS-02

WINTER DAPHNE-14-

CEANOTHUS-2

'MT. VERNON' LAUREL-16-

'MT. VERNON' LAUREL-59-

`─2-WIN/TER DAPHINE

Y-9-'GEBTSH WHITE' HEMLOCK

∲'GOLDMØUND' \$PIREA

-1-\$LENDER/HINOK/CYPRESS

-3/WINTER DAPHN

-EX**/**STING RΦCK∕S T∕D REMAIN.

PROUND EXISTING ROCKS.

SURVEYED, ADJUST LANDSCAPE

ROCKS HAVE NOT BEEN

--/-6-'FIREH/OUSE' NAND∕INA

—7-С₿́ANOTHU(\$

REMAIN, TYP/.

−1-WEFÆIN)G ALASKA CEDAF

-14-'FIREHOUSE' NANDINA

─1-WEEPING ALASKALCEDAR

EXISTING STREET TREE TO

-16-'¢EBTSH WHIT∕E' H∕EMLOCK

SCALE: 1" = 20'

-1-FIREBURST PAPERBARK MAPLE

'FLOPPY DISC' CINQUIFOIL-9-

/MOUNTAIN FIRE' PIERIS,

KATSURA-1

─3-'MOUNTAIN FIRE' PIERIS

MT. VERNON' LAUREL-13-

-57-'MT. VERNON' L'AUREL

1,3-'MOUNTAIN FIRE' PIERIS

〔**○ 4** –

PAPERBARK MAPLE-

-2-KATSURA

14-'CRIMSON'PYGMY' BARBERRY

PAPERBARK MAPLE-2-

8-'MOUNTAIN FIRE' PIÈRIS

2-KATSURA

—1-'MOUNTAIN FIRE' PIERIS

EXISTING LAWN TO REMAIN

— 1" RADIUS BOTH SIDES, TYP.

P-PU-RAC-30

— MEDIUM BROOM FINISH

EXISTING SIDEWALK TO REMAIN -

-1-KATSURA

-5-WINTER DAPHNE

21-WINTER DAPHNE

P-PU-RAC-31

NOTE: GENERAL CONTRACTOR SHALL REMOVE EXCESS ASPHALT PAVEMENT AND SUB-BASE MATERIAL DOWN TO NATIVE SOIL.

WIDTH VARIES REFER TO PLAN

FINISH GRADE (INCLUDING -

2" @ SHRUB BEDS, -

CONCRETE CURB OR -

ADJACENT PAVEMENT

FLUSH @ LAWN AREA

ASPHALT PAVING -

BED MULCH)

CALL BEFORE YOU DIG

HE CONTRACTOR SHALL BE FULLY RESPONSIBLE FOR THE LOCATION AND PROTECTION OF ALL EXISTING UTILITIES. THE CONTRACTOR SHALL VERIFY ALL UTILITY LOCATIONS PRIOR TO CONSTRUCTION BY CALLING THE UNDERGROUND LOCATE LINE AT 811 OR 1.800.424.5555 A MINIMUM OF 48 HOURS PRIOR TO ANY EXCAVATION.



CAULKED CONSTRUCTION JOINT

PARKING ISLAND PLANTER DETAIL

SION LOT EXPAN ACOOM RD SE SEY, WA 出 LANDSCAPE PARKING I AND SITE RAC

WASHIN

OF MENT

CITY DEPART 420 CO

OF WASA DESIGNER:

3" MIN.; REFER TO PLAN FOR SPECIFIC BERM &

SUB-BASE

MATERIAL

NATIVE SOIL

CROWN HTS.

TOPSOIL FILL - REFER TO

SPECIFICATIONS FOR SOIL TYPE

T. GRANTHAM DRAWN BY: T. GRANTHM APPROVED BY: J. GLANDER

SEPT. 13, 2023 JOB NO: 22-000313 DRAWING FILE NO:

22-000313 X-LS DRAWING NO: LS-04

SHEET NO: P-PU-RAC-32 29 of 45

- CHEMICALLY KILL AND REMOVE FROM SITE ALL EXISTING WEEDS AND VEGETATION NOT SHOWN TO REMAIN ON PLANS.
- DISTRIBUTE IMPORTED SANDY LOAM TOPSOIL (APPROVED BY THE LANDSCAPE ARCHITECT) IN AREAS SHOWN AND AT DEPTHS INDICATED FOR CROWNING AND BERMING OF LANDSCAPE AREAS, AND BACKFILL OF RETAINING WALLS (IF REQUIRED). DOTTED LINES INDICATE 1' CONTOUR INTERVALS. ALL LANDSCAPE AREAS SHALL RECEIVE TOPSOIL. WHETHER INDICATED ON PLANS OR NOT. SO THAT FINISH GRADES OF ALL SHRUB BEDS SHALL BE 2" BELOW TOPS OF ADJACENT CURBS AND PAVEMENT, AND LAWN AREAS SHALL BE 1/2" BELOW TOPS OF ADJACENT CURBS AND PAVEMENT. STRUCTURAL FILL AREAS: ANY LANDSCAPE AREAS OCCURRING WITHIN STRUCTURAL FILL ZONES SHALL HAVE SAID STRUCTURAL FILL MATERIALS EXCAVATED TO A DEPTH OF 12" BELOW FINISH GRADES IN SHRUB AREAS AND 6" BELOW GRADE IN LAWN AREAS, AND REPLACED WITH SPECIFIED TOPSOIL. DISPOSE OF EXCAVATED MATERIAL OFF SITE.
- 4. FINE GRADE ALL LANDSCAPE BEDS PRIOR TO PLANTING OPERATIONS
- NO PLANT SUBSTITUTIONS SHALL BE PERMITTED WITHOUT PRIOR APPROVAL OF LANDSCAPE ARCHITECT/OWNER.
- ALL PLANTS SHALL CONFORM TO THE LATEST EDITION OF THE AMERICAN STANDARD FOR NURSERY STOCK.
- 7. ALL PLANT MATERIALS AND PLANT LOCATIONS SHALL BE APPROVED BY THE LANDSCAPE ARCHITECT PRIOR TO INSTALLATION.
- ROOT BARRIER SHALL BE INCORPORATED ADJACENT AND PARALLEL TO PAVING, CURB AND SIDEWALK, A MINIMUM OF 15 LINEAR FEET (7.5' ON EITHER SIDE OF TRUNK), 24" DEEP, WHERE ANY TREE IS WITHIN 8' OF PAVING, CURB OR SIDEWALK. ROOT BARRIER SHALL BE DEEPROOT UB-24 AS AVAILABLE FROM EWING IRRIGATION PRODUCTS, 2901 S TACOMA WAY, TACOMA, WA 98409 (253) 476-9530 OR APPROVED EQUAL
- SOIL AMENDMENT FOR SOIL PREPARATION AND PLANTING BACKFILL SHALL BE A SCREENED 5/8" MINUS NITRIFIED WOOD RESIDUAL COMPOST EQUAL TO:
 - "SILVER SPRINGS TOP GRADE COMPOST" BRAND COMPOST AS AVAILABLE FROM CORLISS RESOURCES LAKE TAPPS, WA (253) 279-9102.
 - "CEDAR GROVE COMPOST" BRAND COMPOST AS AVAILABLE FROM CEDAR GROVE COMPOST, MAPLE
 - PREP/LRI COMPOST AS AVAILABLE FROM RANDLES SAND AND GRAVEL, INC., PUYALLUP, WA (253)
- 10. SOIL PREPARATION (ALL LANDSCAPE AREAS). SPREAD 9 C.Y. OF SPECIFIED SOIL AMENDMENT PER 1000 S.F. (APPROX. 3" DEPTH) OF AREA. SPREAD 100 LBS./1000 S.F. OF DOLOMITE LIME (IN LAWN AREAS ONLY), 150 LBS./1000 S.F. OF AGRICULTURAL GYPSUM AND 15 LBS./1000 S.F. OF 16-8-8 COMMERCIAL FERTILIZER OVER SOIL AMENDMENT. ROTO-TILL ALL OF THE ABOVE TO A 6"-8" DEPTH AND GRADE SMOOTH, COMPACTING AS REQUIRED AND REMOVING ALL ROCKS, CLODS AND DEBRIS.
- 11. LAWN AREAS (SEED OR SOD REFER TO PLANS) SHALL CONSIST OF ONE OF THE FOLLOWING TURF TYPES:

60% TURF-TYPE PERENNIAL RYE GRASS VARIETIES VARIETIES

60% TURF-TYPE PERENNIAL RYE GRASS

20% BLUEGRASS 20% HARD FESCUE 40% TURF-TYPE FESCUE

- 12. SEED AND SOD SHALL BE EQUAL TO THAT AS GROWN BY COUNTRY GREEN TURF FARMS; OLYMPIA, WA OR JB INSTANT LAWN, REDMOND, WA. SEED SHALL BE APPLIED AT 7 LBS/1000 S.F. AND INCLUDE 10 LBS./1000 S.F. OF UNITED HORTICULTURE 15-5-10 FERTILIZER IN ALL LAWN AREAS.
- ALL TREES IN LAWN AREAS SHALL BE PLANTED IN A 3' DIAMETER CIRCLE OF BED MULCH, EXCEPT STREET TREES. ALL STREET TREES PLANTED IN LAWN AREAS SHALL BE PLANTED IN TRAPEZOID-SHAPED TREE WELL, WITH THE LONGER SIDE OF THE TREE WELL ALONG THE STREET. ALL TREE WELLS SHALL BE MULCHED WITH 3" DEPTH OF "FINE GRIND" HEM/FIR BARK MULCH AS TOP DRESSING.
- BACKFILL MIX FOR ALL PLANTS (EXCEPT RHODODENDRONS & AZALEAS) SHALL BE A BLEND OF 1/3 EXISTING SITE SOIL, 1/3 COARSE SAND, AND 1/3 SOIL AMENDMENT SPECIFIED IN NO. 9. BACKFILL MIX FOR RHODODENDRONS AND AZALEAS SHALL CONSIST OF 2/3 ABOVE SPECIFIED BACKFILL MIX AND 1/3 FINE
- APPLY OSMOCOTE 18-6-12, 9 MONTH SLOW RELEASE FERTILIZER OVER THE SURFACE OF ALL PLANT PITS AT THE FOLLOWING RATES:

TREES OVER 10' HEIGHT ALL SHRUBS EXCEPT 1 GALLONS: 1/2 CUP

GROUND COVERS:

2 CUPS 1/4 CUP

1 GALLON PLANTS:

TREES UNDER 10' HEIGHT: 1 CUP 1/4 CUP

- FERTILIZER TABLETS FOR ALL PLANTS SHALL BE AGRIFORM (20-10-5) 21 GRAM OR 10 GRAM TABLETS DISTRIBUTED AS FOLLOWS: ALL TREES: 4-21 GRAM TABLETS, ALL SHRUBS (EXCEPT 1 GALLONS): 3-21 GRAM TABLETS, ALL 1 GALLONS: 1-21 GRAM TABLET, ALL 2-1/4" AND 4" POT GROUND COVERS: 1-10 GRAM TABLET EACH. SET TABLETS DIRECTLY NEXT TO ROOTBALL.
- ALL SHRUB AND GROUND COVER BEDS SHALL RECEIVE A 2" DEPTH (6 C.Y. PER 1000 S.F.) OF "FINE GRIND" HEM/FIR BARK MULCH AS TOP DRESSING.
- APPLY A GRANULAR PRE-EMERGENT HERBICIDE TO ALL SHRUB AND GROUNDCOVER BEDS AT THE CONCLUSION OF THE MAINTENANCE PERIOD. DO NOT USE CASARON OR NORASAC BRANDS.
- 19. ALL WORK SHALL BE PERFORMED TO THE SATISFACTION OF THE LANDSCAPE ARCHITECT/OWNER.
- ALL PLANTS SHALL BE GUARANTEED FOR ONE FULL YEAR FROM DATE OF PROJECT ACCEPTANCE. ALL REPLACED PLANTS SHALL BE RE-GUARANTEED. ALL REPLACEMENTS SHALL BE MADE WITHIN 21 DAYS OF RECEIVING WRITTEN NOTICE FROM THE OWNER. CONTRACTOR SHALL NOT BE RESPONSIBLE FOR PLANTS DYING DUE TO OWNER NEGLECT OR VANDALISM, AFTER THE MAINTENANCE PERIOD.
- 21. PLANT LIST QUANTITIES ARE SHOWN FOR REFERENCE ONLY. CONTRACTOR IS RESPONSIBLE FOR VERIFYING ALL QUANTITIES IN LIST WITH ACTUAL PLAN CALL-OUTS, AND INSTALLING PLANTINGS PER THE LANDSCAPE PLAN. GROUNDCOVER AND/OR MASS SHRUB QUANTITIES SHALL BE ADJUSTED AS REQUIRED FOR FIELD CONDITIONS AT THE SPECIFIED SPACING.
- FINAL INSPECTION SHALL OCCUR AT THE CONCLUSION OF A 60-DAY MAINTENANCE & PLANT ESTABLISHMENT PERIOD. MAINTENANCE PERIOD SHALL COMMENCE UPON COMPLETION OF ALL LANDSCAPE INSTALLATION ACTIVITIES AND SHALL INCLUDE THE FOLLOWING:
 - MOW LAWNS ONCE PER WEEK.
 - REMOVE ALL WEEDS OVER 1" IN HEIGHT
 - REPLACE DEAD OR UNHEALTHY PLANTS. ENSURE PROPER FUNCTION OF IRRIGATION SYSTEM.
 - ENSURE ADEQUATE MOISTURE IS DELIVERED TO ALL LANDSCAPE BEDS INCLUDING NON-IRRIGATED

 - FERTILIZE ALL LAWNS AT CONCLUSION OF MAINTENANCE AND PLANT ESTABLISHMENT PERIOD.

SHRUB FLARE SHALL BE **CLEARLY VISIBLE** AFTER PLANTING -WATERING BASIN BERM PLANTING PIT ROOTBALL SHALL BE A FERTILIZER TABLETS, DEPTH MIN. OF TWICE 2"-6" DEPTH THE ROOTBALL 6" MIN. DEPTH - REMOVE BURLAP FROM DIAMETER ─ BACKFILL SOIL MIX PLÁNTING PIT SHALL BE A MINIMUM OF TWICE

THE ROOT- BALL WIDTH

PLASTIC LOCK-TIE OR RUBBER HOSE TREE TIE. SET LOOSE TO ALLOW FOR DIAMETER GROWTH. 2" DIAMETER STAKES -(8' LONG) 2" OF MULCH KEEP AWAY -FROM TREE TRUNK. 3-4" SOIL SAUCER (DURING ESTABLISHMENT) **CROWN AT FINISH** FINISH GRADE -GRADE BACKFILL MIX -· FERTILIZER **TABLETS** REMOVE CONTAINER AND/ OR ALL BURLAP FROM ROOTBALL. REMOVE ALL

EVERGREEN TREE PLANTING DETAIL

WIRE & STRING

UNDISTURBED SUBGRADE -

ROOTBALL WILL NOT SINK)

(PROVIDES FIRM BASE SO THAT

← SHRUB SIDE LAWN SIDE ----- FINISH GRADE 1/2" TOOLED EDGE -- C.I.P. CONCRETE, 5 SACK MIX AT 2500 PSI #3 REBAR CONTINUOUS, LAP 24" AT JOINTS - COMPACTED SUBGRADE

6" CONCRETE MOW STRIP

1" CHAINLOCK TREE TIES - (2)-BVC WOOD TREE STAKES (8' - 4" MULCH IN BASIN 3" WATER RETENTION BASIN (IN SHRUB AND GROUNDCOVER AREAS - FERTILIZER TABLETS - COMPLETELY REMOVE BURLAP FROM **ROOT BALL** - BACKFILL SOIL MIX 1. REMOVE TREATED OR SYNTHETIC | WIDTH | BURLAP COMPLETELY. 2. INSTALL 24" DEPTH ROOT BARRIER AT PLANTING P THE EDGE OF ANY PAVING WITHIN 8 FT. SHALL BE A MIN OF TREE TRUNK. OF 3X THE 3. ENSURE THE TRUNK FLARE IS VISIBLE ROOTBALL WIDTH ABOVE GRADE AFTER PLANTING.

- SAWCUT CONTROL JOINTS ON

THREE SIDES AT ALL CORNERS &

- #4 REBAR HORIZONTAL (EQUALLY

SPACED) & VERTICAL @ 12" O.C WITH

· (3) HORIZONTAL #4 REBAR

EQUALLY SPACED

#4 HORIZONTAL REBAR 12" O.C.

EVERY 2' O.C. STARTING FROM

CENTER OUT

3" CLEAR

INDIVIDUAL PLANTS REPRESENTED AS: +

PLANTING BED

SPECIFIED PLANT SPACING = "X"

TRIANGULAR SPACING WITHIN

BACKFILL MIX PER TREE -

DETAIL

P-PU-RAC-10

- AREA FOR SPACING ADJUSTMENT

 CONTINUOUS OUTER ROW OF PLANTS SPACED "X" ON CENTER

AND SET BACK FROM THE

PLANTING BED EDGE 2/3 "X"

— EDGE OF PLANTING BED

TREE GRATE, REFER TO -**DRAWINGS AND** TREE GRATE FRAME PER SPECIFICATIONS FOR TYPE & MANUFACTURER SIZE, TYP. — #3 REBAR APPROX 18" O.C. - NEW CONCRETE WALK- SEE CIVIL PLANS, TYP.

SEE CIVIL PLANS FOR CONCRETE BASE, TYP.

NOTES: 1. CIP STANDARD CONCRETE SEAT WALL WITH LIGHT SANDBLAST FINISH, SMOOTH SACK ALL WALLS PRIOR TO SANDBLASTING. ALL CONCRETE SHALL BE CLASS 3000.

2. CONTRACTOR SHALL PROVIDE SHOP DRAWINGS ILLUSTRATING REBAR LOCATIONS FOR ALL

10⁷/₈"

3'-0"

EQUAL

CROSS SECTIONS.

P-PU-RAC-19

2" RADIUS, TYP. -

PLAZA PAVING-SEE -

%" (-) MINUS CRUSHED -

LAYOUT PLAN

P-PU-RAC-24

STANDARD CONCRETE PAVING SEE -PLAN FOR ADDITIONAL **INFORMATION** COLORED CONCRETE, SEE PLAN FOR ADDITIONAL **INFORMATION** - BRICK SET ON END ALIGN MIDDLE OF BRICKS WITH EDGE OF CONCRETE 3/4" EXPANSION JOINT WITH RED EPOXY, VERIFY COLOR WITH LANDSCAPE ARCHITECT CLAY BRICK SET ON EDGE - STANDARD CONCRETE COLORED CONCRETE -COMPACTED GRAVEL SUBGRADE CONCRETE TO SUPPORT BRICK DURING CONCRETE SECTION 'A'

 $^{-1}$ /2" HOLE FOR #3 REBAR

NOTE: BOLLARD SHALL BE 6"X36" REMOVABLE BOLLARD AS AVAILABLE FROM CREATIVE SAFETY SUPPLY OR APPROVED EQUAL, IN STANDARD COLOR YELLOW OR AS APPROVED BY OWNER'S REPRESENTATIVE.

REMOVABLE MOUNTED BOLLARD

 $\overline{\mathbb{S}}$ Ö PARKING 8345 STEILA OUTHEA P-PU-RAC-23 RAC OF WASA

WASHIN() RKS

PLANTING HOLE 2X

ROOT BALL WIDTH

P-PU-RAC-25

INLAID CLAY PAVER (BASEBALL STITCHING)

P-PU-RAC-27

POUR

RECIEVING SLEEVE, PER MFR. **SPECIFICATIONS** DESIGNER: T. GRANTHAM DRAWN BY: T. GRANTHAM APPROVED BY: J. GLANDER 1%"WASHED DRAIN ROCK SEPT. 13, 2023

-6"DIA. X 36"HT. STEEL BOLLARD

LOCK TAB WITH ½" SLOTTED HOLE

LOCK WELL

Job No: 22-000313 DRAWING FILE NO: 22-000313 X-LS DRAWING NO: LS-05

P-PU-RAC-37

SHEET NO:

30 of 45


CALL BEFORE YOU DIG


AND PROTECTION OF ALL EXISTING UTILITIES. THE CONTRACTOR SHALL

HE CONTRACTOR SHALL BE FULLY RESPONSIBLE FOR THE LOCATION

MINIMUM OF 48 HOURS PRIOR TO ANY EXCAVATION.


VERIFY ALL UTILITY LOCATIONS PRIOR TO CONSTRUCTION BY CALLING THE UNDERGROUND LOCATE LINE AT 811 OR 1.800.424.5555 A

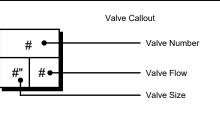

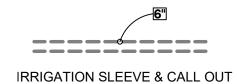


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VALVE SCHEDULE - ALL SHEETS									
NUMBER	MODEL	SIZE	TYPE	GPM	PSI	PSI @ POC			
1-1	WEATHERMATIC MAX-DW	1-1/2"	TURF ROTOR	27.1	41.7	42.6			
1-2	WEATHERMATIC MAX-DW	1-1/2"	TURF ROTOR	29.7	39.3	42.1			
1-3	WEATHERMATIC MAX-DW-XPR DFXX-140	1-1/2"	AREA FOR DRIPLINE	24.26	34.7	37.7			
1-4	WEATHERMATIC MAX-DW	1-1/2"	TURF ROTARY	29.18	48.2	52.4			
2-1	WEATHERMATIC MAX-DW	1"	TURF ROTARY	17.61	44.3	44.6			
2-2	WEATHERMATIC MAX-DW-XPR DFXX-140	1-1/2"	AREA FOR DRIPLINE	25.31	37.2	37.8			
2-3	WEATHERMATIC MAX-DW	1-1/2"	TURF ROTARY	31.76	47.7	52.3			
2-4	WEATHERMATIC MAX-DW	1"	TURF ROTARY	21.61	51.9	55.1			
2-5	WEATHERMATIC MAX-DW-XPR DFXX-140	1-1/2"	AREA FOR DRIPLINE	30.23	37.4	43.4			



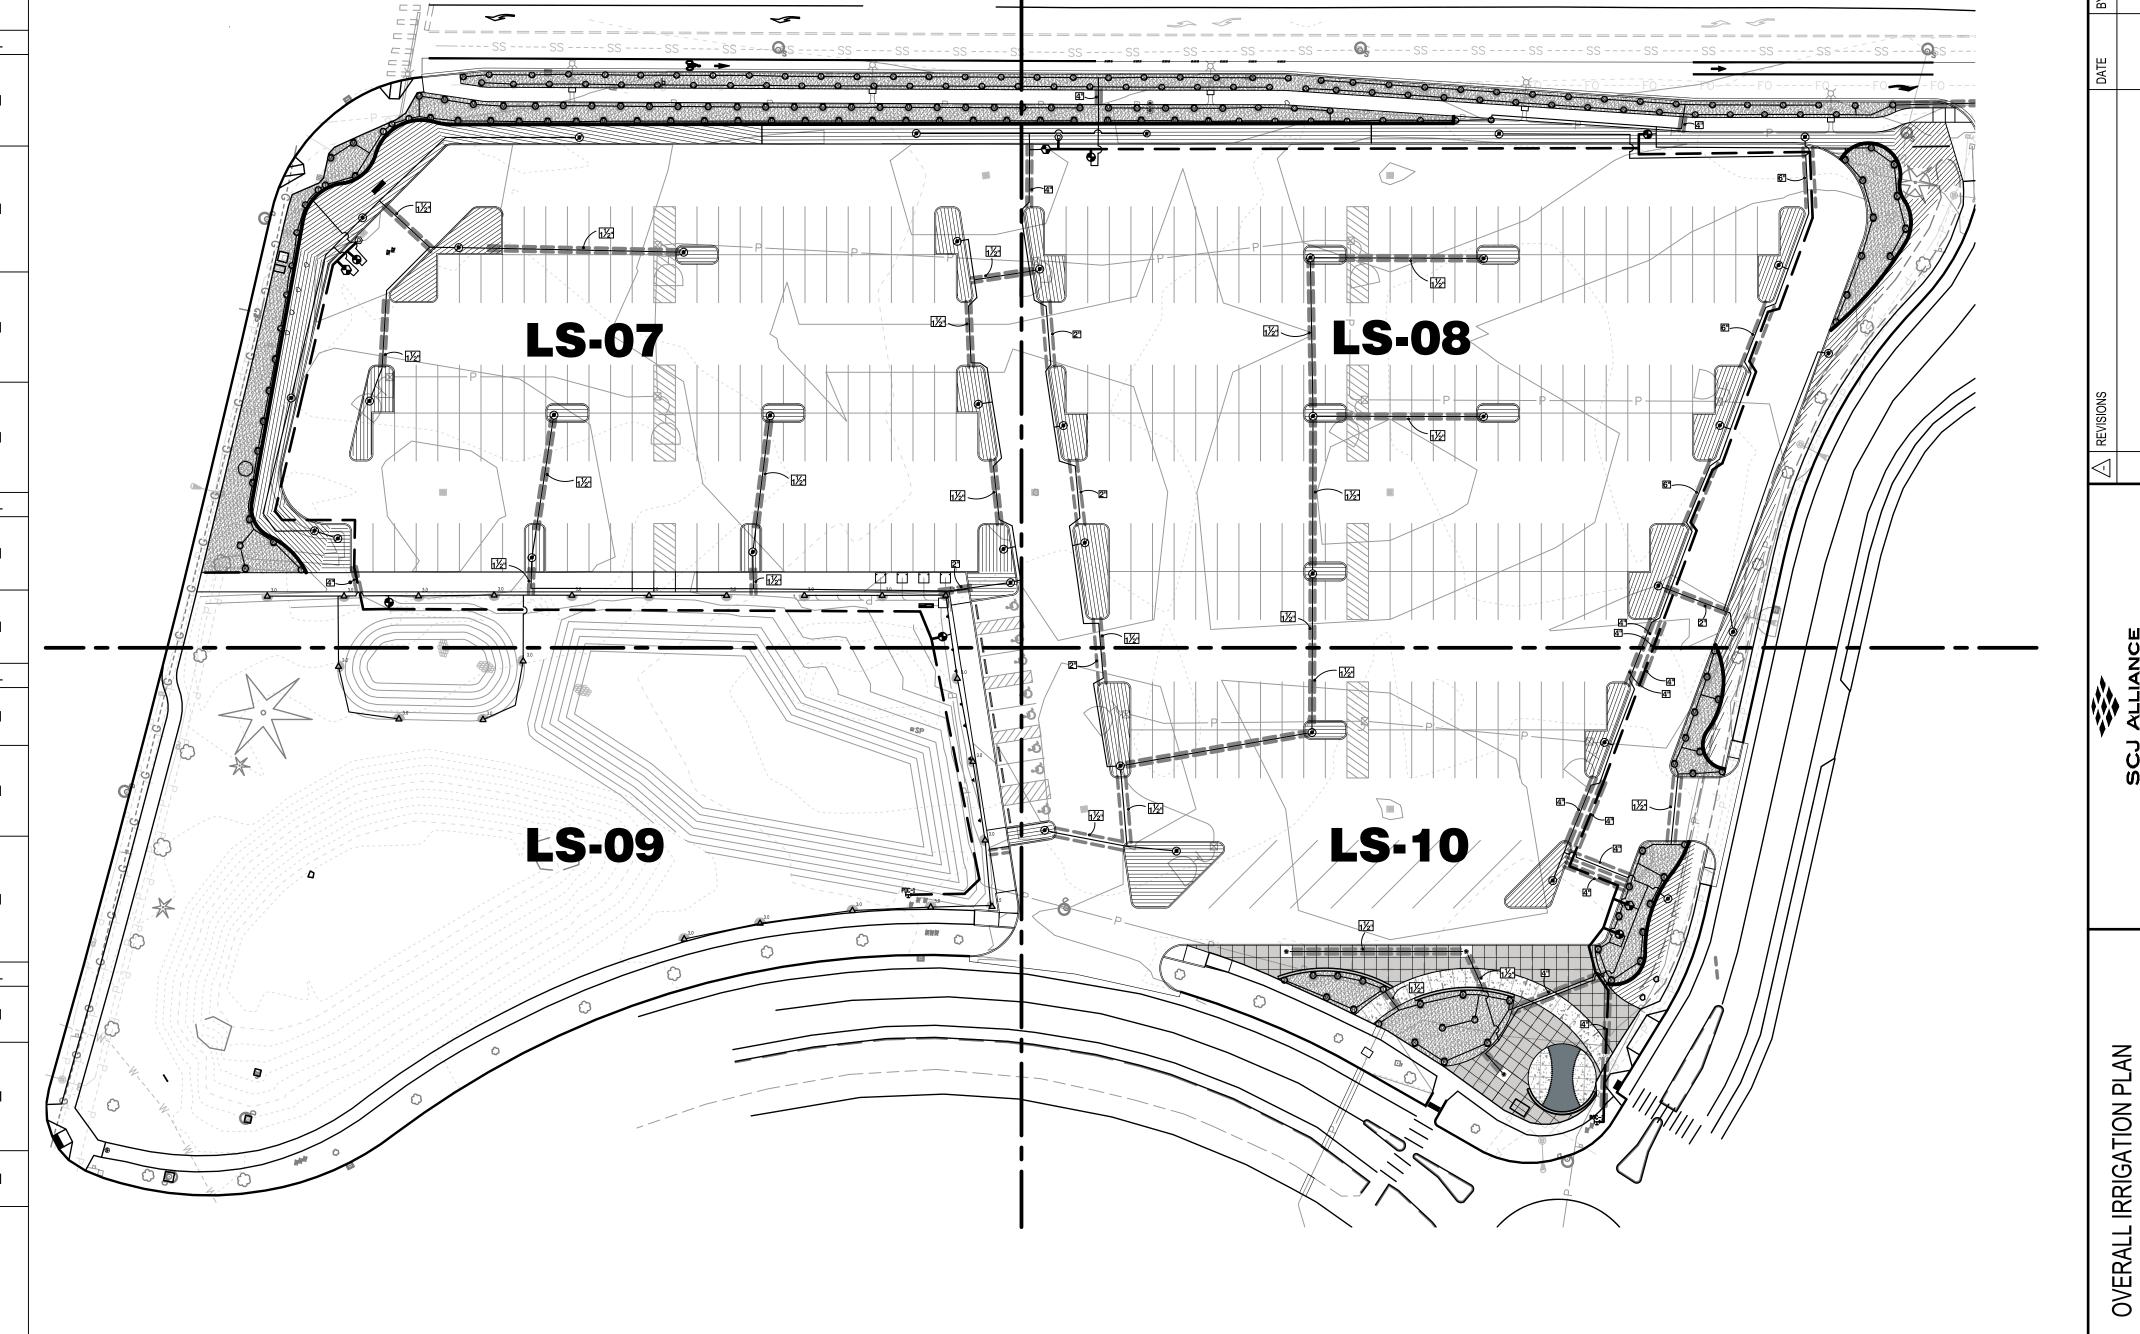



SION

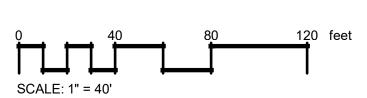LOT ACOON EY, WA

RAC


V DOCK!	09/13/
DESIGNER:	
J. MCFARLAND	
DRAWN BY:	
J. MCFARLAND	
APPROVED BY:	
J. GLANDER	
DATE:	
SEPT. 13, 2023	
JOB NO:	


DRAWING NO:

LS-06

SHEET NO:

31 OF 45

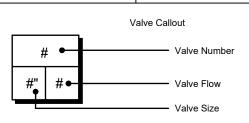

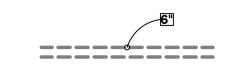

IRRIGATION SLEEVE & CALL OUT

VALVE SCHEDULE LS-07 NUMBER MODEL SIZE TYPE GPM PSI PSI @ POC 1.4 VIEATUERMATIC MAX DW 1.4/2" TURE ROTOR 27.4 44.7 42.6						
NUMBER	MODEL	SIZE	TYPE	GPM	PSI	PSI @ POC
1-1	WEATHERMATIC MAX-DW	1-1/2"	TURF ROTOR	27.1	41.7	42.6
1-2	WEATHERMATIC MAX-DW	1-1/2"	TURF ROTOR	29.7	39.3	42.1
1-3	WEATHERMATIC MAX-DW-XPR DFXX-140	1-1/2"	AREA FOR DRIPLINE	24.26	34.7	37.7
1-4	WEATHERMATIC MAX-DW	1-1/2"	TURF ROTARY	29.18	48.2	52.4

IRRIGATION SHEET NOTES

2" BELOW TOP OF TOPSOIL.

PAVED AREAS.

I-102

I-101

- 1. SEE DETAILS AND SPECIFICATIONS FOR ADDITIONAL INFORMATION.
- 2. PLAN IS DIAGRAMMATIC. ALL PIPING, LATERALS, AND WIRE TO BE LOCATED IN BED OR LAWN AREAS WHERE APPROPRIATE.
- 3. PIPE SIZES ARE TO REMAIN CONSTANT BETWEEN PIPE SIZE CALL-OUTS. PIPES ARE LABELED TO SMALLEST PIPE SIZE ONLY (3/4").

HEADS IN SHRUB AREAS SHALL BE 12" POP-UPS.

5. ALL DRIP TUBING SHALL BE INSTALLED BELOW THE FINISH SOIL GRADE UNLESS NOTED OTHERWISE. INSTALL TUBING AT A CONSISTENT DEPTH OF

4. ALL IRRIGATION HEADS LOCATED IN LAWN AREAS SHALL BE 4" POP-UPS AND

- 6. ALL PIPES AND SLEEVES UNDER PAVED AREAS SHALL BE 24" DEEP. ALL MAINLINE SHALL BE 18" DEEP IN ALL UNPAVED AREAS, 24" IN PAVED ARES. ALL LATERALS SHALL BE 12" DEEP IN ALL UNPAVED AREAS AND 24" DEEP IN
- LOCATE ALL MAINLINES WITHIN THE PROJECT LIMITS. INSTALL #14-AWG DIRECT BURIAL LOW VOLTAGE WIRE ALONG MAINLINE; TAPE AND BUNDLE WIRE EVER 20' FT. PROVIDE RED COLOR WIRE FOR SIGNAL AND WHITE COLOR WIRE FOR COMMON. PROVIDE A MINIMUM OF ONE SPARE WIRE FOR EVERY 10 VALVES FOR A MAXIMUM OF FIVE SPARE WIRES.
- ALL WORK SHALL BE PERFORMED TO THE SATISFACTION OF THE LANDSCAPE ARCHITECT/OWNER.

IRRIGATION SCHEDULE LS-07

SYMBOL DESCRIPTION

11/2" -

1-2


PRESERVE AND PROTECT EXISTING TREES AND/OR LANDSCAPE PLANTINGS TO REMAIN, THIS AREA. PRESERVE AND PROTECT EXISTING IRRIGATION LINES AND HEADS TO REMAIN ALONG EXISTING PAVING/WALKS. FIELD VERIFY EXTENTS OF EXISTING LANDSCAPE TO REMAIN AND ADJUST IRRIGATION EQUIPMENT AS NEEDED.

MATCH-LINE SEE SHEET LS-09

PRESERVE AND PROTECT EXISTING IRRIGATION VALVES AND EQUIPMENT, THIS AREA. ENSURE THAT THE OPERATION AND FUNCTION OF EXISTING IRRIGATION ZONES IN THIS AREA ARE PRESERVED.

IRRIGATION PLAN IS DIAGRAMMATIC, TYP. ALL LINES, HEADS, VALVES AND OTHER IRRIGATION EQUIPEMENT SHALL BE INSTALLED IN LANDSCAPE AREAS WHERE POSSIBLE AND WITHIN PROJECT LIMITS UNLESS OTHERWISE NOTED.

TWO EXISTING CONTROL VALVES HERE, AND RELATED EQUIPMENT, TO BE REMOVED AND A USABLE LENGTH OF THE CONTROL WIRES RETAINED (MIN. 6'), NEAR POINT OF CONNECTION '1'. CONFIRM LOCATION OF VALVES WITH OWNER'S REPRESENTATIVE.

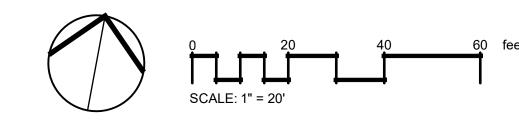

11/2" ~

LOT EXPAN ACOOM RD SE SEY, WA LANDSCAP PARKING I 8345 STEILA LACE NORTHWEST


DESIGNER: J. MCFARLAND DRAWN BY: J. MCFARLAND APPROVED BY: J. GLANDER SEPT. 13, 2023

JOB NO: 22-000313 DRAWING FILE NO: 22-000313 X-LS

DRAWING NO: LS-07 SHEET NO: 32 of 45

CALL BEFORE YOU DIG

HE CONTRACTOR SHALL BE FULLY RESPONSIBLE FOR THE LOCATION AND PROTECTION OF ALL EXISTING UTILITIES. THE CONTRACTOR SHALL VERIFY ALL UTILITY LOCATIONS PRIOR TO CONSTRUCTION BY CALLING THE UNDERGROUND LOCATE LINE AT 811 OR 1.800.424.5555 A MINIMUM OF 48 HOURS PRIOR TO ANY EXCAVATION.

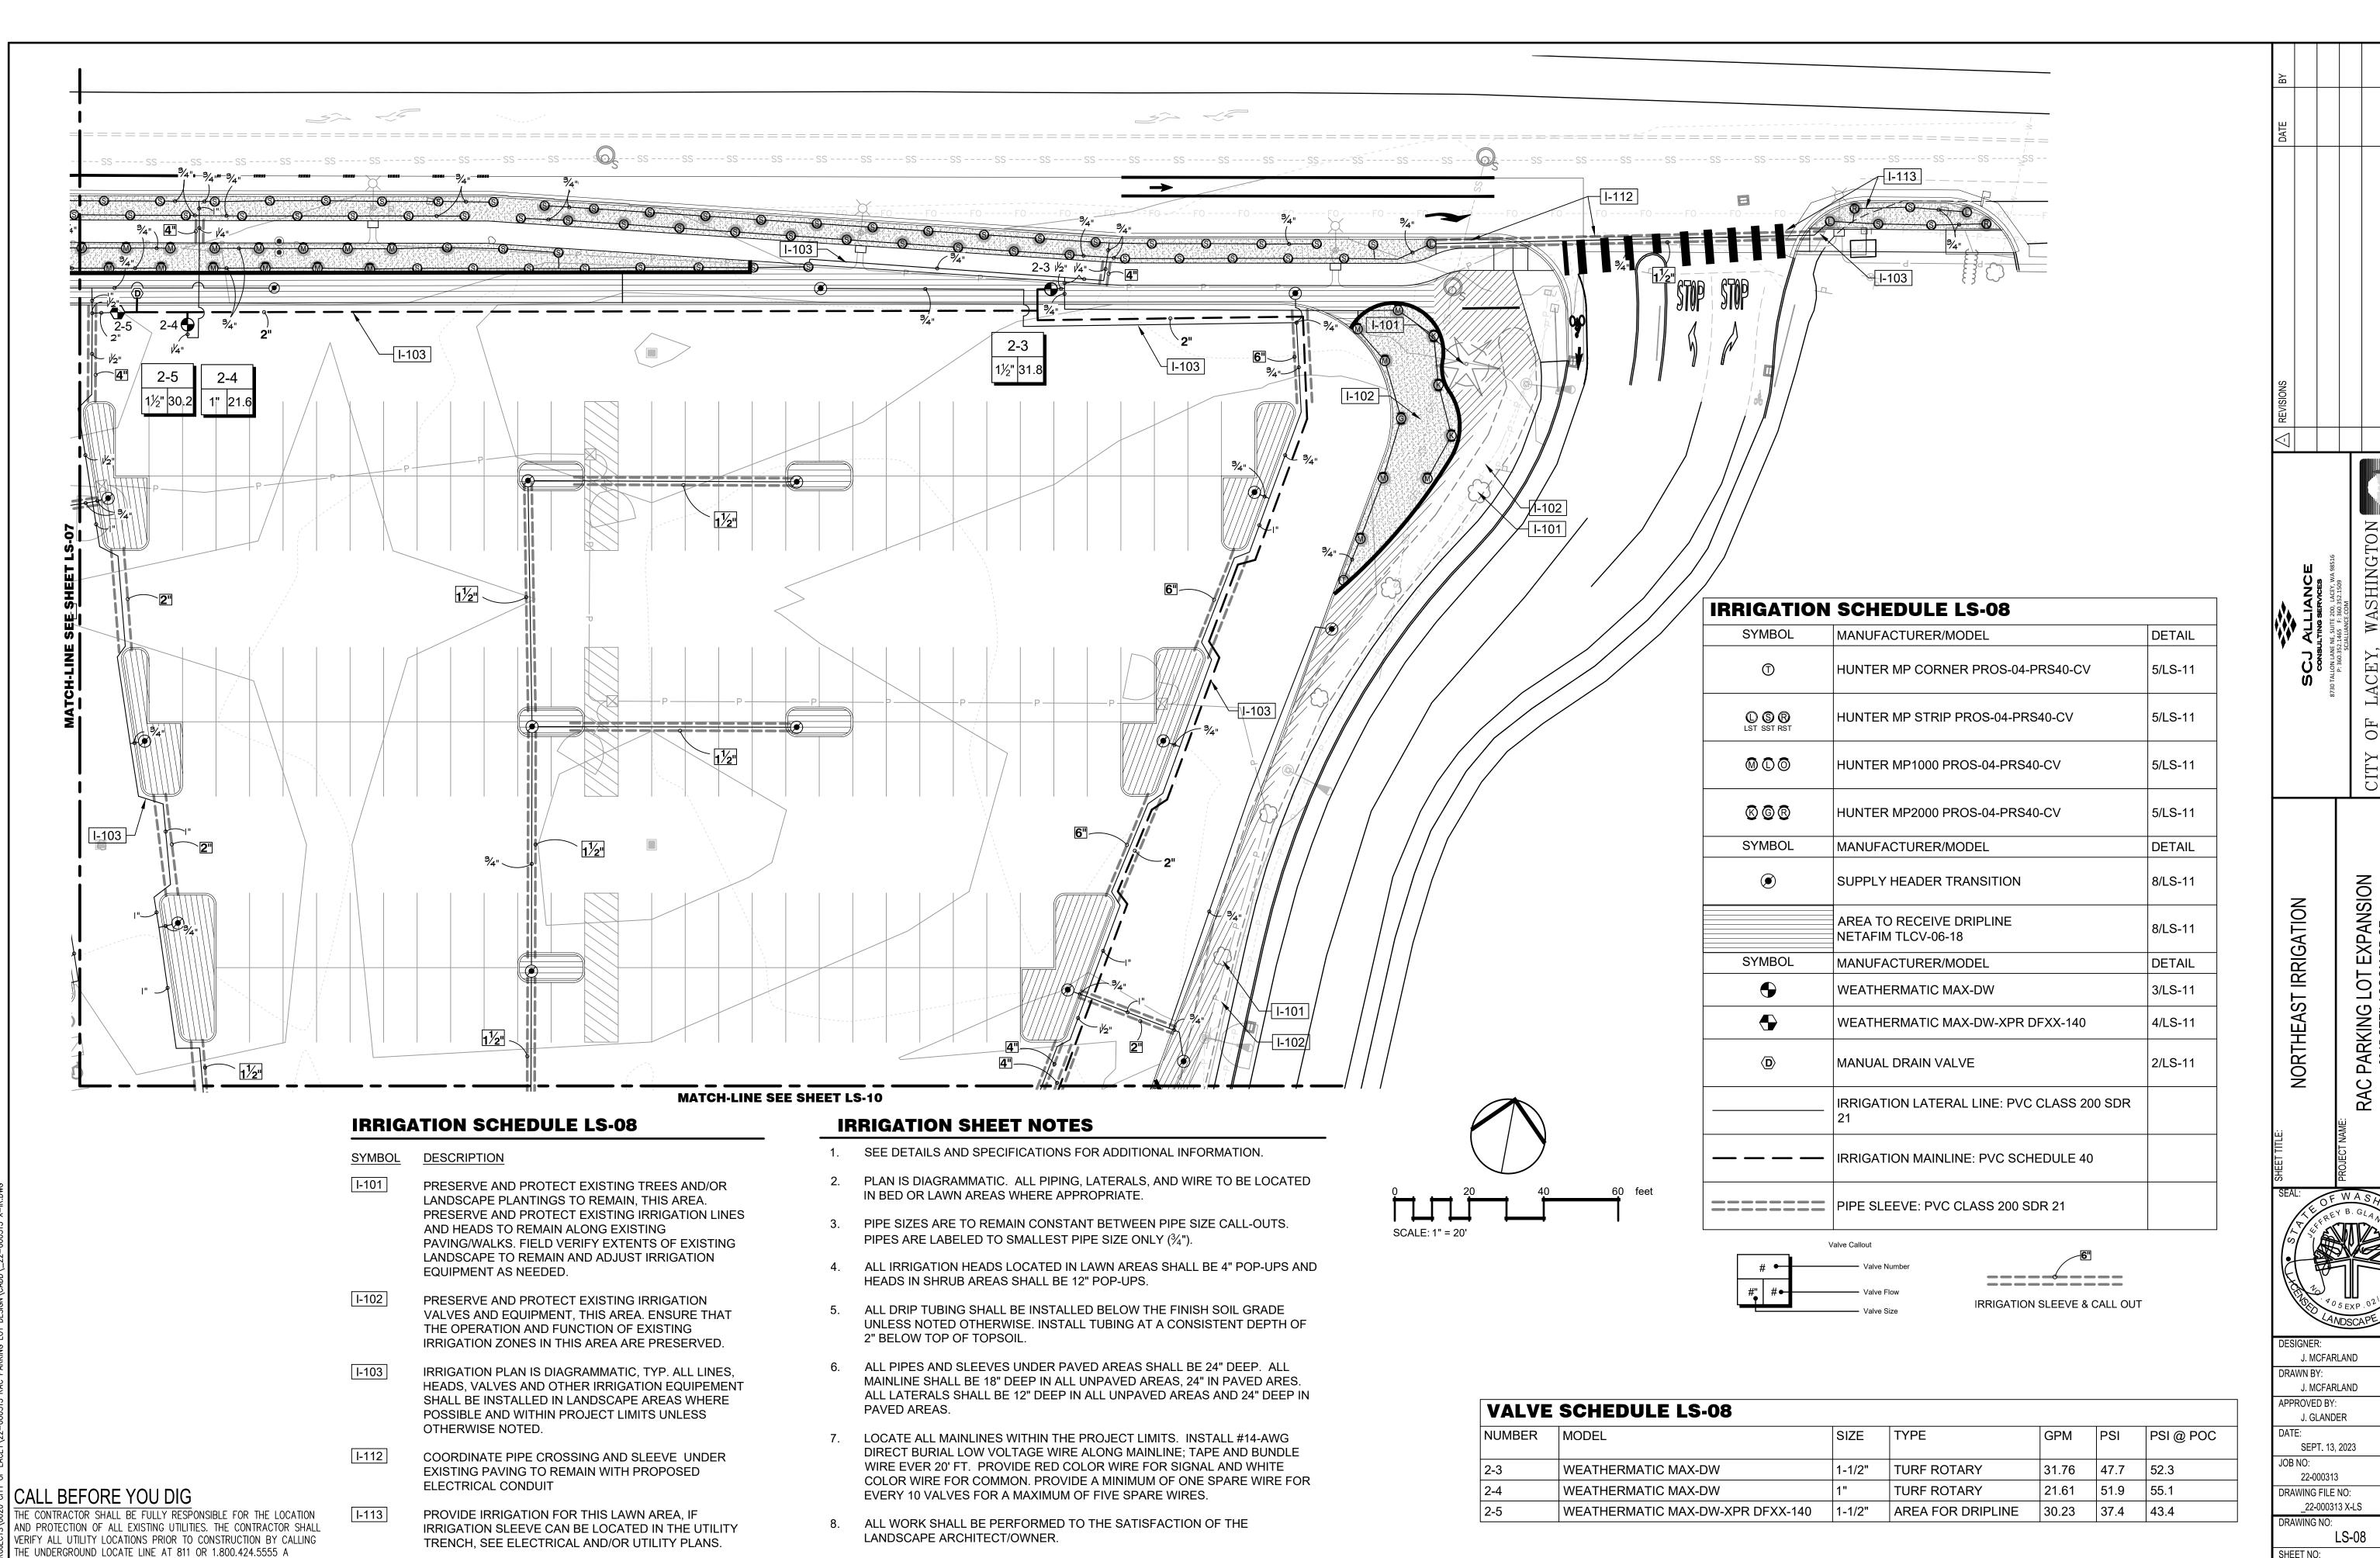


S PARKING LOT EXPANS 8345 STEILACOOM RD SE LACEY, WA

RAC


SHEET NO:

33 OF 45

MINIMUM OF 48 HOURS PRIOR TO ANY EXCAVATION.

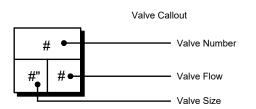



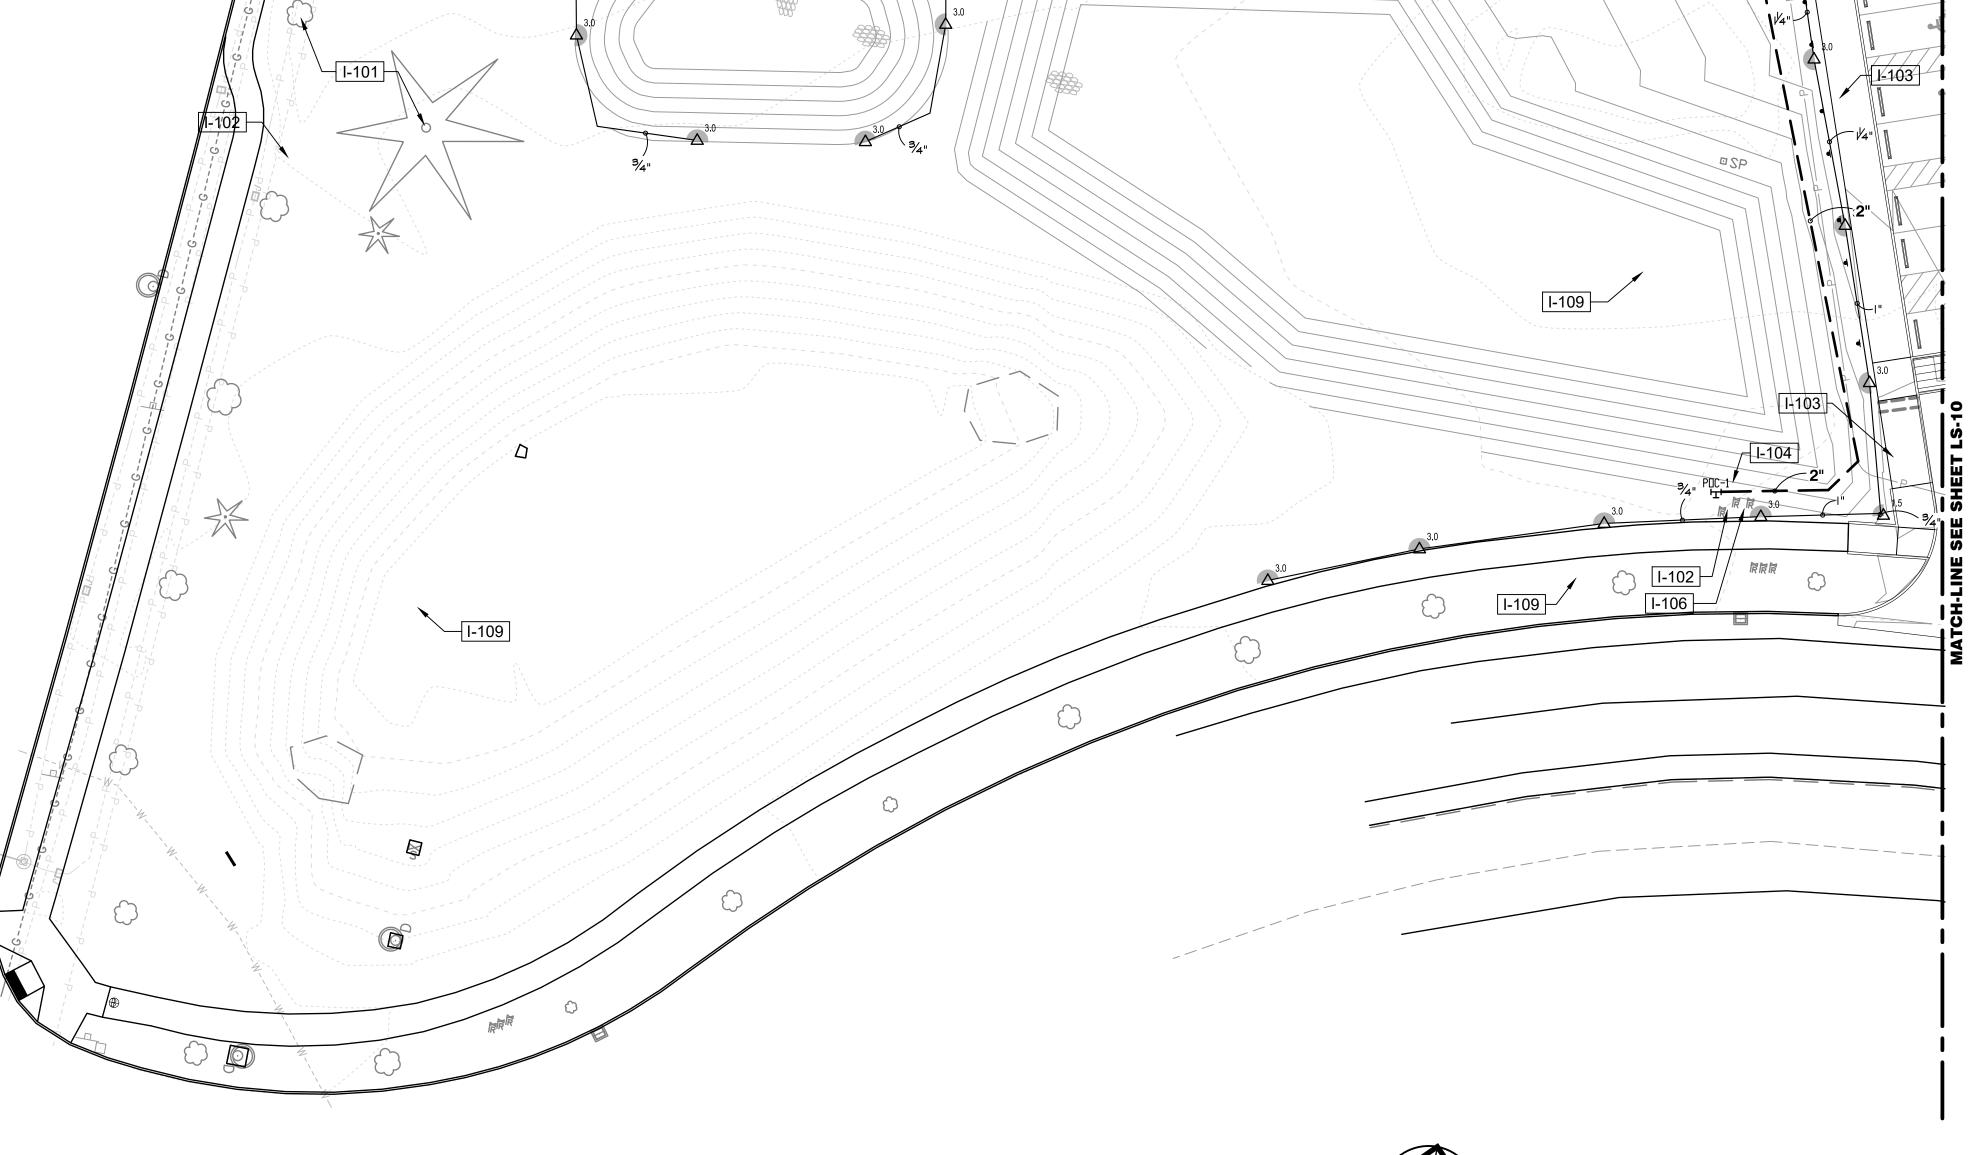

MATCH-LINE SEE SHEET LS-07

IRRIGATION SHEET NOTES

- 1. SEE DETAILS AND SPECIFICATIONS FOR ADDITIONAL INFORMATION.
- 2. PLAN IS DIAGRAMMATIC. ALL PIPING, LATERALS, AND WIRE TO BE LOCATED IN BED OR LAWN AREAS WHERE APPROPRIATE.
- 3. PIPE SIZES ARE TO REMAIN CONSTANT BETWEEN PIPE SIZE CALL-OUTS. PIPES ARE LABELED TO SMALLEST PIPE SIZE ONLY $(\frac{3}{4}")$.
- 4. ALL IRRIGATION HEADS LOCATED IN LAWN AREAS SHALL BE 4" POP-UPS AND HEADS IN SHRUB AREAS SHALL BE 12" POP-UPS.
- 5. ALL DRIP TUBING SHALL BE INSTALLED BELOW THE FINISH SOIL GRADE UNLESS NOTED OTHERWISE. INSTALL TUBING AT A CONSISTENT DEPTH OF 2" BELOW TOP OF TOPSOIL.
- 6. ALL PIPES AND SLEEVES UNDER PAVED AREAS SHALL BE 24" DEEP. ALL MAINLINE SHALL BE 18" DEEP IN ALL UNPAVED AREAS, 24" IN PAVED ARES. ALL LATERALS SHALL BE 12" DEEP IN ALL UNPAVED AREAS AND 24" DEEP IN PAVED AREAS.
- 7. LOCATE ALL MAINLINES WITHIN THE PROJECT LIMITS. INSTALL #14-AWG DIRECT BURIAL LOW VOLTAGE WIRE ALONG MAINLINE; TAPE AND BUNDLE WIRE EVER 20' FT. PROVIDE RED COLOR WIRE FOR SIGNAL AND WHITE COLOR WIRE FOR COMMON. PROVIDE A MINIMUM OF ONE SPARE WIRE FOR EVERY 10 VALVES FOR A MAXIMUM OF FIVE SPARE WIRES.
- 8. ALL WORK SHALL BE PERFORMED TO THE SATISFACTION OF THE LANDSCAPE ARCHITECT/OWNER.

IRRIGATION SCHEDULE LS-09

SYMBOL DESCRIPTION

I-101

PRESERVE AND PROTECT EXISTING TREES AND/OR LANDSCAPE PLANTINGS TO REMAIN, THIS AREA. PRESERVE AND PROTECT EXISTING IRRIGATION LINES AND HEADS TO REMAIN ALONG EXISTING PAVING/WALKS. FIELD VERIFY EXTENTS OF EXISTING LANDSCAPE TO REMAIN AND ADJUST IRRIGATION EQUIPMENT AS NEEDED.

I-102 PRESERVE AND PROTECT EXISTING IRRIGATION
VALVES AND EQUIPMENT, THIS AREA. ENSURE THAT
THE OPERATION AND FUNCTION OF EXISTING
IRRIGATION ZONES IN THIS AREA ARE PRESERVED.

I-103
IRRIGATION PLAN IS DIAGRAMMATIC, TYP. ALL LINES, HEADS, VALVES AND OTHER IRRIGATION EQUIPEMENT SHALL BE INSTALLED IN LANDSCAPE AREAS WHERE POSSIBLE AND WITHIN PROJECT LIMITS UNLESS OTHERWISE NOTED.


I-104

IRRIGATION POINT OF CONNECTION 1 AT TEE OFF OF EXISTING 3" IRRIG. MAINLINE `D`. FIELD VERIFY LOCATION AND EQUIPMENT AND CONFIRM CONNECTION WITH OWNER'S REPRESENTATIVE. STATIC PRESSURE IS 70 PSI PER CITY OF LACEY.

PRESERVE TWO (2) EXISTING SPARE WIRES AT
EXISTING CONTROL VALVE TO REMAIN, THIS
LOCATION. FIELD VERIFY CONDITION AND OPERATION.
SPARE WIRES SHALL BE USED FOR CONNECTION TO
PROPOSED CONTROL VALVES CONNECTED TO POC 1

I-109 NO WORK THIS AREA



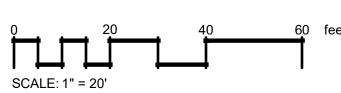

CALL BEFORE YOU DIG

THE CONTRACTOR SHALL BE FULLY RESPONSIBLE FOR THE LOCATION AND PROTECTION OF ALL EXISTING UTILITIES. THE CONTRACTOR SHALL VERIFY ALL UTILITY LOCATIONS PRIOR TO CONSTRUCTION BY CALLING THE UNDERGROUND LOCATE LINE AT 811 OR 1.800.424.5555 A MINIMUM OF 48 HOURS PRIOR TO ANY EXCAVATION.

SION

IRRIGATION

SOUTHEAST

LOT EXPAN ACOOM RD SE SEY, WA

PARKING | 8345 STEILA LACE


RAC


	09/13/
DESIGNER:	
J. MCFARLAND	
DRAWN BY:	
J. MCFARLAND	
APPROVED BY:	
J. GLANDER	
DATE:	
SEPT. 13, 2023	
IOD NO.	

DRAWING FILE NO:
__22-000313 X-LS

DRAWING NO:
LS-09
SHEET NO:

34 of 45

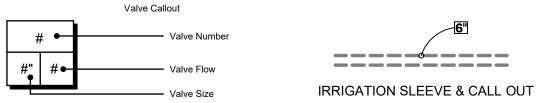

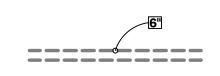

SCHEDULE LS-10					
MODEL	SIZE	TYPE	GPM	PSI	PSI @ POC
WEATHERMATIC MAX-DW	1"	TURF ROTARY	17.61	44.3	44.6
WEATHERMATIC MAX-DW-XPR DFXX-140	1-1/2"	AREA FOR DRIPLINE	25.31	37.2	37.8
1	WEATHERMATIC MAX-DW	WEATHERMATIC MAX-DW 1"	WEATHERMATIC MAX-DW 1" TURF ROTARY	WEATHERMATIC MAX-DW 1" TURF ROTARY 17.61	WEATHERMATIC MAX-DW 1" TURF ROTARY 17.61 44.3

MATCH-LINE SEE SHEET LS-08



IRRIGATION SHEET NOTES

- SEE DETAILS AND SPECIFICATIONS FOR ADDITIONAL INFORMATION.
- 2. PLAN IS DIAGRAMMATIC. ALL PIPING, LATERALS, AND WIRE TO BE LOCATED IN BED OR LAWN AREAS WHERE APPROPRIATE.
- 3. PIPE SIZES ARE TO REMAIN CONSTANT BETWEEN PIPE SIZE CALL-OUTS. PIPES ARE LABELED TO SMALLEST PIPE SIZE ONLY (3/4").
- 4. ALL IRRIGATION HEADS LOCATED IN LAWN AREAS SHALL BE 4" POP-UPS AND HEADS IN SHRUB AREAS SHALL BE 12" POP-UPS.
- 5. ALL DRIP TUBING SHALL BE INSTALLED BELOW THE FINISH SOIL GRADE UNLESS NOTED OTHERWISE. INSTALL TUBING AT A CONSISTENT DEPTH OF 2" BELOW TOP OF TOPSOIL.
- ALL PIPES AND SLEEVES UNDER PAVED AREAS SHALL BE 24" DEEP. ALL MAINLINE SHALL BE 18" DEEP IN ALL UNPAVED AREAS, 24" IN PAVED ARES. ALL LATERALS SHALL BE 12" DEEP IN ALL UNPAVED AREAS AND 24" DEEP IN PAVED AREAS.
- 7. LOCATE ALL MAINLINES WITHIN THE PROJECT LIMITS. INSTALL #14-AWG DIRECT BURIAL LOW VOLTAGE WIRE ALONG MAINLINE; TAPE AND BUNDLE WIRE EVER 20' FT. PROVIDE RED COLOR WIRE FOR SIGNAL AND WHITE COLOR WIRE FOR COMMON. PROVIDE A MINIMUM OF ONE SPARE WIRE FOR EVERY 10 VALVES FOR A MAXIMUM OF FIVE SPARE WIRES.
- 8. ALL WORK SHALL BE PERFORMED TO THE SATISFACTION OF THE LANDSCAPE ARCHITECT/OWNER.

IRRIGATION SCHEDULE LS-10

DESCRIPTION SYMBOL


I-101 PRESERVE AND PROTECT EXISTING TREES AND/OR LANDSCAPE PLANTINGS TO REMAIN, THIS AREA. PRESERVE AND PROTECT EXISTING IRRIGATION LINES AND HEADS TO REMAIN ALONG EXISTING PAVING/WALKS. FIELD VERIFY EXTENTS OF EXISTING LANDSCAPE TO REMAIN AND ADJUST IRRIGATION EQUIPMENT AS NEEDED.

I-102 PRESERVE AND PROTECT EXISTING IRRIGATION VALVES AND EQUIPMENT, THIS AREA. ENSURE THAT THE OPERATION AND FUNCTION OF EXISTING IRRIGATION ZONES IN THIS AREA ARE PRESERVED.

I-103 IRRIGATION PLAN IS DIAGRAMMATIC, TYP. ALL LINES, HEADS, VALVES AND OTHER IRRIGATION EQUIPEMENT SHALL BE INSTALLED IN LANDSCAPE AREAS WHERE POSSIBLE AND WITHIN PROJECT LIMITS UNLESS OTHERWISE NOTED.

I-105 IRRIGATION POINT OF CONNECTION 2 AT TEE OFF EXISTING 3" IRRIG. MAINLINE 'A'. FIELD VERIFY EQUIPMENT AND LOCATION, AND CONFIRM CONNECTION WITH OWNER'S REPRESENTATIVE. STATIC PRESSURE IS 70 PSI PER CITY OF LACEY.

I-107 PRESERVE FIVE (5) EXISTING SPARE WIRES AT EXISTING CONTROL VALVE TO REMAIN, THIS LOCATION. FIELD VERIFY CONDITION AND OPERATION. SPARE WIRES SHALL BE USED FOR CONNECTION TO PROPOSED CONTROL VALVES CONNECTED TO POC 2.

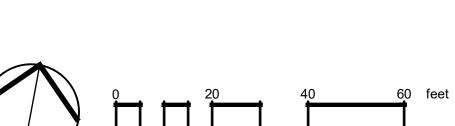

CITY DEPART 420 CO SION 귑 LOT EXPAN ACOOM RD SE SEY, WA IRRIGATION



PARKING | 8345 STEILA LACE

SOUTHWEST

DESIGNER:
J. MCFARLAND
DRAWN BY:
J. MCFARLAND
APPROVED BY:
J. GLANDER
DATE:
SEPT. 13, 2023
JOB NO:
22-000313

22-000313 X-LS DRAWING NO: LS-10 SHEET NO:

35 OF 45

DRAWING FILE NO:

CALL BEFORE YOU DIG

THE CONTRACTOR SHALL BE FULLY RESPONSIBLE FOR THE LOCATION AND PROTECTION OF ALL EXISTING UTILITIES. THE CONTRACTOR SHALL VERIFY ALL UTILITY LOCATIONS PRIOR TO CONSTRUCTION BY CALLING THE UNDERGROUND LOCATE LINE AT 811 OR 1.800.424.5555 A MINIMUM OF 48 HOURS PRIOR TO ANY EXCAVATION.




IRRIGATION SPECIFICATIONS

- THIS PLAN IS DIAGRAMMATIC; ALL PIPING, VALVES, ETC. SHALL BE INSTALLED IN SHRUB BEDS WHERE POSSIBLE AND SHALL FOLLOW THE PLAN AS CLOSE AS IS PRACTICAL.
- LOCATE ALL MAINLINES WITHIN THE PROJECT LIMITS.
- PIPE SIZES ARE CONSTANT BETWEEN PIPE SIZE CALL-OUTS. ALL LATERIAL PIPES SHALL BE INSTALLED AT 12" DEPTH AND 24" DEPTH UNDER PAVED AREAS. MAIINLINE PIPE SHALL BE INSTALLED AT 18" BELOW GRADE AND 24" BELOW PAVED AREAS.
- REFER TO DETAILS FOR ADDITIONAL INFORMATION.
- ALL PIPING AND WIRING UNDER PAVED AREAS SHALL BE HOUSED IN CLASS 200 PVC SLEEVES INSTALLED AT A 24" DEPTH. SIZE SLEEVES AS NEEDED TO ACCOMMODATE PIPE AND WIRES, UNLESS OTHERWISE SPECIFIED ON DRAWING.
- CONTRACTOR SHALL MAKE FIELD ADJUSTMENTS AS NEEDED TO OBTAIN FULL COVERAGE. LANDSCAPE ARCHITECT RESERVES THE RIGHT TO MAKE NOZZLE CHANGES AS NEEDED AT NO ADDITIONAL COST. ADJUST HEAD POSITIONS AND ADD OR DELETE HEADS AS NEEDED DEPENDING ON ACTUAL FIELD CONDITIONS.
- 7. ALL MANUAL, GATE AND ELECTRICAL VALVES AND OTHER UNDERGROUND EQUIPMENT SHALL BE HOUSED IN NELSON, AMETEK OR EQUAL RECTANGULAR VALVE BOXES.
- NO IN-LINE WIRE SPLICES ALLOWED. SUPPLY VALVE BOXES AT ALL ELECTRICAL JUNCTIONS. TAPE AND BUNDLE WIRES EVERY 25 LINEAR FEET.
- CONTRACTOR IS RESPONSIBLE FOR COMPLETE SYSTEM DRAINAGE. INSTALL KING BROS. 1/2" AUTOMATIC DRAIN VALVES AT LATERAL LINE LOW POINT(S). INSTALL MANUAL DRAINS AT ALL MAINLINE LOW POINT(S) AND WHERE INDICATED ON PLAN. CONTRACTOR SHALL PROVIDE ADJUSTABLE CHECK VALVES ON ANY IRRIGATION HEAD THAT EXPERIENCES LOW HEAD DRAINAGE.
- 10. ALL THREADED PIPE CONNECTIONS SHALL BE MADE USING TEFLON TAPE WRAPPED AT LEAST THREE TIMES AROUND PIPE THREADS.
- 11. ALL GATE AND ELECTRIC VALVES SHALL BE INSTALLED WITH UNIONS ON THE DOWNSTREAM END OF THE VALVE (REFER TO DETAILS).
- 12. ALL PIPE SHALL HAVE A FIRM UNIFORM BEARING FOR THE ENTIRE LENGTH OF EACH LINE, FREE OF ROCKS OR DEBRIS. ALL TRENCHES CONTAINING PIPE AND/OR WIRES SHALL BE BACKFILLED WITH CLEAN TOPSOIL, FREE OF ALL LUMBER, RUBBISH AND ROCKS OVER 1" IN SIZE, OR CLEAN SAND IF CLEAN TOPSOIL IS NOT AVAILABLE.
- EXACT ACTUAL LOCATIONS OF ALL SPRINKLER EQUIPMENT. CONTRACTOR SHALL ORIENT OWNER WITH COMPLETE SYSTEM AND CONTROLLER OPERATIONS, AND WINTERIZATION PROCEDURES.
- 14. CONTRACTOR SHALL SUPPLY AND INSTALL ALL EQUIPMENT SHOWN ON THE PLANS AND INDICATED IN THE SPECIFICATIONS TO ACHIEVE PROPER OPERATION OF SAID EQUIPMENT. ALL EQUIPMENT INSTALLATIONS, ELECTRICAL AND PLUMBING CONNECTIONS SHALL BE IN CONFORMANCE WITH ALL APPLICABLE CODES AND ORDINANCES, THESE SPECIFICATIONS, AND THE MANUFACTURERS RECOMMENDATIONS WHETHER INDICATED ON THE DRAWINGS OR NOT.
- CONTRACTOR SHALL INCLUDE IN HIS BID ONE FALL WINTERIZATION AND ONE SPRING ACTIVATION OF IRRIGATION SYSTEM. THESE ACTIVITIES SHALL BE INCLUDED AS PART OF OWNER ORIENTATION PROCEDURES. ANY DAMAGE TO THE IRRIGATION SYSTEM OR THE LANDSCAPE AS A RESULT OF FAILURE TO COMPLY WITH THESE REQUIREMENTS SHALL BE THE SOLE RESPONSIBILITY OF THE CONTRACTOR.
- 16. CONTRACTOR SHALL GUARANTEE IN WRITING ON HIS COMPANY LETTERHEAD ALL MATERIALS AND WORKMANSHIP FOR A PERIOD OF ONE FULL YEAR FOLLOWING ACCEPTANCE OF SYSTEM INSTALLATION.

- 17. BACKFLOW PREVENTOR SHALL BE INSPECTED AND TESTED BY A CERTIFIED BACKFLOW DEVICE INSPECTOR. PROVIDE OWNER WITH ONE COPY OF APPROVAL CERTIFICATE.


CALL BEFORE YOU DIG

HE CONTRACTOR SHALL BE FULLY RESPONSIBLE FOR THE LOCATION AND PROTECTION OF ALL EXISTING UTILITIES. THE CONTRACTOR SHALL VERIFY ALL UTILITY LOCATIONS PRIOR TO CONSTRUCTION BY CALLING THE UNDERGROUND LOCATE LINE AT 811 OR 1.800.424.5555 A MINIMUM OF 48 HOURS PRIOR TO ANY EXCAVATION.

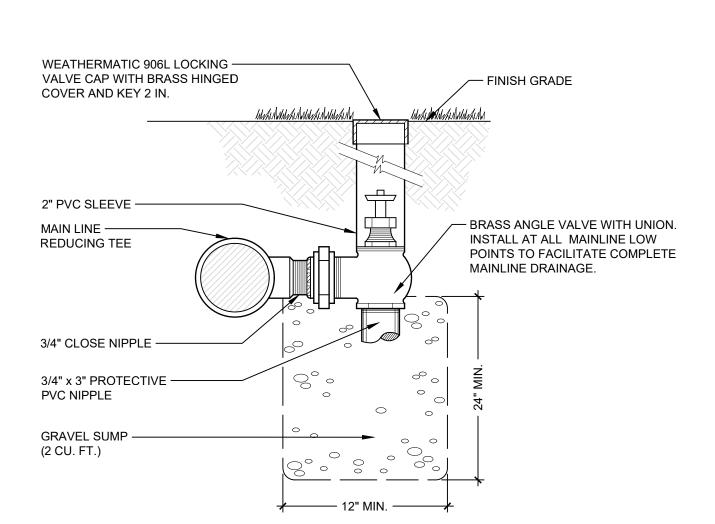



IANUAL DRAIN VALVE DETAIL P-PU-RAC-04



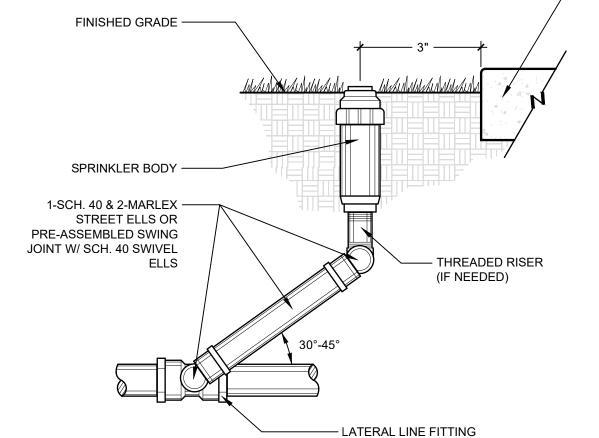



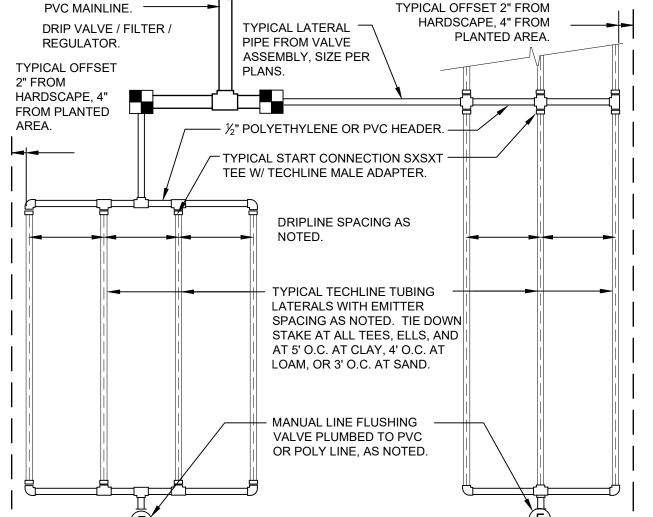

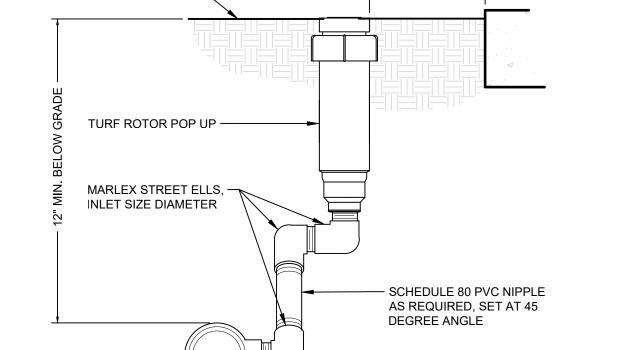

NOTE: ALL WIRES TO BE INSTALLED AS PER LOCAL CODES. NO "IN-LINE" WIRE SPLICES

CLEAR TO FENCE OR HARDSCAPE, WHERE

APPLICABLE.

ELECTRONIC CONTROL VALVE

FINISHED GRADE -

ALLOWED. TAPE AND BUNDLE WIRES EVERY 20 FEET. PROVIDE EXPANSION COILS AT EACH VALVE - WRAPPING WIRE AROUND 1/2" PIPE 15 TIMES. ALL THREADED CONNECTIONS SHALL

- FINISH GRADE AT LIP OF

BOX IN TURF AND PAVED

AREAS: 1" BELOW LIP IN

ELECTRIC CONTROL VALVE

- SUPPORT VALVE **BOX WITH 4** BRICKS, TYP.

- SCH. 80 PVC UNION

PROVIDE A MIN. 3"

SCH. 40 PVC FITTING

PRESSURE MAINLINE

P-PU-RAC-12

CLEARANCE


SCH. 40 PVC & FITTING

ALL OTHER AREAS




DRIPPER FLOW RATE (GPH) 0.26 0.4 0.6 0.9 0.26 0.4					0.4	0.6	0.9	0.6	0.9												
		RE	15	127	7	109	86	65	177	151	120	91	152	116							
		I —	PRESSURE	25	427	7	325	256	194	604	459	361	274	458	348						
				_	_	_	_		_	I —	_	35	539	9	409	322	244	763	579	456	346
		INLET (PSI)	45	618	8	469	369	280	877	664	523	397	666	506							
TECHLI	NE	CV FL	OW PE	ER 1	100	FEE	Γ		•			•	•	•							
DRIPPER	0.26	GPH DI	RIPPER	0.4 GPH DRIPPER (0.6 GPF	I DRIPP	ER	0.9 GF	PH DRIF	PPER									
SPACING	GI	PH	GPM		(3PH	GP	М	GPH	G	PM	GPH	I	GPM							
12"	26	6.40	0.44		0.44		0.44		40.00	40.00 0.67	7	61.00	1.	1.02	92.00	0	1.53				
18"	17	7.58	0.29			26.67 0.44		41.00	0.	0.68 61.00	0	1.02									
24" N/A N/A			N/A		N/A		31.00	0.	0.51		0	0.77									

WATER SOURCE: DRIP VALVE OR LATERAL FROM VALVE.	MANUAL LINE FLUSING VALVE PLUMBED TO PVC OR POLY.
TYPICAL SUPPLY HEADER.	
TYPICAL TECHLINE DRIPPER LINE TUBING. TYPICAL PVC OR POLY SUPPLY OR EXHAUST HEADER.	

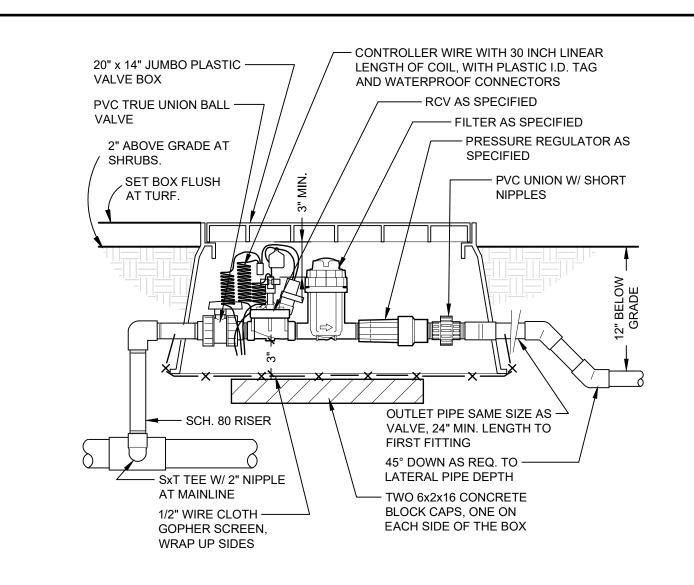




P-PU-RAC-08

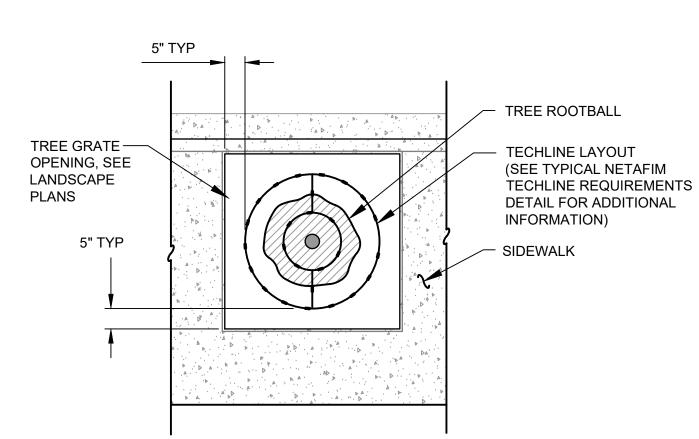



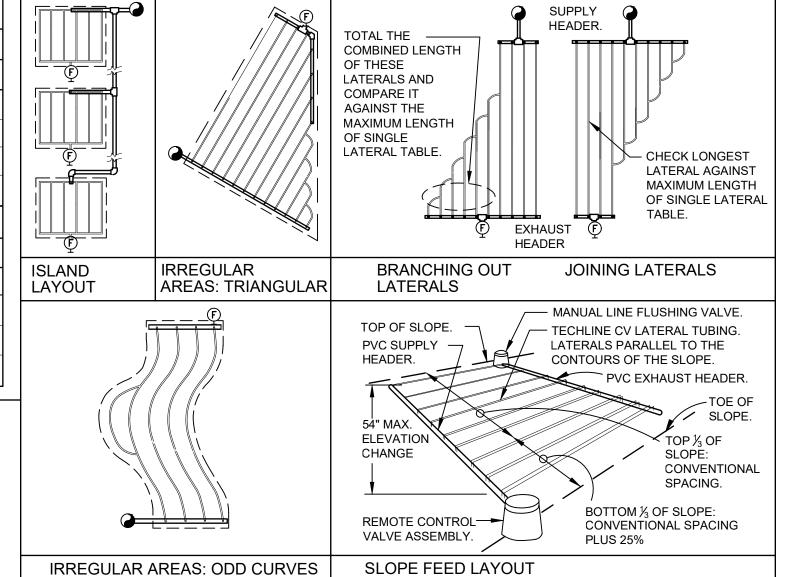



END FEED EXAMPLE

J. MCFARLAND DRAWN BY: J. MCFARLAND PPROVED BY: J. GLANDER SEPT. 13, 2023 JOB NO: 22-000313

RAWING FILE NO: 22-000313 X-LS DRAWING NO: LS-11

36 of 45

SHEET NO:

P-PU-RAC-34

13. CONTRACTOR SHALL PROVIDE OWNER WITH ONE SET OF AS-BUILT RECORD DRAWINGS SHOWING

CENTER FEED EXAMPLE

P-PU-RAC-05

TECHLINE CV MAXIMUM LENGTH OF SINGLE LATERAL (FEET)

VALVE BOX & COVER; —

DETAILS, PROVIDE

AS REQUIRED.

REFER TO IRRIGATION

SHEET NOTES AND/OR

VALVE BOX EXTENSIONS

i Maddadhaddadhaddadhaddadh

SCH. 80 PVC UNION -

LATERAL PIPE TO -

MINIMUM 6" DEPTH

OF PEA GRAVEL

LOW VOLTAGE WIRES

BE MADE WITH TEFLON TAPE.

SPRINKLERS

GENERAL CONSTRUCTION NOTES

- ELECTRICAL DRAWINGS ARE DIAGRAMMATIC IN NATURE. THE CONTRACTOR SHALL BE FAMILIAR WITH THE SITE AND CONDITIONS, AND SHALL NOT RELY SOLELY ON REVIEW OF THE DOCUMENTS IN DETERMINING THE EXTENT OF WORK REQUIRED. COORDINATION OF THESE DRAWINGS WITH REQUIREMENTS FOR CONTRACT WORK IS THE RESPONSIBILITY OF THE CONTRACTOR.
- CONTRACTOR IS RESPONSIBLE FOR ALL PERMITS AND UTILITY FEES.
- SEE EACH SHEET FOR ADDITIONAL GENERAL NOTES THAT ARE SPECIFIC TO AN AREA OR SHEET.
- MATERIALS AND WORKMANSHIP SHALL FULLY COMPLY WITH THE REQUIREMENT OF THE LATEST EDITION OF THE NATIONAL ELECTRICAL CODE (N.F.P.A. #70), THE LAWS AND REGULATION OF WASHINGTON STATE, AND THE LOCAL AHJ OF ALL WORK AND MATERIAL TO BUILDING STANDARDS AND CODE UNLESS NOTED OTHERWISE.
- 7. ALL PVC CONDUITS SHALL CONTAIN EQUIPMENT GROUNDING CONDUCTOR. ALL CONDUITS UNDER THE ROADWAY SHALL BE PVC SCHEDULE 80.

STREET LIGHTING CONSTRUCTION NOTES

- ALL WORK TO BE PROVIDED AND INSTALLED PER THE CITY OF LACEY AND WSDOT STANDARDS.
- PROVIDE POLE AND BRACKET CABLE UP EACH POLE.
- ALL LUMINARIES SHALL HAVE FUSES LOCATED AT THE POLE BASE.
- ALL SPLICES SHALL BE MADE IN JUNCTION BOXES.
- PROVIDE NUMBERING ON EACH POLE PER CITY OF LACEY STANDARDS.
- E.C. TO CONTACT THE LACEY PLANNING DEPARTMENT FOR THE MAXIMUM ALLOWED POLE HEIGHT PRIOR TO ORDERING.

ADDITIVE ALTERNATES



ADDITIVE ALTERNATE #1:

UNDER BASE BID, PROVIDE ROUGH-IN ONLY FOR FUTURE EV CHARGING STATION #5, AS NOTED IN THESE DRAWINGS.

ALTERNATE: UNDER ALTERNATE BID, FURNISH AND INSTALL EV CHARGING STATION #5, CHARGEPOINT CPE250, 480V/3P EV CHARGING STATION, COMPLETE WITH ALL HARDWARE, TERMINATIONS, APPURTENANCES, AND COMMISSIONING FOR A FULLY FUNCTIONAL SYSTEM, PROVIDE WITH 5-YEAR SERVICE AGREEMENT AND CLOUD PLAN. COORDINATE WITH GC AND THE SITE CONTRACTOR FOR INSTALLATION OF BOLLARDS UNDER THIS ALTERNATE.



ADDITIVE ALTERNATE #2:

UNDER BASE BID, PROVIDE ROUGH-IN ONLY FOR FUTURE EV CHARGING STATION #6, AS NOTED IN THESE DRAWINGS.

ALTERNATE:

UNDER ALTERNATE BID, FURNISH AND INSTALL EV CHARGING STATION #6, CHARGEPOINT CPE250, 480V/3P EV CHARGING STATION, COMPLETE WITH ALL HARDWARE, TERMINATIONS, APPURTENANCES, AND COMMISSIONING FOR A FULLY FUNCTIONAL SYSTEM. PROVIDE WITH 5-YEAR SERVICE AGREEMENT AND CLOUD PLAN. COORDINATE WITH GC AND THE SITE CONTRACTOR FOR INSTALLATION OF BOLLARDS UNDER THIS ALTERNATE.


SEC. 14, T 18N., R 1W., W.M.

SYMBOL	DESCRIPTION				
	LIGHTING				
•	PARKING LOT POLE LIGHT FIXTURE (ARROW INDICATES DIRECTION OF AIMING FOR OPTICS)				
•—	STREET LIGHT FIXTURE (ARROW INDICATES DIRECTION OF AIMING FOR OPTICS)				
	EQUIPMENT, WIRING AND RACEWAYS				
E	CONDUIT STUB OUT (PROVIDE CONCRETE MARKER ON EXTERIOR)				
•	DEDICATED CONDUIT HOMERUN TO PANEL & CIRCUIT NUMBERS AS INDICATED ON PLANS				
	RACEWAY CONCEALED IN WALL OR CEILING				
/	RACEWAY CONCEALED UNDERGROUND OR UNDER FLOOR SLAB				
#	MARKS INDICATE NUMBER OF #12 AWG UNLESS NOTED OTHERWISE				
	GROUNDING CONDUCTOR				
0	JUNCTION BOX - SIZE PER CODE				
НН	SITE HANDHOLE				
	MISCELLANEOUS				
1	CONSTRUCTION NOTES				
1	DEMOLITION NOTES				
W	W INDICATES WEATHERPROOF FOR ALL DEVICES, PROVIDE LOCKING COVER ON RECEPTACLES.				
WG	WG INDICATES WIRE GUARD				
\$	ALL DEVICES WITH LIGHT LINE WEIGHT INDICATES EXISTING TO BE RETAINED				
\$	ALL DEVICES WITH DASH LINE INDICATES EXISTING TO BE REMOVED				
$\begin{pmatrix} A \\ X \end{pmatrix}$	DETAIL CALL OUT - A INDICATES DETAIL IDENTIFICATION, X INDICATES SHEET DRAWN ON				
	CCTV SYSTEM				
C	FIXED POLE MOUNT CAMERA - MOUNT AT +30' AFG. PROVIDE CAMERA AND ACCESSORIES AS SPECIFIED FOR EACH LOCATION.				

AIC	AMPERE INTERRUPTING CAPACITY		
AFC	AVAILABLE FAULT CURRENT		
AL	ALUMINUM		
ATS	AUTOMATIC TRANSFER SWITCH		
AWG	AMERICAN WIRE GUAGE		
C.	CONDUIT		
СО	CONDUIT ONLY		
CU	COPPER		
EMT	ELECTRICAL METALLIC TUBING		
FLA	FULL LOAD AMPERE(S)		
G	GROUND FAULT CIRCUIT INTERRUPTER		
GFI	GROUND FAULT INTERRUPTER		
GND	GROUND		
GR	GROUND		
KVA	KILOVOLT-AMPERE(S)		
KW	KILOWATT(S)		
LCP	LIGHTING CONTROL PANEL		
LED	LIGHT-EMITTING DIODE(S)		
LTG	LIGHTING		
MCA	MINIMUM CIRCUIT AMPACITY		
MCB	MAIN CIRCUIT BREAKER		
MLO	MAIN LUGS ONLY		
NEMA	NATIONAL ELECTRICAL MANUFACTURERS ASSOCIATION		
NTS	NOT TO SCALE		
PH	PHASE		
SCH	SCHEDULE		
SPD	SURGE PROTECTION DEVICE		
UG	UNDER GROUND		
V	VOLT(S)		
VA	VOLT-AMPERE(S)		
WR	WIRE(S)		
XFMR	TRANSFORMER		

	ELECTRICAL ABBREVIATIONS			
AIC	AMPERE INTERRUPTING CAPACITY			
AFC	AVAILABLE FAULT CURRENT			
AL	ALUMINUM			
ATS	AUTOMATIC TRANSFER SWITCH			
AWG	AMERICAN WIRE GUAGE			
C.	CONDUIT			
СО	CONDUIT ONLY			
CU	COPPER			
EMT	ELECTRICAL METALLIC TUBING			
FLA	FULL LOAD AMPERE(S)			
G	GROUND FAULT CIRCUIT INTERRUPTER			
GFI	GROUND FAULT INTERRUPTER			
GND	GROUND			
GR	GROUND			
KVA	KILOVOLT-AMPERE(S)			
KW	KILOWATT(S)			
LCP	LIGHTING CONTROL PANEL			
LED	LIGHT-EMITTING DIODE(S)			
LTG	LIGHTING			
MCA	MINIMUM CIRCUIT AMPACITY			
MCB	MAIN CIRCUIT BREAKER			
MLO	MAIN LUGS ONLY			
NEMA	NATIONAL ELECTRICAL MANUFACTURERS ASSOCIATION			
NTS	NOT TO SCALE			
PH	PHASE			
SCH	SCHEDULE			
SPD	SURGE PROTECTION DEVICE			
UG	UNDER GROUND			
V	VOLT(S)			
VA	VOLT-AMPERE(S)			
WR	WIRE(S)			
XFMR	TRANSFORMER			

LIGHTING FIXTURE SCHEDULE						
SYMBOL	FIXTURE DESCRIPTION	MANUFACTURER/MODEL #	LAMPS	V	W	MOUNTING & REMARKS
AL1A	SINGLE HEAD LED PARKING LOT FIXTURE	LITHONIA #: HEAD: DSX2 LED-XX-40K-70CRI-XXX-MVOLT-RPA-NLTAIR2-PIRHN-DBLXD POLE: RSS-5B-DM19-TP-DBLBXD	LED 4000K	120/277	160	PROVIDE WITH 5" DIAMETER 30' STEEL ROUND POLE
AL1B	SINGLE HEAD LED PARKING LOT FIXTURE	LITHONIA #: HEAD: DSX2 LED-XX-40K-70CRI-XXX-MVOLT-RPA-NLTAIR2-PIRHN-DBLXD POLE: RSS-5B-DM19-TP-DBLBXD	LED 4000K	120/277	160	PROVIDE WITH 5" DIAMETER 30' STEEL ROUND POLE
AL1C	DOUBLE HEAD LED PARKING LOT FIXTURE	LITHONIA #: HEAD: DSX2 LED-XX-40K-70CRI-XXX-MVOLT-RPA-NLTAIR2-PIRHN-DBLXD POLE: RSS-5B-DM28-TP-DBLBXD	LED 4000K	120/277	320	PROVIDE WITH 5" DIAMETER 30' STEEL ROUND POLE
AL2	LED WIDE BEAM FLOOD LIGHT	BEGA # 77479-K40 (BLK)	LED 4000K	120/277	17.9	PROVIDE WITH DIRECT BURIAL WIRING BOX AND 180- DEGREE GLARE SHIELD. SEE 5/E-701 FOR BASE DETAIL. INSTALL FIXTURES 4FT FROM BASE OF WALL AND AIM FOR EVEN DISTRIBUTION OF LIGHT.
STL	CITY OF LACEY STREET LIGHTING FIXTURE	PHILLIPS LUMEC #: STREET LIGHT: RFM-72W32LED4K-G2-R3M-UNIV-RCD PEDESTRIAN LIGHT: L80-STYLE LANTERN BASE: OLYMPIC FOUNDARY FG3548-BK FINISH: TEXTURED BLACK POWDER COAT	LED 70 CRI 4000K 8780 DELIVERED LUMENS BUG RATING B2-U0-G2 INPUT DESIGNATOR "B"	240	70	PROVIDE 30'-0" ROUND TAPERED ALUMINUM POLE WITH HANDHOLE AT BASE LOCATED 90-DEGREES FROM BRACKET ARM. PROVIDE 6'-0" LONG TAPERED ARM FOR STREET LIGHT AND AN SFS ADAPTER AT 15'-0" FOR PEDESTRIAN SCALE FIXTURE.

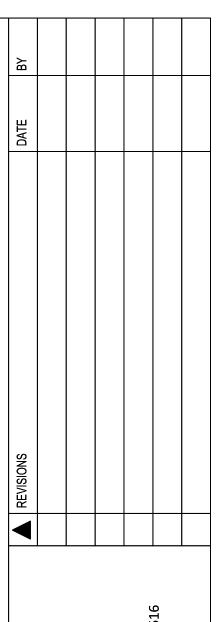



G LIGHTIN PARKING LOT I 8345 STEILACOON LACEY, WA AND LEGEND A

SHEETTITLE:
ELECTRICAL I

DESIGNER: DRAWN BY: APPROVED BY:

BH JOB NO:


34 of 42

22-000313 DRAWING FILE NO: 222-147 E-001 DRAWING NO: E-001

SHEET NO:

CALL BEFORE YOU DIG

THE CONTRACTOR SHALL BE FULLY RESPONSIBLE FOR THE LOCATION AND PROTECTION OF ALL EXISTING UTILITIES. THE CONTRACTOR SHALL VERIFY ALL UTILITY LOCATIONS PRIOR TO CONSTRUCTION BY CALLING THE UNDERGROUND LOCATE LINE AT 811 OR 1.800.424.5555 A 호통|MINIMUM OF 28 HOURS PRIOR TO ANY EXCAVATION.

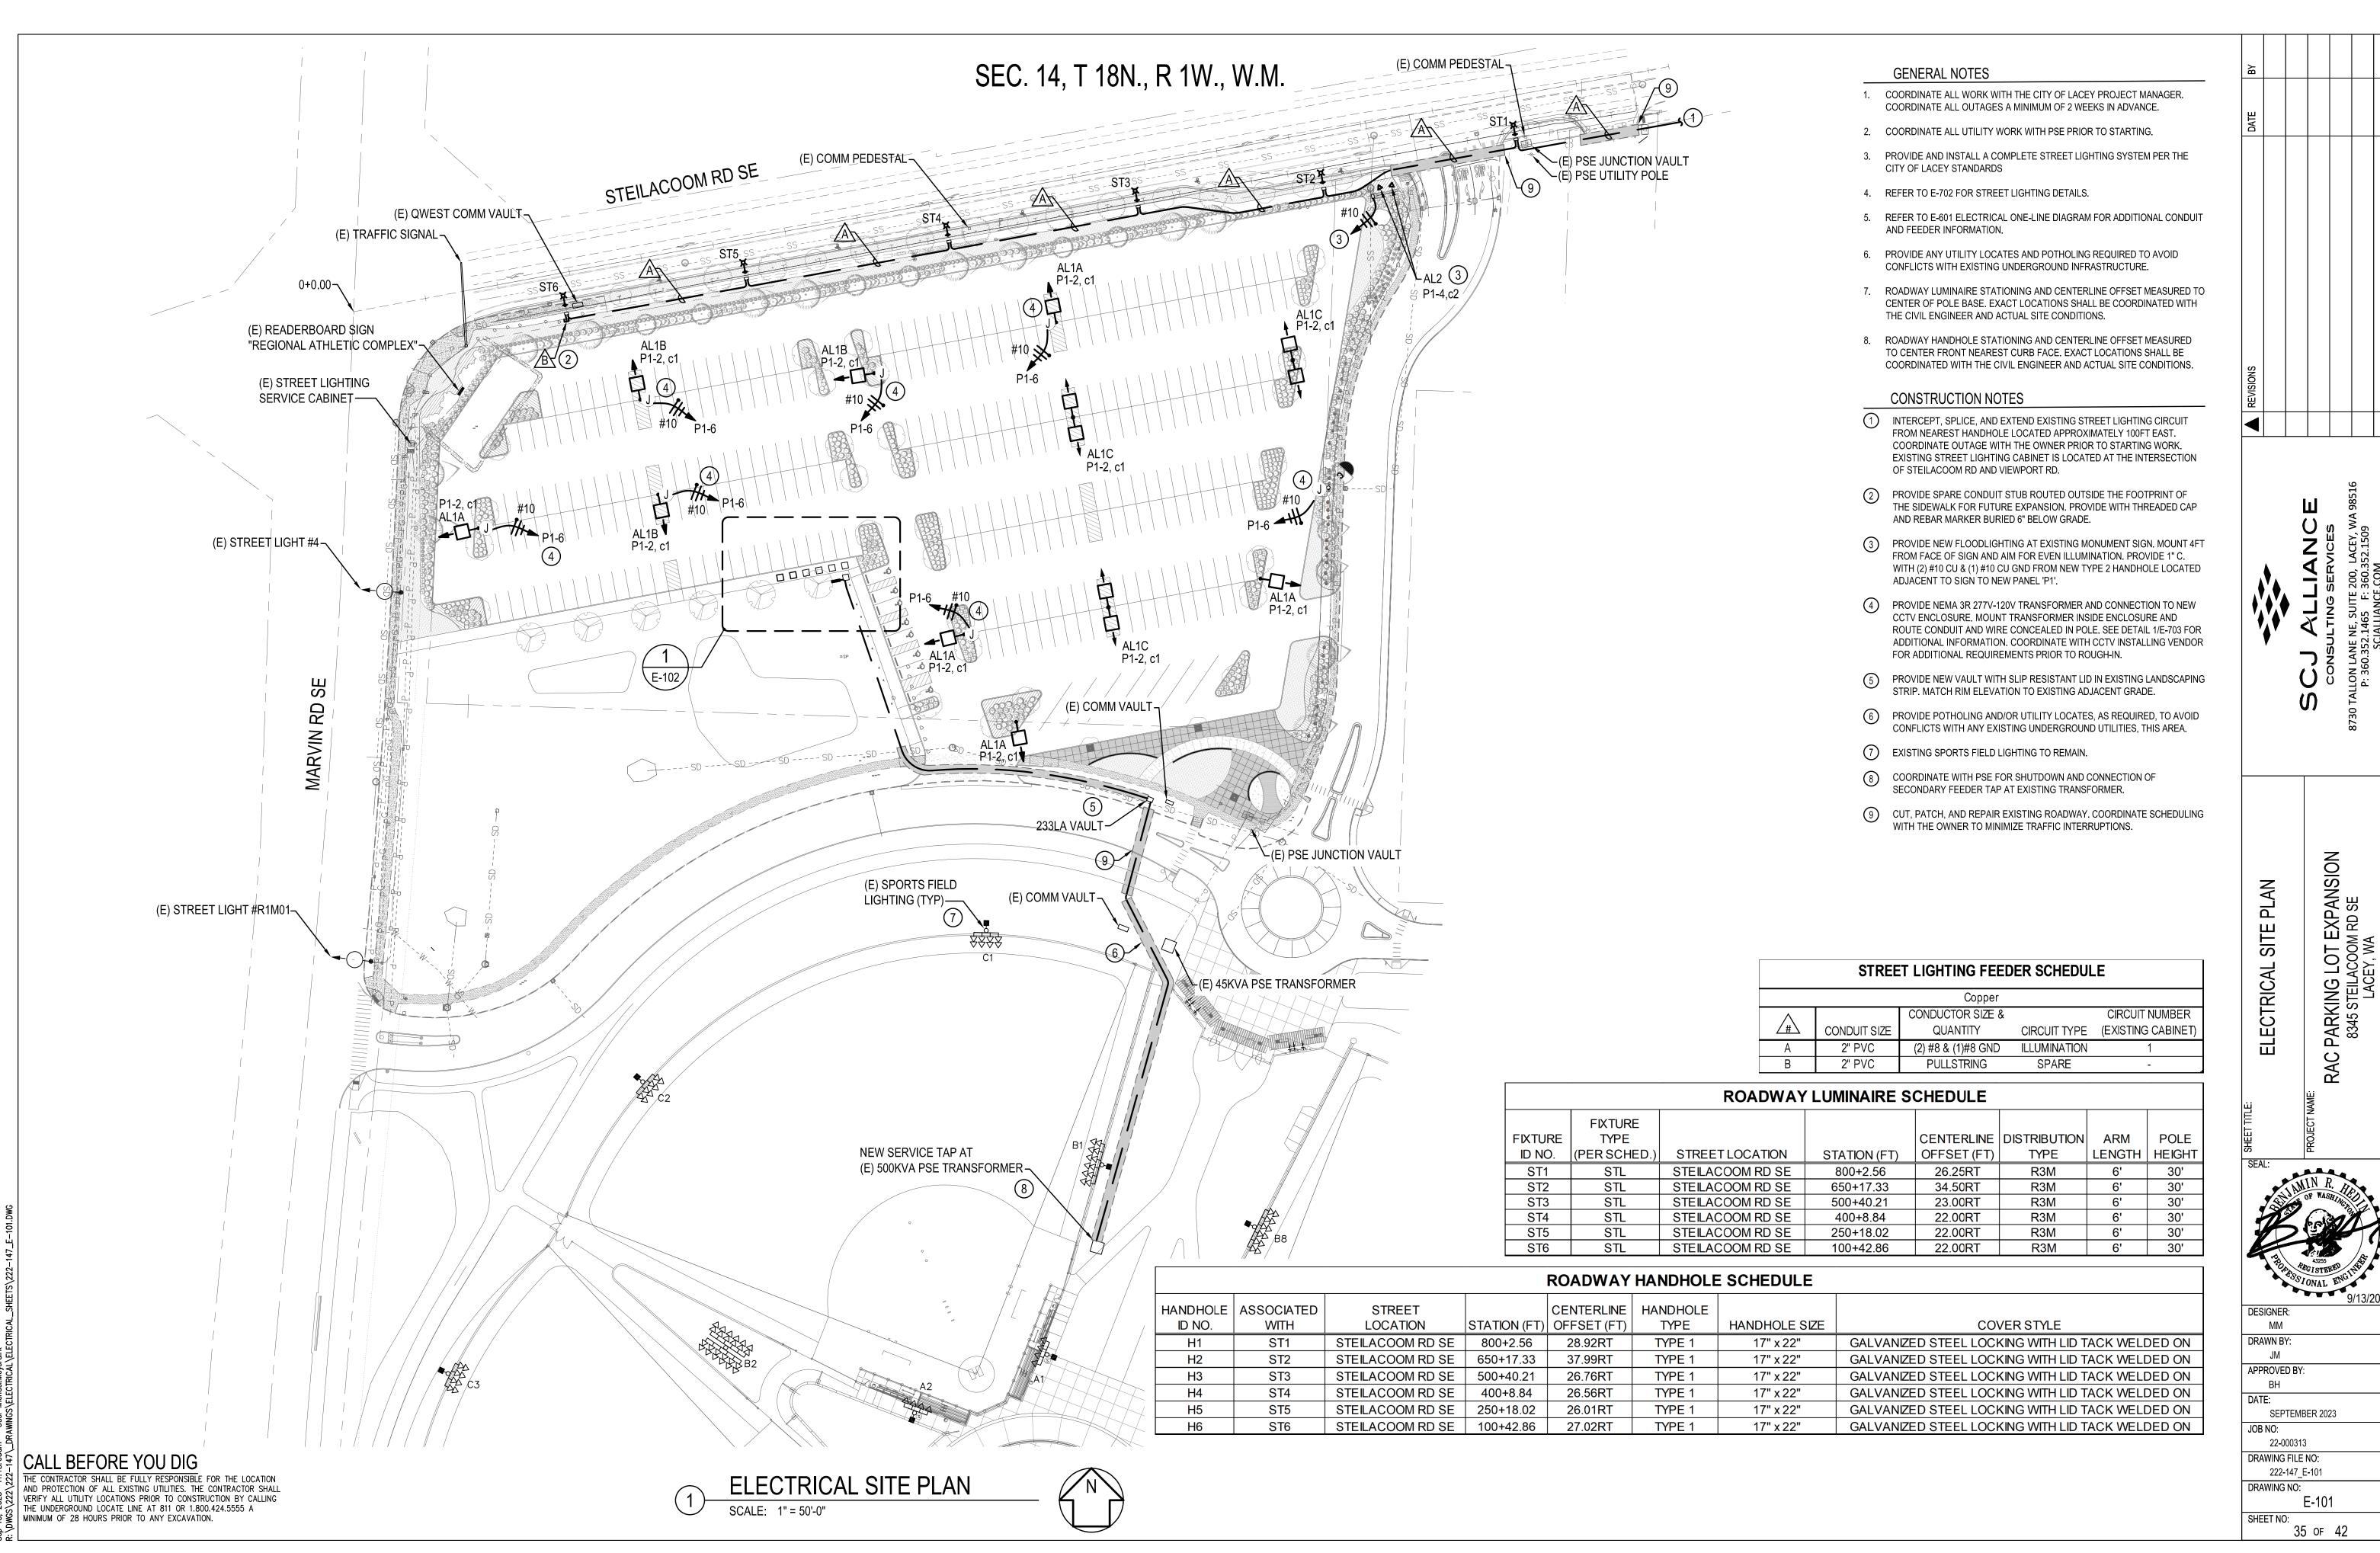

GENERAL NOTES

1. REFER TO E-601 ELECTRICAL ONE-LINE DIAGRAM FOR ADDITIONAL CONDUIT AND FEEDER INFORMATION.

CONSTRUCTION NOTES

- 1) REFER TO E-601 ELECTRICAL ONE-LINE DIAGRAM FOR ADDITIONAL CONDUIT AND FEEDER INFORMATION.
- PROVIDE CHARGEPOINT CPE250, 480V/3P EV CHARGING STATION, COMPLETE WITH ALL HARDWARE, TERMINATIONS, APPURTENANCES, AND COMMISSIONING FOR A FULLY FUNCTIONAL SYSTEM. PROVIDE WITH 5-YEAR SERVICE AGREEMENT AND CLOUD PLAN.
- UNDER BASE BID, PROVIDE 1-1/2" CONDUIT STUB WITH PULLSTRING AND THREADED CAP. PROVIDE WITH REBAR MARKER BURIED 6" BELOW GRADE. LOCATE STUB 12" BEHIND SIDEWALK EDGE.
- BOLLARDS TO BE INSTALLED PER MANUFACTURER RECOMMENDATIONS. REFER TO MANUFACTURER INSTALLATION GUIDES FOR EXACT SPACING AND CLEARANCE REQUIREMENTS. COORDINATE WITH GC AND SITE CONTRACTOR FOR LAYOUT AND INSTALLATION PRIOR TO INSTALLATION OF EV CHARGERS.

REVISIONS DATE BY



ECTRICAL SITE PLAN
PARKING LOT EXPANSION

SEAL:

NO. WASHINGTON

AND THE COMPANY OF WASHINGTON

AND THE

DESIGNER:

MM

DRAWN BY:

JM

APPROVED BY:

BH

BH
DATE:
SEPTEMBER 2023
JOB NO:

22-000313

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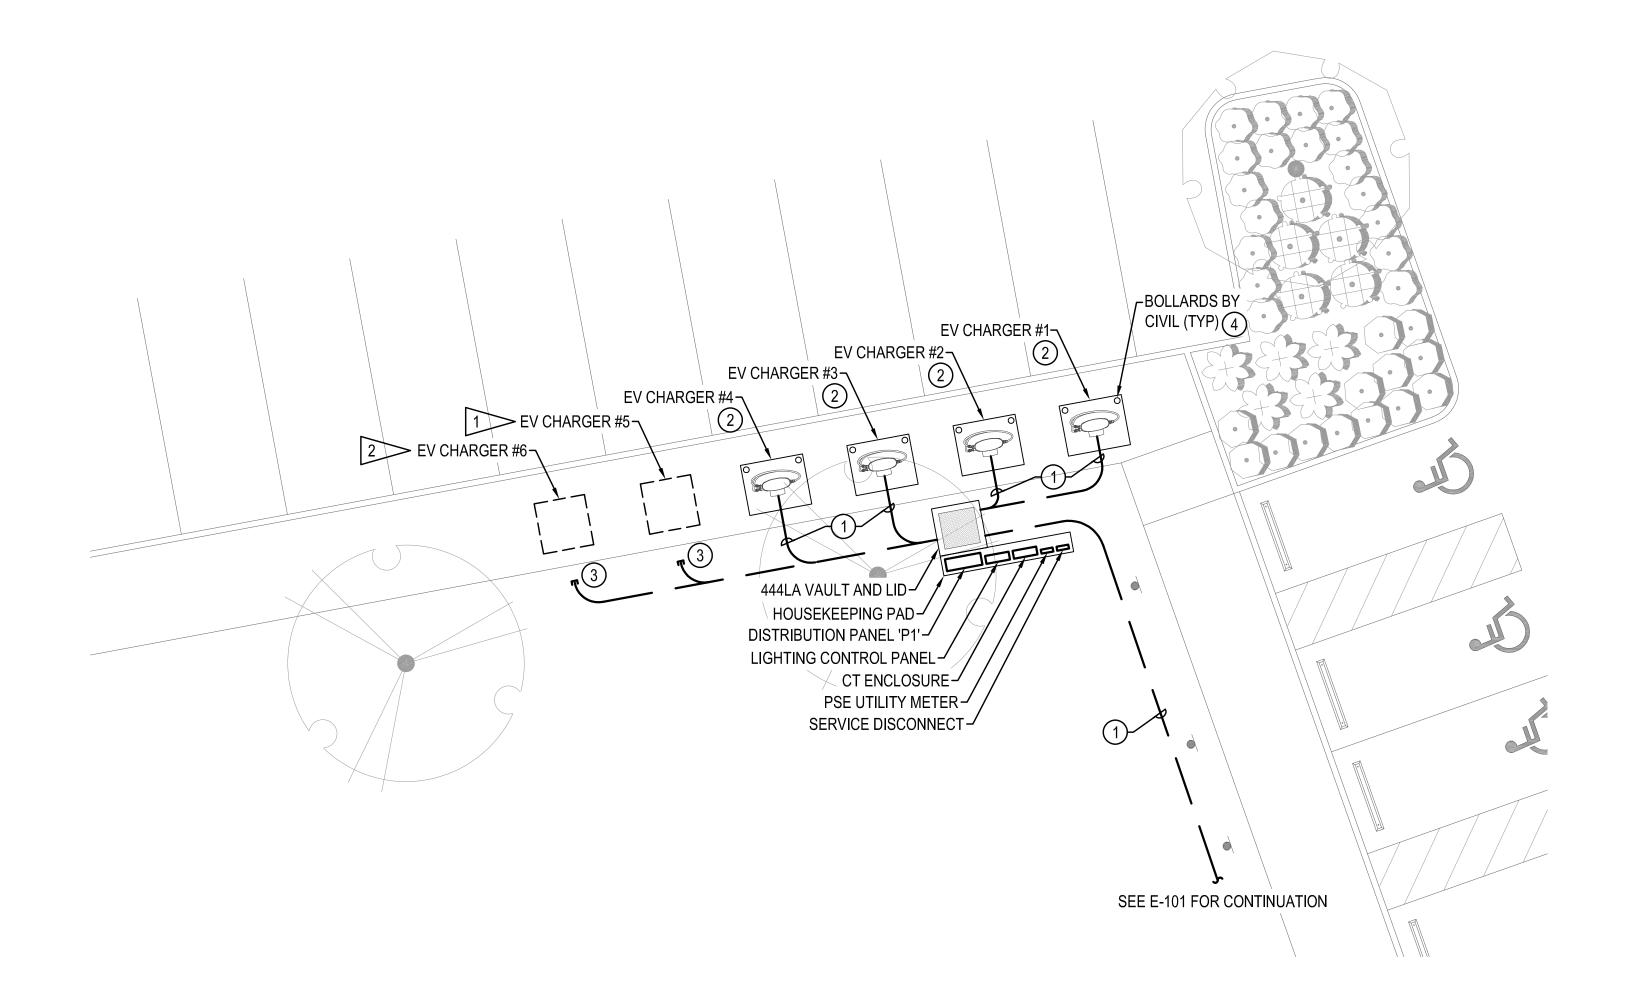
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SHEET NO:

36 of 42

ENLARGED POWER PLAN

SCALE: 1/8" = 1'-0"





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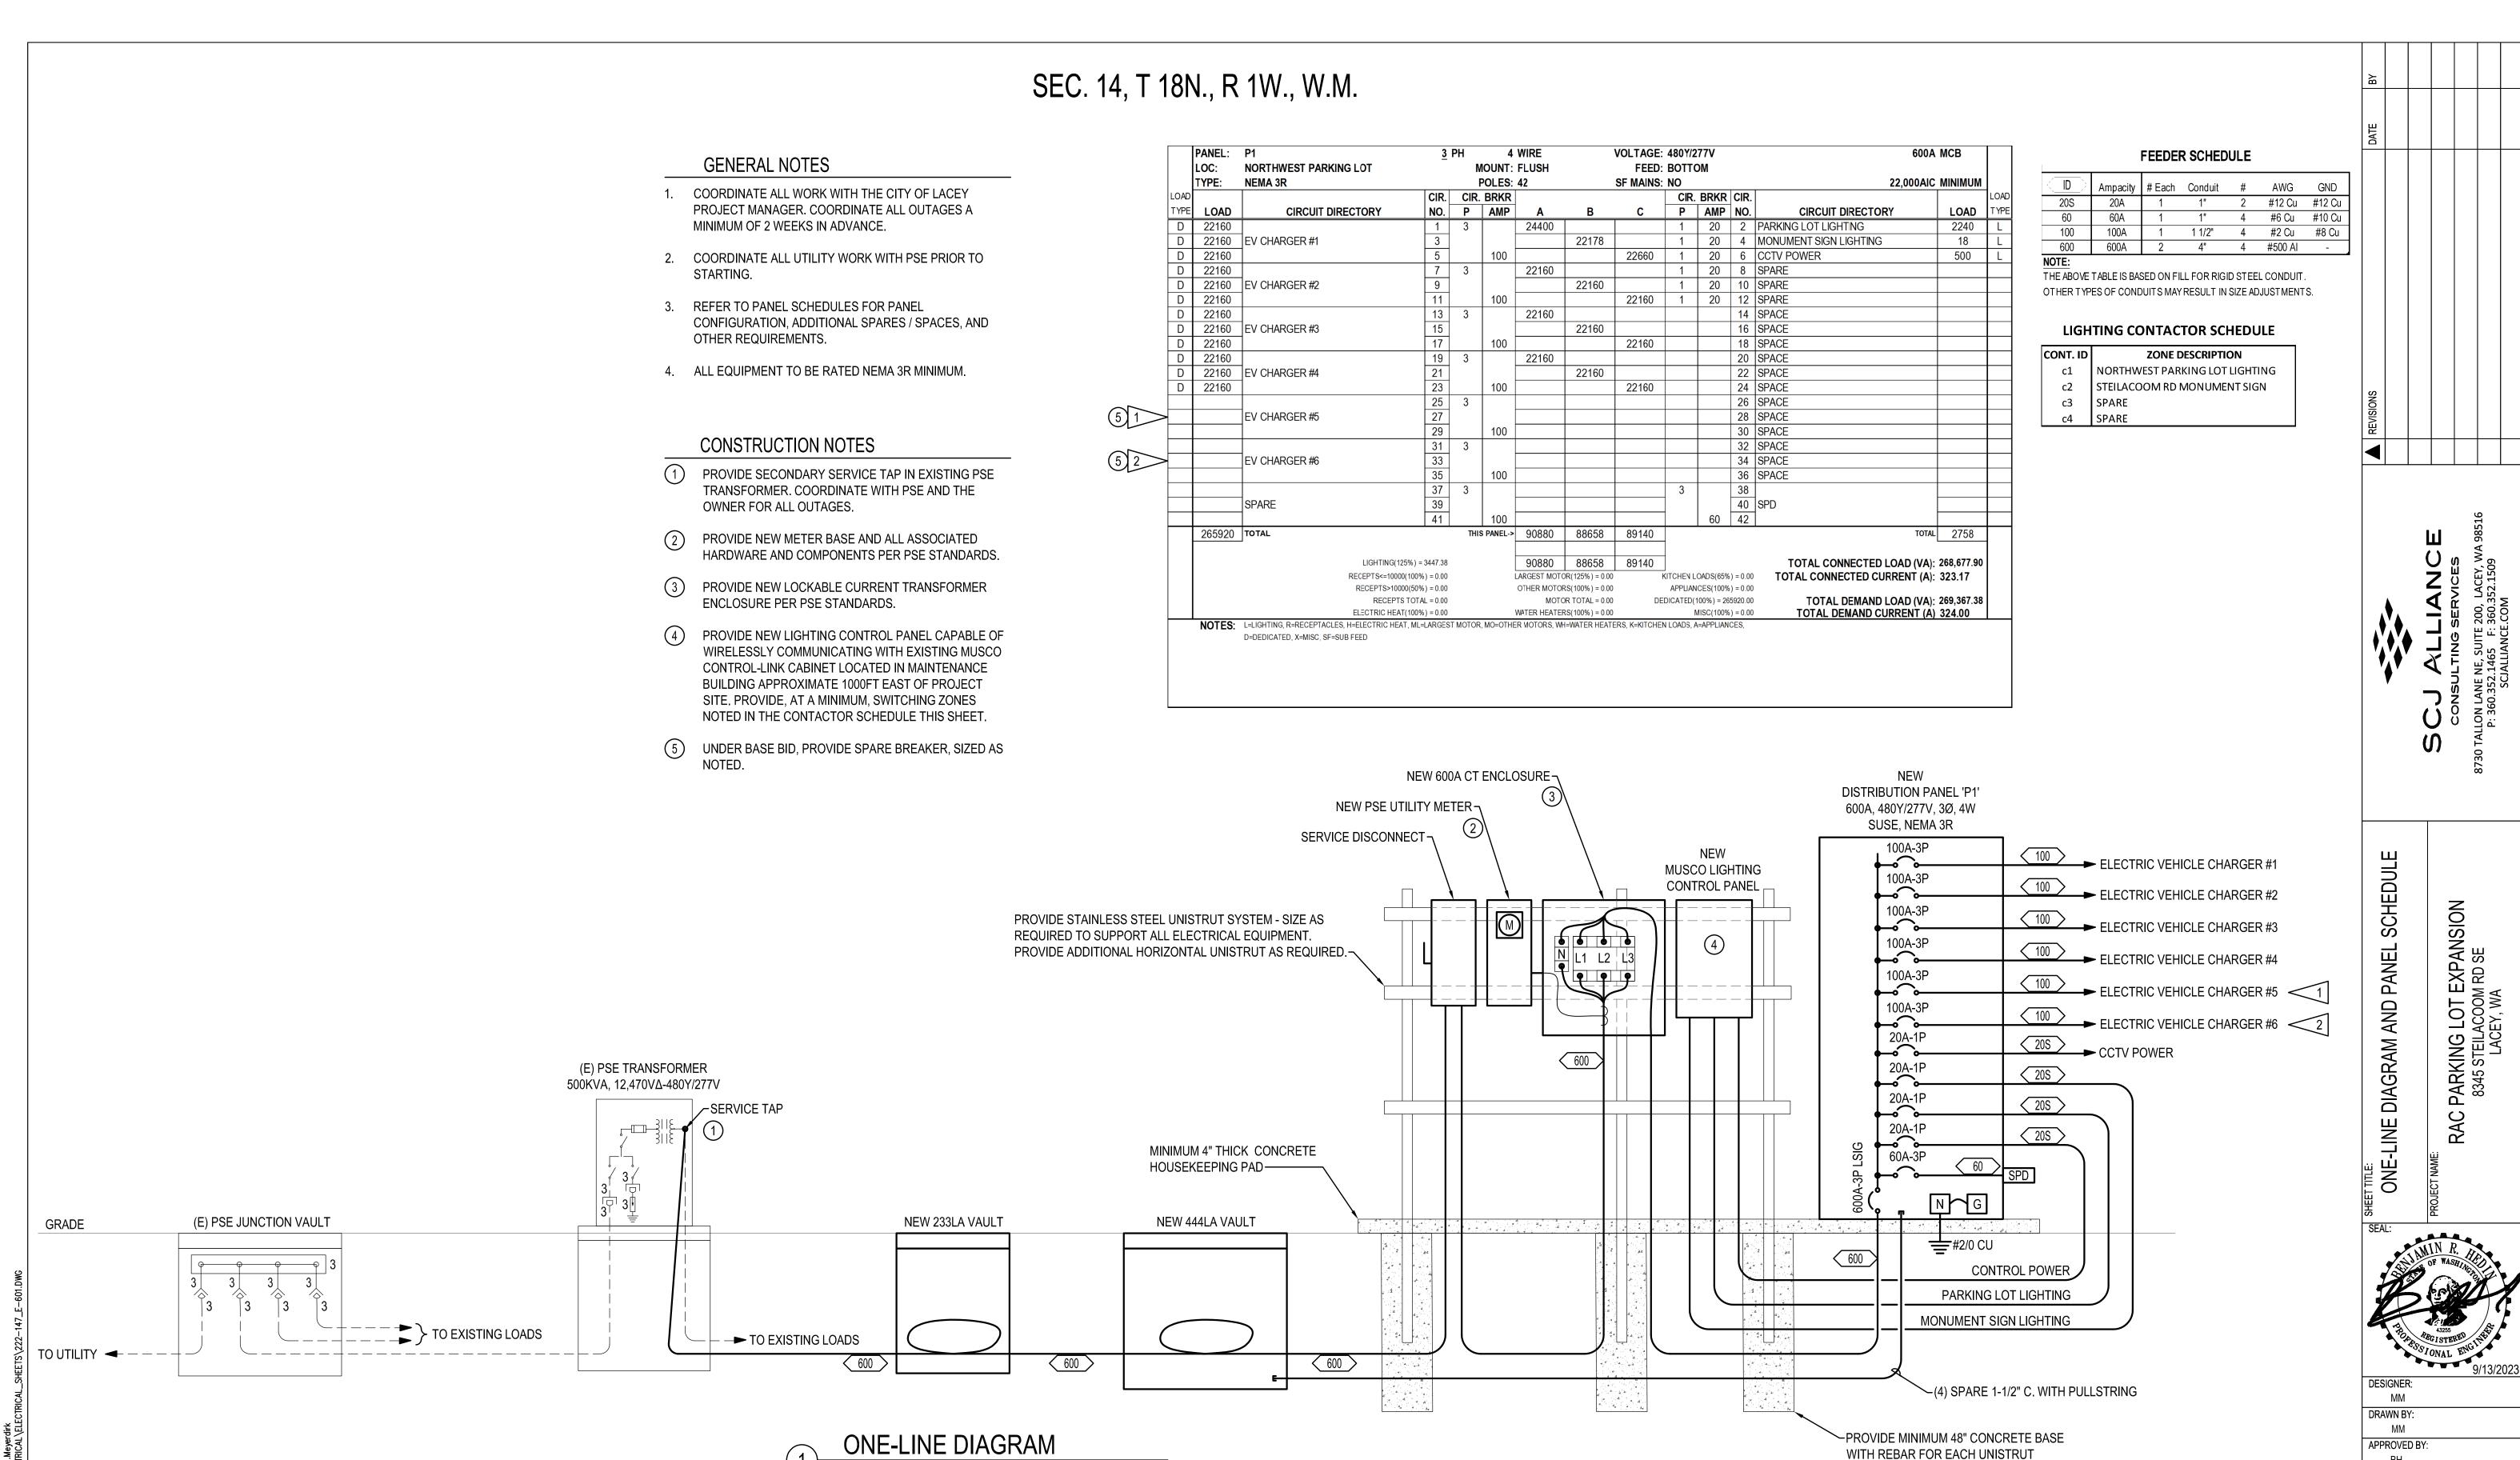
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SCALE: DIAGRAMMATIC

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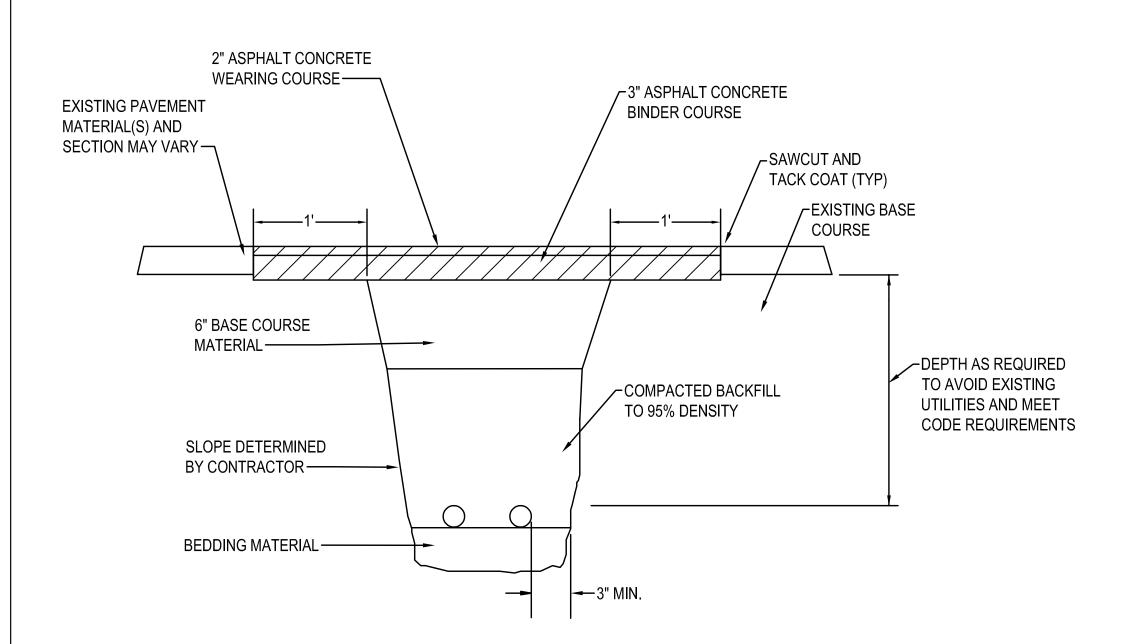
VERTICAL POST AS REQUIRED TO SUPPORT ALL MOUNTED ELECTRICAL EQUIPMENT

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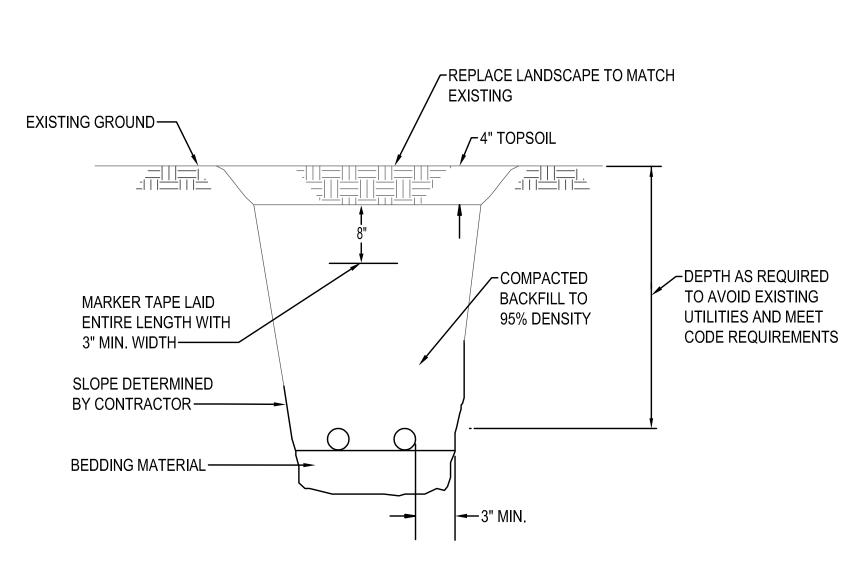
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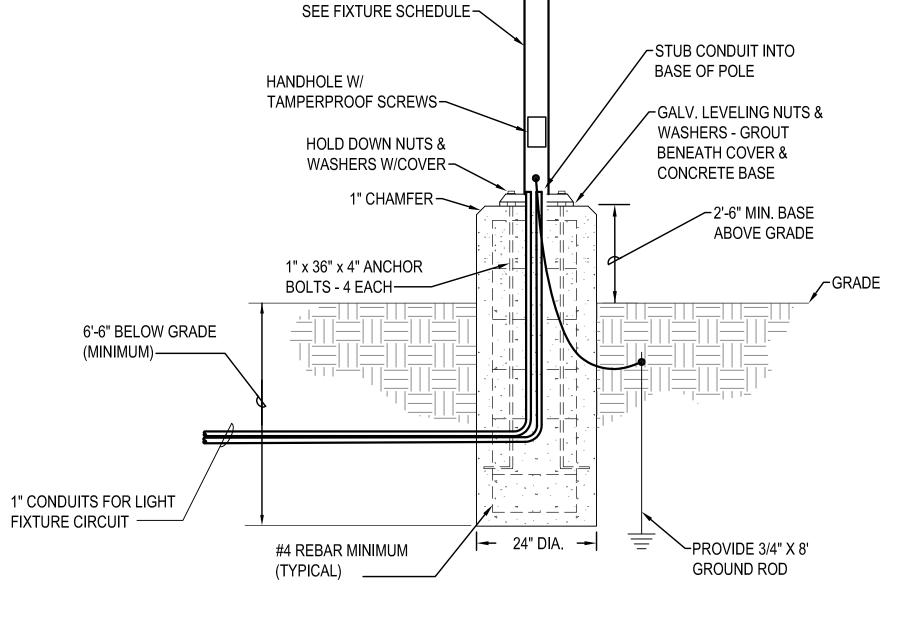
39 of 42

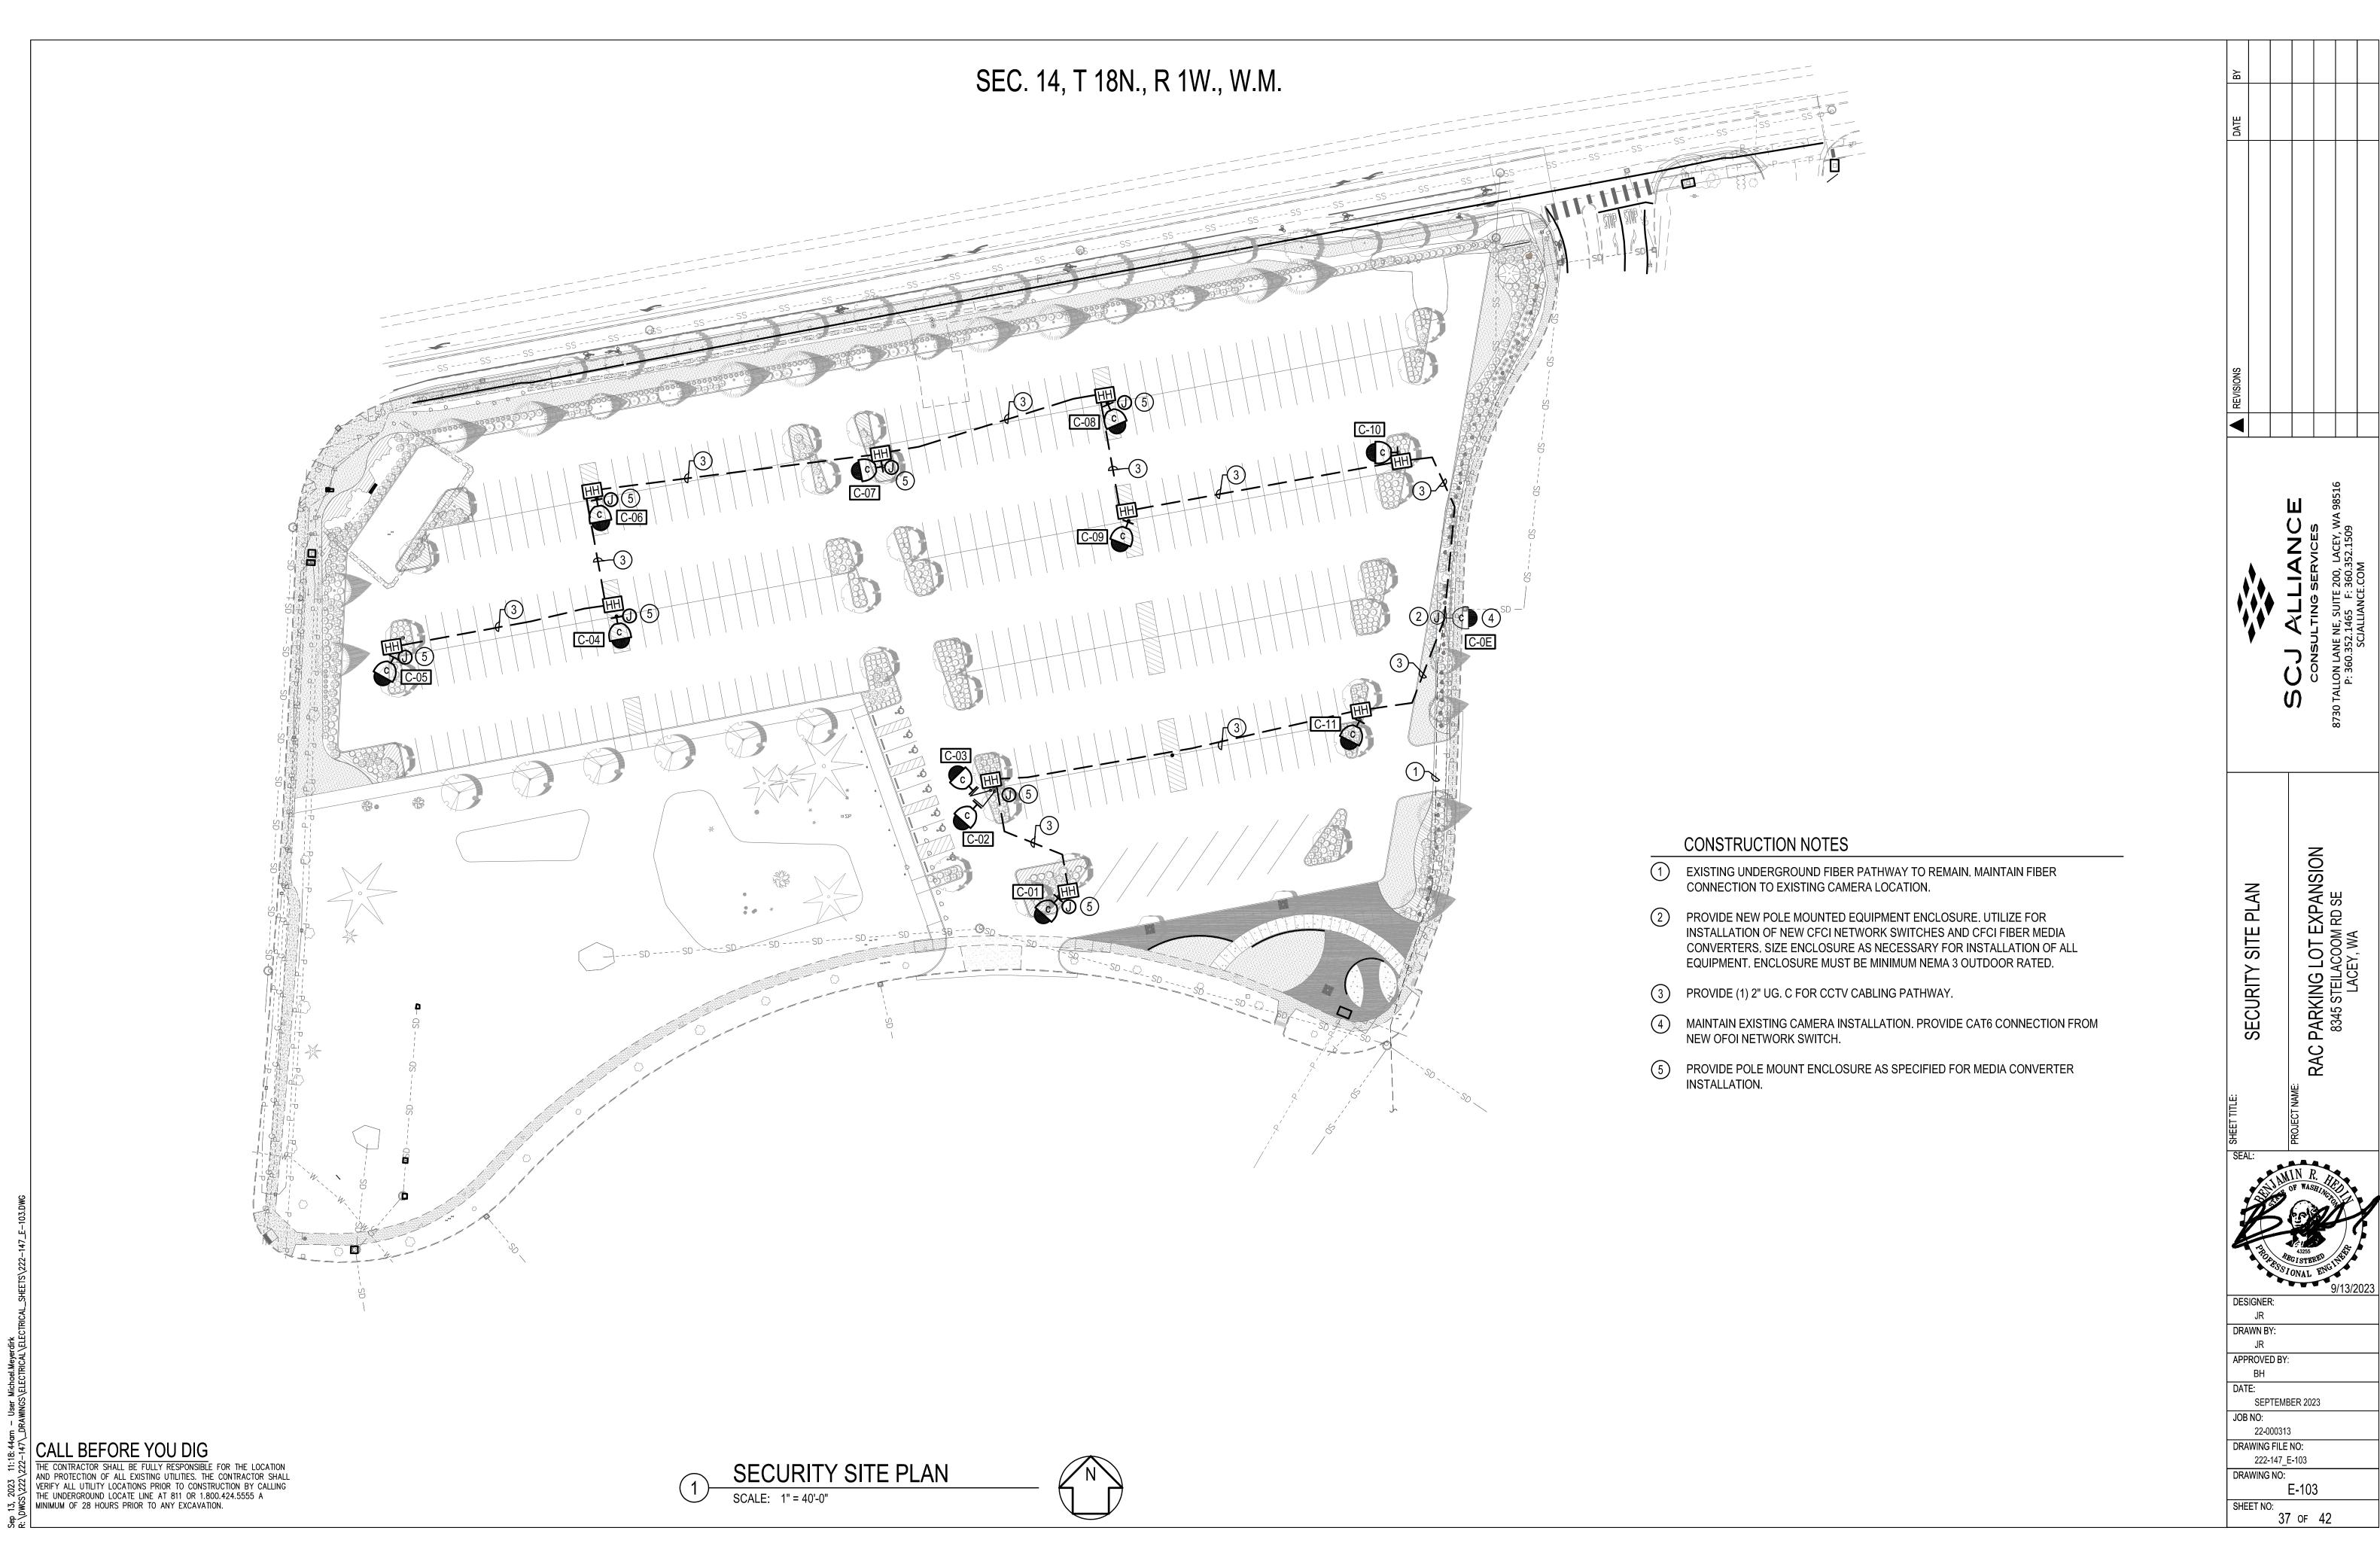

DIRECT BURY RACEWAY - ASPHALT AREAS SCALE: DIAGRAMMATIC

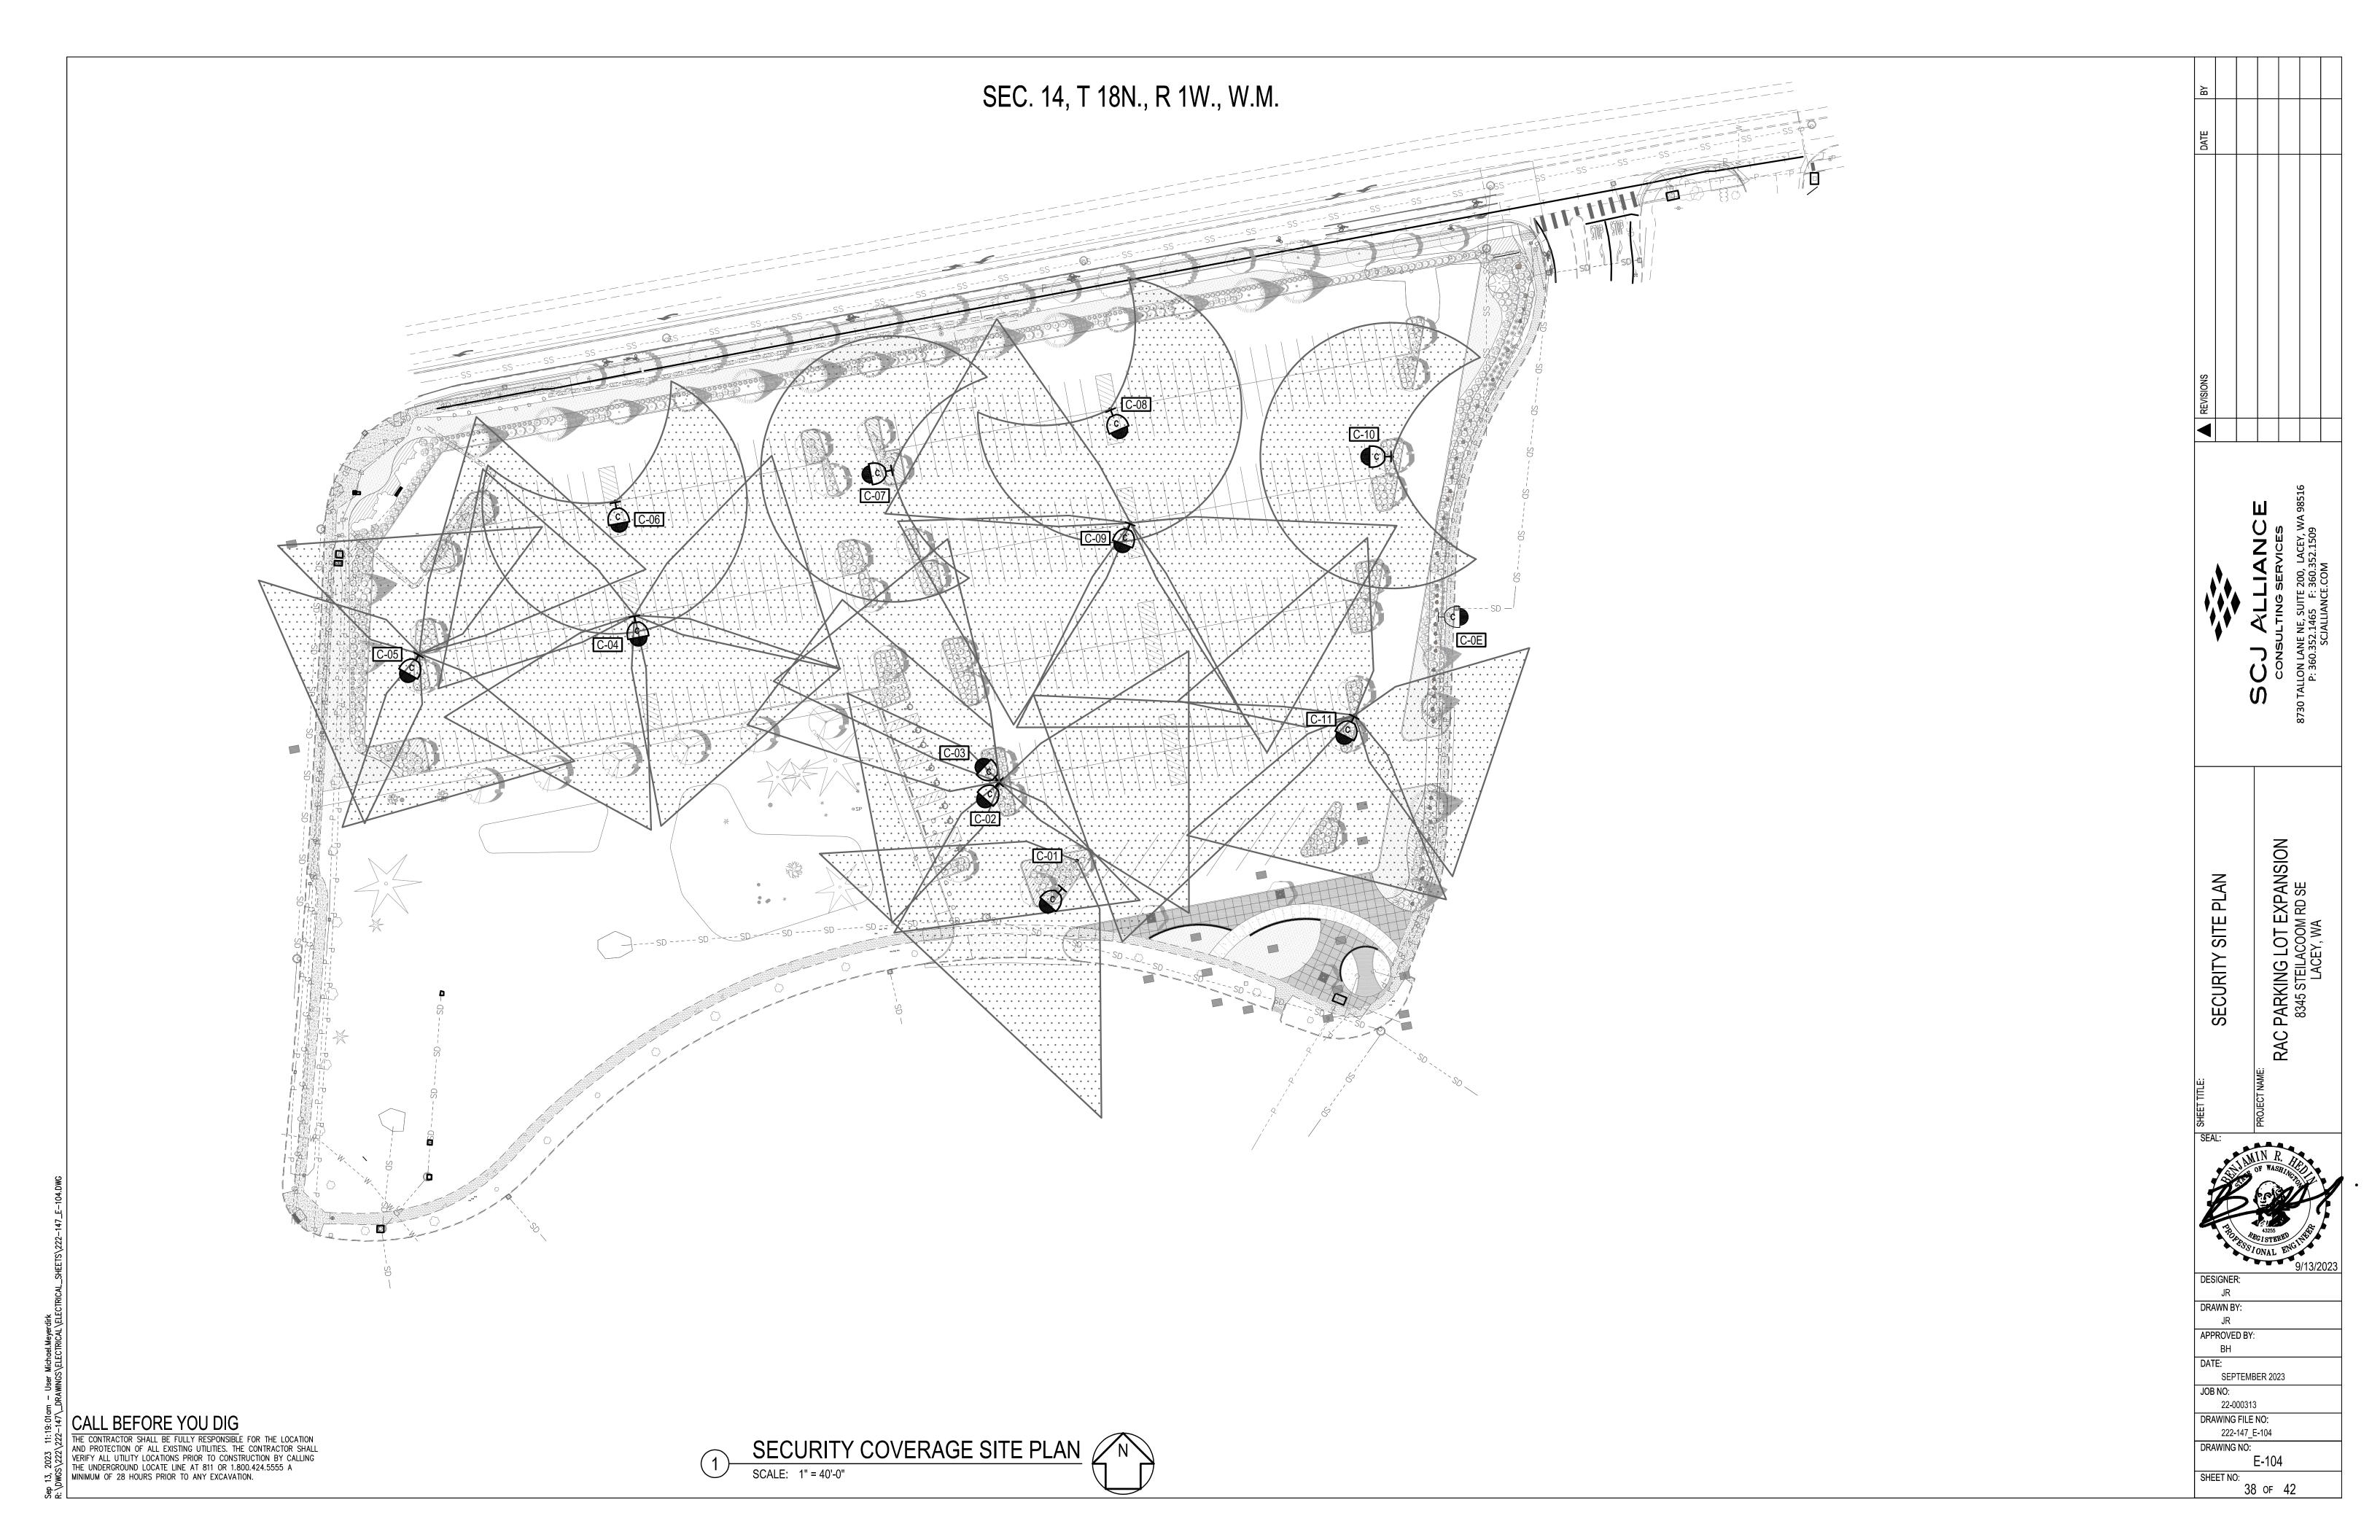

DIRECT BURY RACEWAY - LANDSCAPE AREAS SCALE: DIAGRAMMATIC



6" ROUND LIGHT POLE -

PARKING LOT POLE BASE DETAIL SCALE: DIAGRAMMATIC

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DETAIL(

ELECTRICAL

DESIGNER:

MM

APPROVED BY: BH

JOB NO:

SEPTEMBER 2023

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40 of 42

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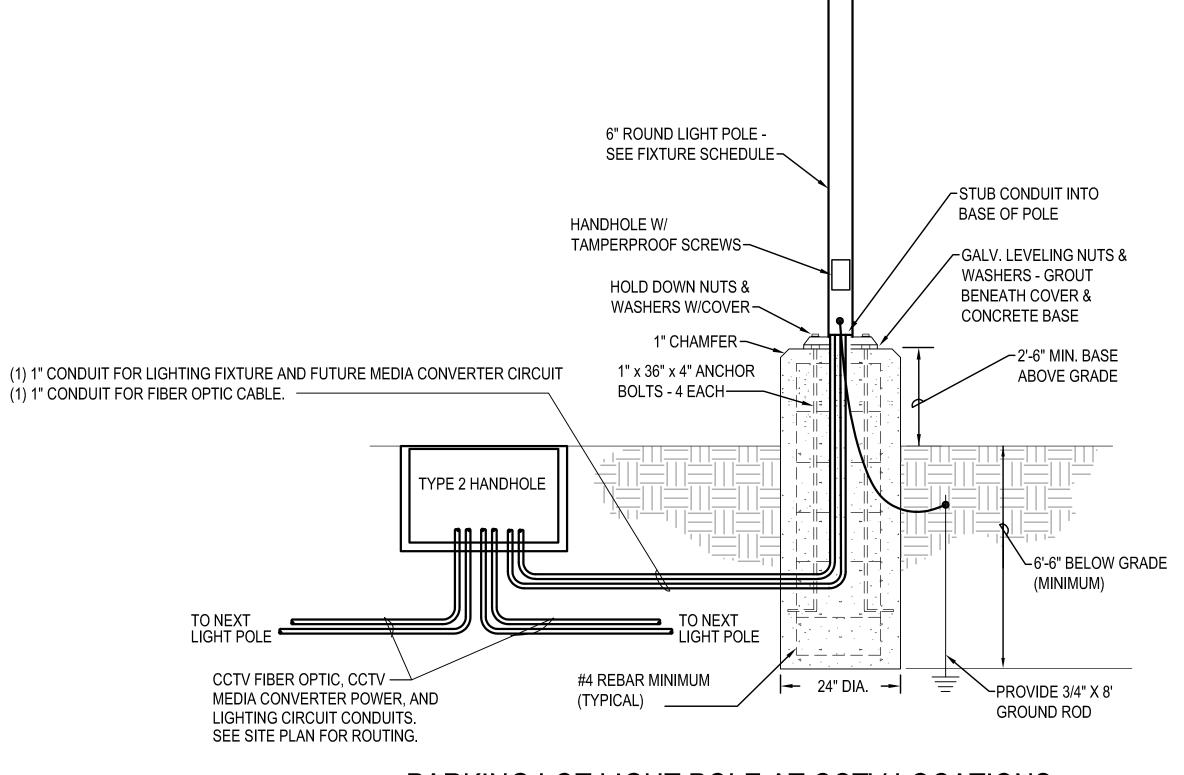
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RAC PARKING LOT E 8345 STEILACOOM LACEY, WA





PARKING LOT LIGHT POLE AT CCTV LOCATIONS SCALE: DIAGRAMMATIC


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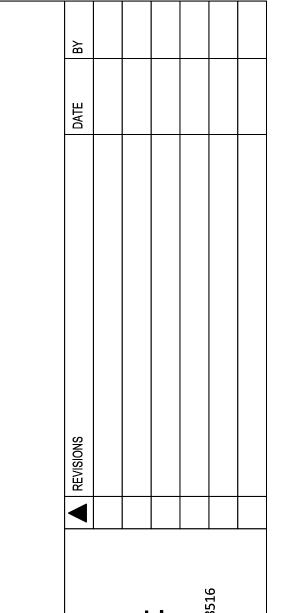
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SEC. 14, T 18N., R 1W., W.M.





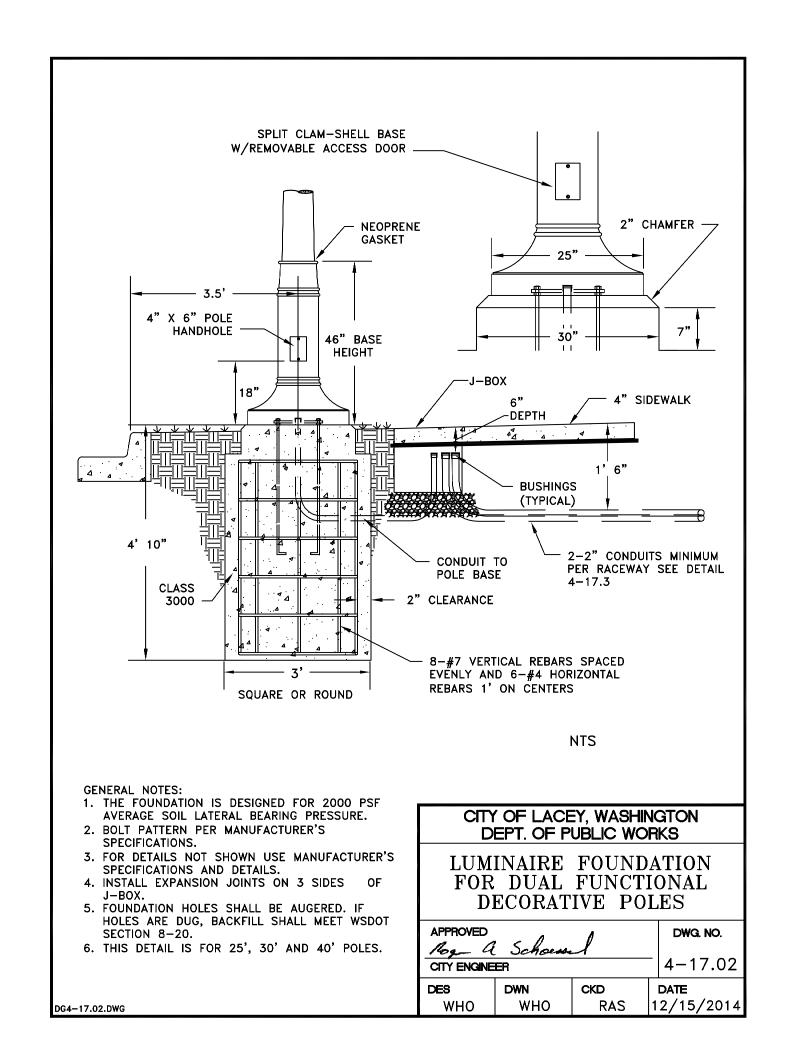

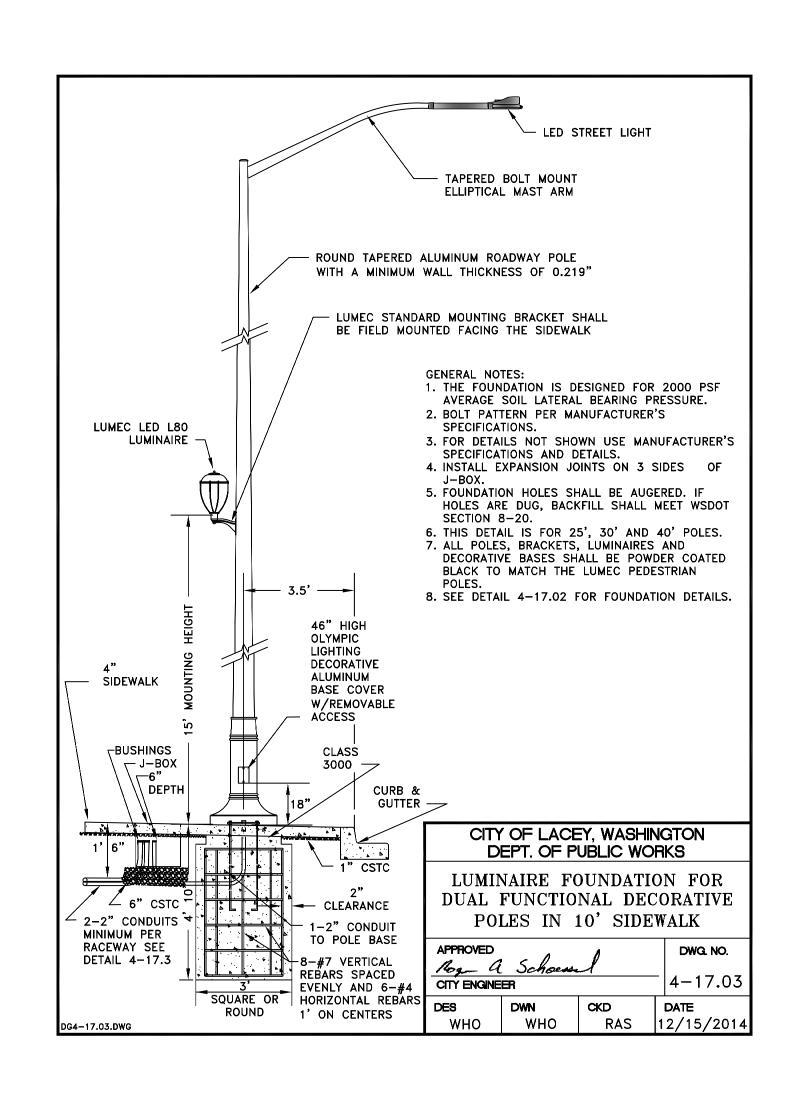

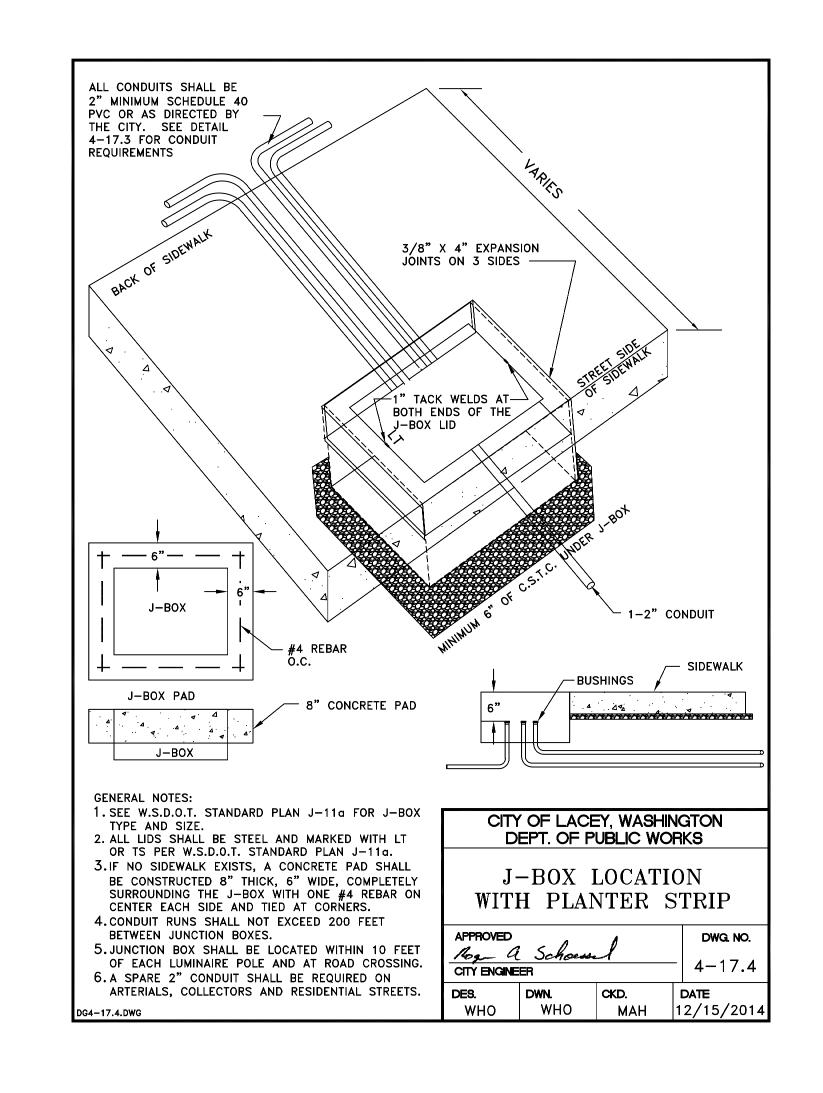SCJ ALLIANCI
CONSULTING SERVICES
8730 TALLON LANE NE, SUITE 200, LACEY, WA
P: 360.352.1465 F: 360.352.1509
SCJALLIANCE.COM

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STREET LIGHTING DETAILS

RAC PARKING LOT EXPANS
8345 STEILACOOM RD SE
LACEY, WA

SEAL:

NOW WASHINGTON ASSESSIONAL ENGINEERS OF WASHINGTON ASSESSIONAL ENGINEERS OF THE PROPERTY OF THE PROPERT

DESIGNER:

MM

DRAWN BY:

MM

APPROVED BY:

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DATE: SEPTEMBER 2023 JOB NO:

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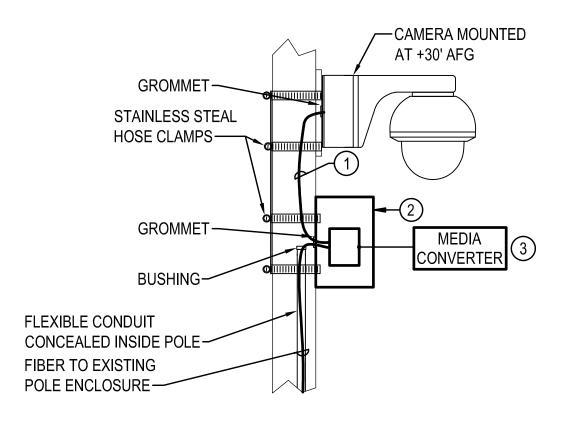
41 of 42


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SEC. 14, T 18N., R 1W., W.M.


DIAGRAMMATIC





POLE MOUNT CCTV CAMERA (FIBER CONNECTION)

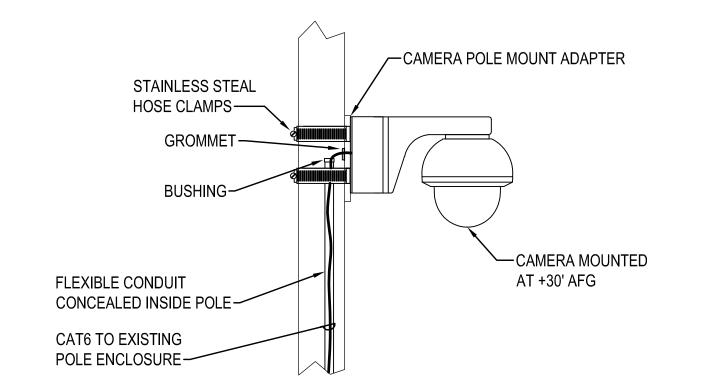POLE MOUNT CCTV CAMERA (CAT6 CONNECTION)

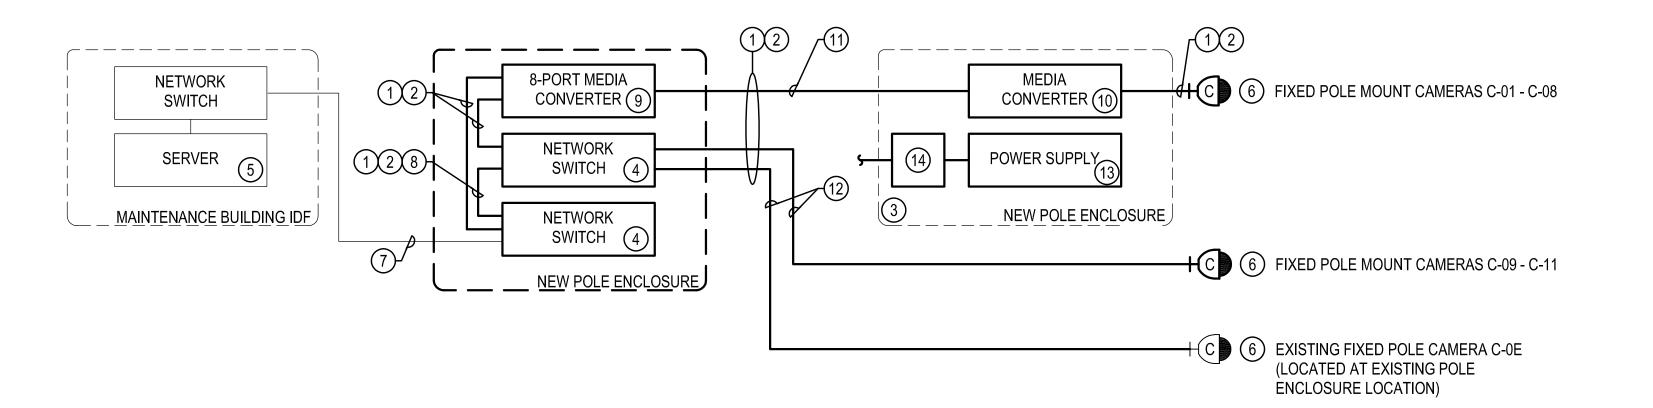

CCTV SYSTEM RISER DIAGRAM

DIAGRAMMATIC

DIAGRAMMATIC

CAMERA#	CAMERA TYPE	CAMERA MODEL	MOUNT TYPE	CONNECTION TYPE
C-01	SINGLE-SENSOR	AXIS Q3538-LVE	POLE	FIBER
C-02	360° MULTI-SENSOR	AXIS P3719-PLE	POLE	FIBER
C-03	SINGLE-SENSOR	AXIS Q3538-LVE	POLE	FIBER
C-04	360° MULTI-SENSOR	AXIS P3719-PLE	POLE	FIBER
C-05	360° MULTI-SENSOR	AXIS P3719-PLE	POLE	FIBER
C-06	180° MULTI-SENSOR	AXIS P3818-PVE	POLE	FIBER
C-07	180° MULTI-SENSOR	AXIS P3818-PVE	POLE	FIBER
C-08	180° MULTI-SENSOR	AXIS P3818-PVE	POLE	FIBER
C-09	360° MULTI-SENSOR	AXIS P3719-PLE	POLE	CAT6
C-10	180° MULTI-SENSOR	AXIS P3818-PVE	POLE	CAT6
C-11	360° MULTI-SENSOR	AXIS P3719-PLE	POLE	CAT6

CCTV SYSTEM CAMERA MATRIX

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POLE MOUNT CAMERA GENERAL NOTES

- 1. FOR CLARITY, CONDUITS ARE NOT SHOWN, EXCEPT WHERE NOTED. SEE FLOOR PLANS FOR CONDUIT REQUIREMENTS.
- 2. SECTION 27 20 00 SHALL PROVIDE THE TELECOMMUNICATIONS OUTLETS AND THE PATCH CABLES (SIZED TO FIT).

POLE MOUNT CAMERA CONSTRUCTION NOTES

- 1 CAT6 PATCH CABLE (SIZED AS REQUIRED FOR EACH LOCATION).
- PROVIDE POLE-MOUNTED WEATHERPROOF NETWORK ENCLOSURE SPECIFIED IN 281300 TO HOUSE MEDIA CONVERTER FOR ALL POLE LOCATIONS. POWER MEDIA CONVERTER FROM 277VAC TO 115VAC TRANSFORMER AT THE POLE. SEE SITE PLANS FOR ADDITIONAL INFORMATION.

REVISIONS

CCTV SYSTEM RISER DIAGRAM GENERAL NOTES

- 1. THIS RISER DIAGRAM IS DIAGRAMMATIC IN NATURE.
- 2. ALL EQUIPMENT SHOWN IS TYPICAL. SEE FLOOR PLANS AND SPECIFICATIONS FOR ADDITIONAL INFORMATION. PROVIDE QUANTITIES AS REQUIRED.
- 3. ALL EQUIPMENT, CCTV SYSTEM CABLING AND PROGRAMMING, SHALL BE THE RESPONSIBILITY OF ONE (1) INSTALLING VENDOR FOR A COMPLETE AND FULLY FUNCTIONAL SYSTEM. CLARIFICATION OF SCOPE OF WORK AND DEMARCATION POINT:
- 3.1. THE SECTION 27 20 00 DATA AND VOICE INFRASTRUCTURE INSTALLING VENDOR SHALL PROVIDE ALL CABLING AND EQUIPMENT AS IDENTIFIED IN CONSTRUCTION NOTE 2 (ON THIS SHEET).
- 3.2. PATCH PANEL(S) AND DATA OUTLET(S) SHALL BE DEEMED THE DEMARCATION POINT. THE SECTION 282300 CLOSED CIRCUIT TELEVISION SYSTEM (CCTV) INSTALLING VENDOR SHALL PROVIDE ALL OTHER CABLING AND EQUIPMENT.

CCTV SYSTEM RISER DIAGRAM CONSTRUCTION NOTES

- 1 CAT6 CABLES, FIBER CABLES, PATCH CORDS, CABLE LABELING SHALL BE INSTALLED, TERMINATED, AND TESTED BY SECTION 272000.
- (2) PROVIDE WET RATED CABLES, AS REQUIRED BY CODE AND THE AHJ.
- (3) PROVIDE POLE MOUNT ENCLOSURE FOR FIBER MEDIA CONVERTER INSTALLATION.
- 4 PROVIDE POE++ NETWORK SWITCH FOR CCTV DATA CONNECTIONS.
- UTILIZE EXISTING/OFOI CCTV SERVER FOR PROGRAMMING OF NEW CAMERAS INTO EXISTING CCTV VMS. CAMERA LICENSES FOR ALL NEW CAMERAS SHALL BE OFCI.
- 6 SEE THE CAMERA INSTALLATION DETAILS FOR ROUGH-IN AND TYPICAL INSTALLATION. REFER TO MANUFACTURES RECOMMENDATIONS FOR ADDITIONAL REQUIREMENTS.
- 7 UTILIZE EXISTING FIBER CABLING BETWEEN MAINTENANCE BUILDING AND EXISTING POLE ENCLOSURE FOR CONNECTION TO NEW OFOI POE NETWORK SWITCH.
- 8 PROVIDE 2-STRAND MULTI-MODE FIBER PATCH CORD FOR CONNECTION BETWEEN POE++ NETWORK SWITCHES. PROVIDE SPECIFIED SFP TRANSCEIVERS AS NECESSARY.
- 9 PROVIDE 8-PORT FIBER MEDIA CONVERTER IN THE EXISTING POLE ENCLOSURE FOR CCTV CAMERA LOCATIONS THAT EXCEED 295' RUN LENGTH OF NETWORK CABLING. PROVIDE SPECIFIED SFP TRANSCEIVERS AS NECESSARY.
- 10 PROVIDE SINGLE PORT FIBER MEDIA CONVERTER IN THE NEW POLE ENCLOSURES FOR CCTV CAMERA LOCATIONS THAT EXCEED 295' RUN LENGTH OF NETWORK CABLING. PROVIDE SPECIFIED SFP TRANSCEIVERS AS NECESSARY.
- 11) PROVIDE 2-STRAND MULTI-MODE FIBER FOR CONNECTION BETWEEN MEDIA CONVERTERS.
- 12) PROVIDE CAT6 FOR CONNECTION BETWEEN NETWORK SWITCH AND CCTV CAMERAS.
- (13) PROVIDE POWER SUPPLY AS SPECIFIED FOR MEDIA CONVERTERS.
- DEDICATED NON-SWITCHED 277V POWER TO BE PROVIDED AT EACH CCTV CAMERA DESIGNATED FOR FIBER MEDIA CONVERTER CONNECTIVITY. THE ELECTRICAL CONTRACTOR MUST PROVIDE A 277V TO 115VDC TRANSFORMER AT THE POLE MOUNT ENCLOSURE FOR CONNECTION TO THE FIBER MEDIA CONVERTER.
- PROVIDE POLE MOUNT ENCLOSURE AT EXISTING POLE FOR NETWORK SWITCHES AND FIBER MEDIA CONVERTER INSTALLATION.



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SECURITY DETAILS

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DESIGNER:
JR
DRAWN BY:
JR
APPROVED BY:
BH

DATE:
SEPTEMBER 2023

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42 OF 42

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