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SCHEDULE OF DRAWINGS

| SHT. NO. | DWG. NO. | DESCRIPTION |
|----------|-----------|------------------------------------|
| 1 | CVR1 | COVER SHEET |
| 2-3 | AL1-AL2 | SURVEY CONTROL AND ALIGNMENT PLAN |
| 4-5 | RS1-RS2 | TYPICAL ROADWAY SECTIONS |
| 6-11 | SP1-SP6 | DEMOLITION AND TESC PLAN |
| 12-17 | PV1-PV6 | PAVING PLAN |
| 18-20 | G1-G3 | ROUNDAABOUT GRADING PLAN |
| 21-23 | PVD1-PVD3 | ROADWAY DETAILS |
| 24-26 | DR1-DR3 | DRAINAGE PLAN |
| 27-29 | DD1-DD3 | DRAINAGE DETAILS |
| 30-32 | IL1-IL3 | ILLUMINATION PLAN |
| 33 | ILD1 | ILLUMINATION DETAILS |
| 34-37 | UT1-UT4 | UTILITY PLAN |
| 38 | UP1 | UTILITY PROFILE |
| 39-42 | UD1-UD4 | UTILITY DETAILS |
| 43-48 | CH1-CH6 | CHANNELIZATION PLAN |
| 49-50 | CHD1-CHD2 | CHANNELIZATION DETAILS |
| 51-54 | SN1-SN4 | SIGNING PLAN |
| 55 | SND1 | SIGNING DETAILS |
| 56-58 | LS1-LS3 | LANDSCAPE PLAN |
| 59 | LS4 | PLANT SCHEDULE |
| 60 | LS5 | LANDSCAPE DETAILS |
| 61-64 | IR1-IR4 | IRRIGATION PLAN, NOTES, AND LEGEND |

SEC. 10, T.18N., R.1W., W.M.

CARPENTER ROAD/BRITTON PARKWAY
ROUNDAABOUT

LACEY CONTRACT NUMBER PW 2020-29
DRAWING NUMBER D-22-63

MAYOR

ANDY RYDER

DEPUTY MAYOR

MALCOLM MILLER

CITY COUNCIL

LENNY GREENSTEIN

MICHAEL STEADMAN

CAROLYN COX

ED KUNKEL

ROBIN VAZQUEZ


CITY ENGINEER

AUBREY COLLIER, PE


PUBLIC WORKS DIRECTOR

SCOTT EGGER, PE


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CARPENTER ROAD/BRITTON PARKWAY
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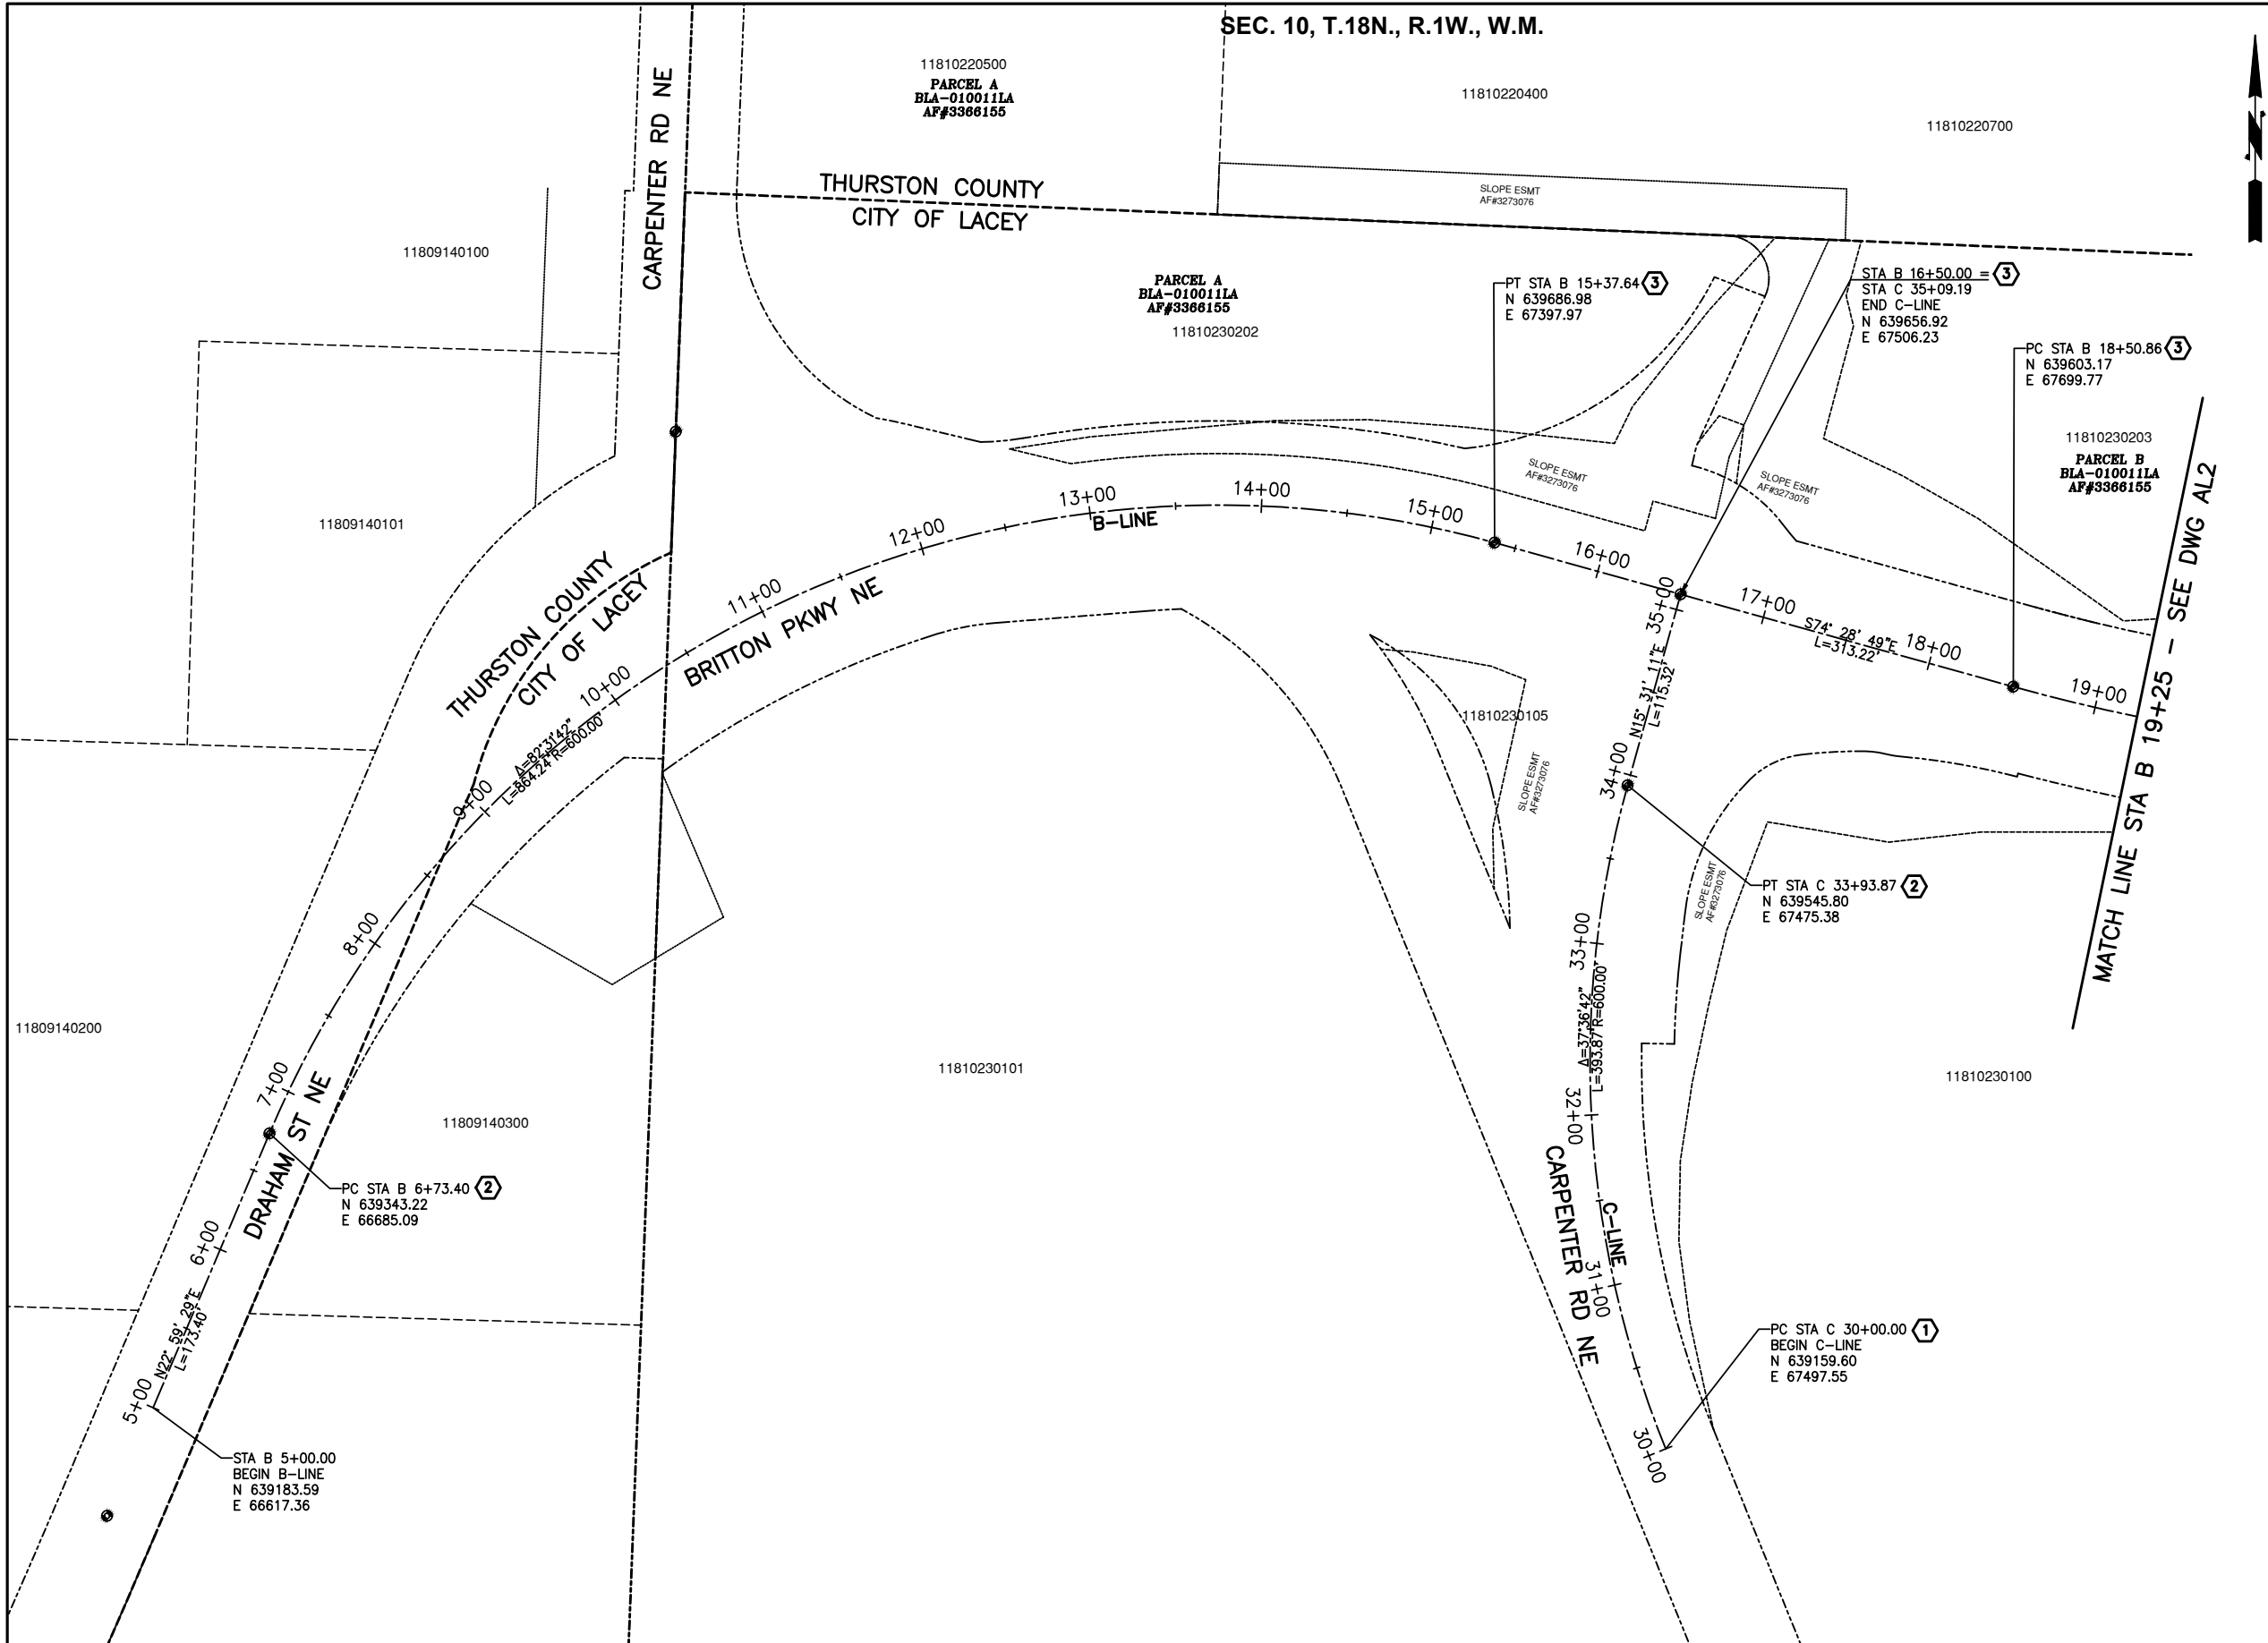
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GENERAL NOTES:

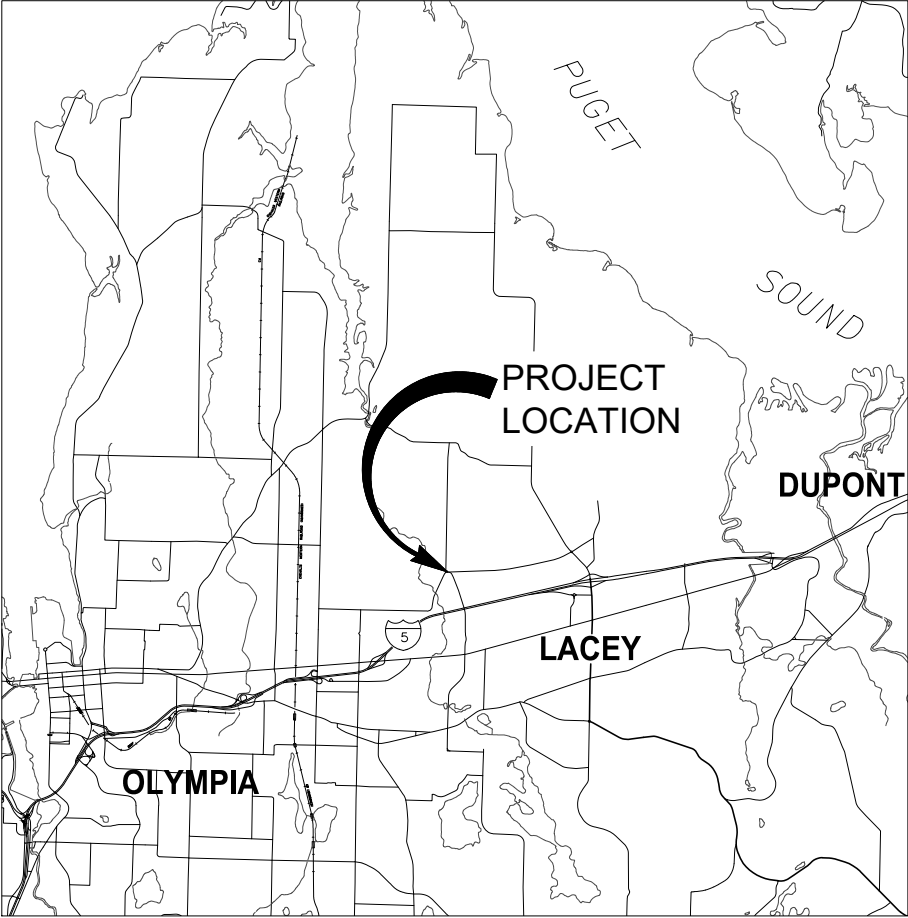1. SURVEY PROVIDED BY THE CITY OF LACEY.
2. SURVEY PERFORMED BY CONVENTIONAL FIELD TRAVERSE USING A LEICA TS-16 (THREE SECOND TOTAL STATION), LINEAR AND ANGULAR CLOSURE OF THE TRAVERSE MEET THE STANDARDS OF WAC 332-130-090.
3. THE TOPOGRAPHIC SURVEY DEPICTS THE PHYSICAL FEATURES THAT WERE VISIBLE AT THE TIME OF THE SURVEY. LOCHNER AND THE CITY OF LACEY ARE NOT RESPONSIBLE FOR THE LOCATION OF UNDERGROUND UTILITIES THAT ARE MARKED OR NOT MARKED IN THE FIELD BY OTHER UTILITY PROVIDERS. FEATURE LOCATIONS SHOULD BE INDEPENDENTLY VERIFIED PRIOR TO CONSTRUCTION.

DATUMS:

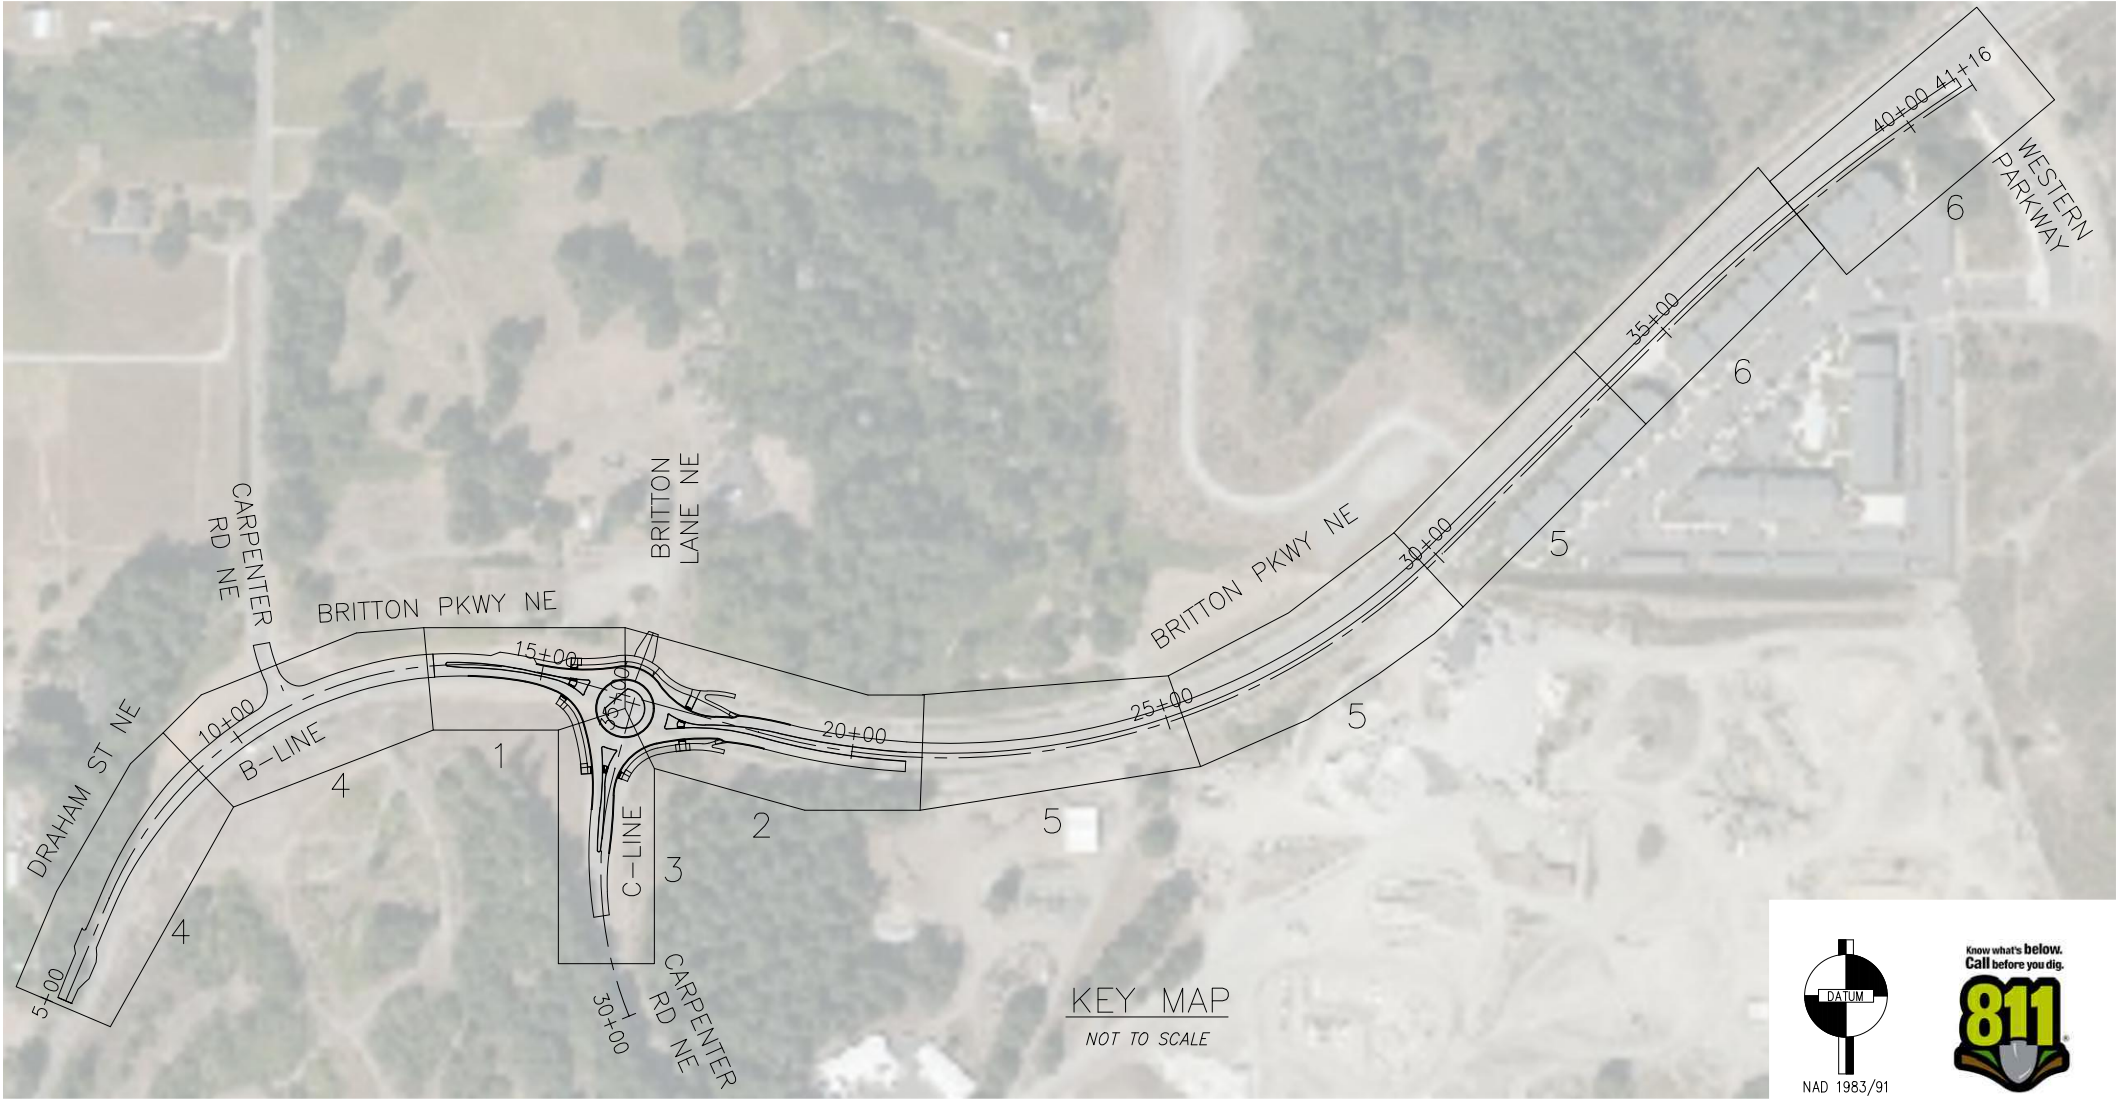HORIZONTAL DATUM: MERIDIAN IS WASHINGTON COORDINATE SYSTEM OF 1983/91 - SOUTH ZONE DERIVED FROM TIES TO HPGN STATIONS SANDERSON, MCKENNA AND CBL1110 AND TO WSDOT GPS STATIONS G259R, GP34005-2, GP34005-4, GP34101-32, GP34101-39, HC34-2, LUHR RM2, TS34-33, TS34-59 AND TO THURSTON COUNTY GPS STATIONS U-531, AT-194, AT-352, AT-355, AT-447, AT-449 AND AT-478. DISTANCES SHOWN ARE GROUND SCALE U.S. SURVEY FEET. COMBINED SCALE FACTOR (GROUND TO GRID) IS 0.999935701. SURVEY AF# 3111152 DATED 09-24-1997.

VERTICAL DATUM: THE CITY OF LACEY BENCHMARKS ARE BASED ON NGVD 29 DATUM FROM PRIMARY CONTROL ESTABLISHED BY FEDERAL AND STATE AGENCIES TO FIRST OR SECOND ORDER ACCURACY. THE CITY OF LACEY'S BENCHMARKS ARE GENERALLY TO THIRD ORDER ACCURACY

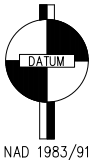BENCHMARK: CITY OF LACEY BM#1088 CITY OF LACEY 2" SURFACE MONUMENT 150' NORTH OF THE INTERSECTION OF CARPENTER RD NE AND DRAHAM RD NE ELEV.=145.19

LEGEND:

- CONSTRUCTION CENTERLINE
- RIGHT OF WAY
- EASEMENT
- LOT LINE
- SECTION LINE
- CITY/COUNTY BORDER

CONSTRUCTION NOTES:

- 1 DO NOT DISTURB EXISTING MONUMENT
- 2 ALUMINUM PIPE MONUMENT & CASE INSTALLATION
- 3 MONUMENT IN MEDIAN

BOUNDARY:

THE BOUNDARY WAS COMPILED USING PHYSICAL FEATURES TIED IN THE FIELD AND DOCUMENTS OF RECORD AS SHOWN BELOW.

AF# 3111152

BLA REFERENCED
AF#3366155



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CARPENTER ROAD/BRITTON PARKWAY
ROUNDBOUT


SURVEY CONTROL AND ALIGNMENT PLAN

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AL1

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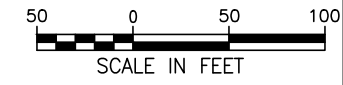
- LEGEND:**
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 - RIGHT OF WAY
 - EASEMENT
 - LOT LINE
 - SECTION LINE
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SURVEYS REFERENCED
AF# 3111152

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AF#3366155

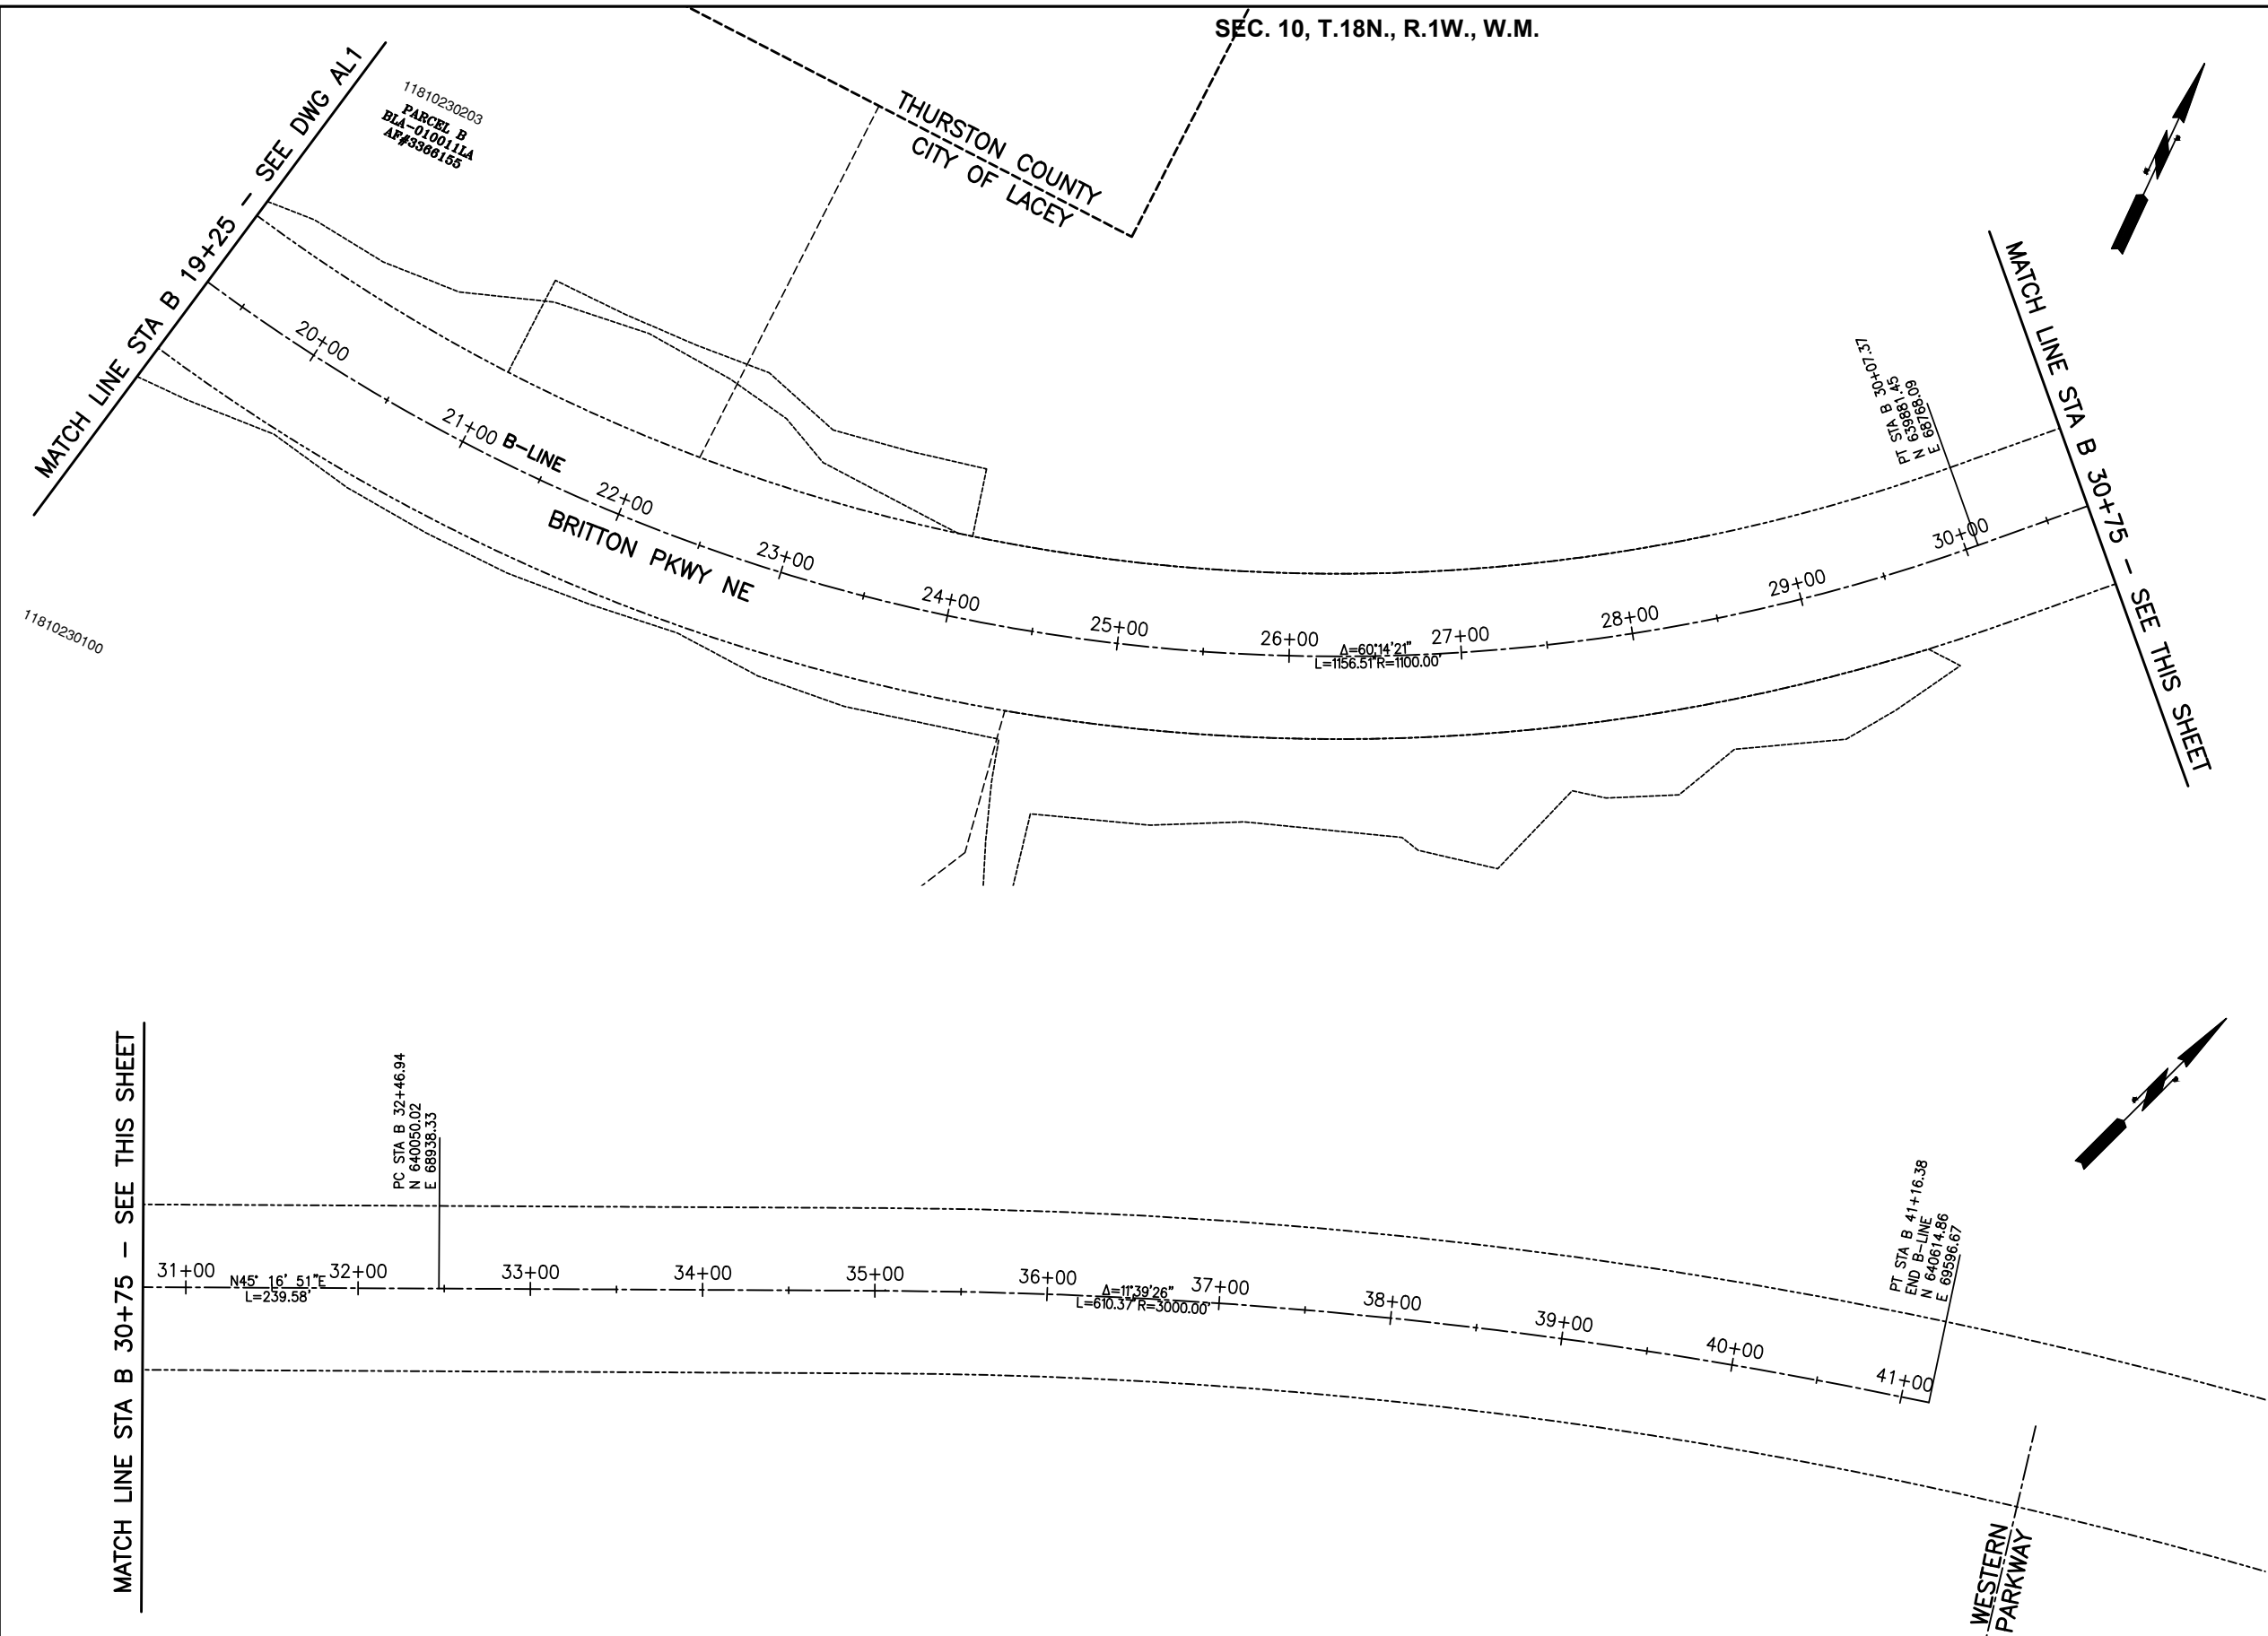

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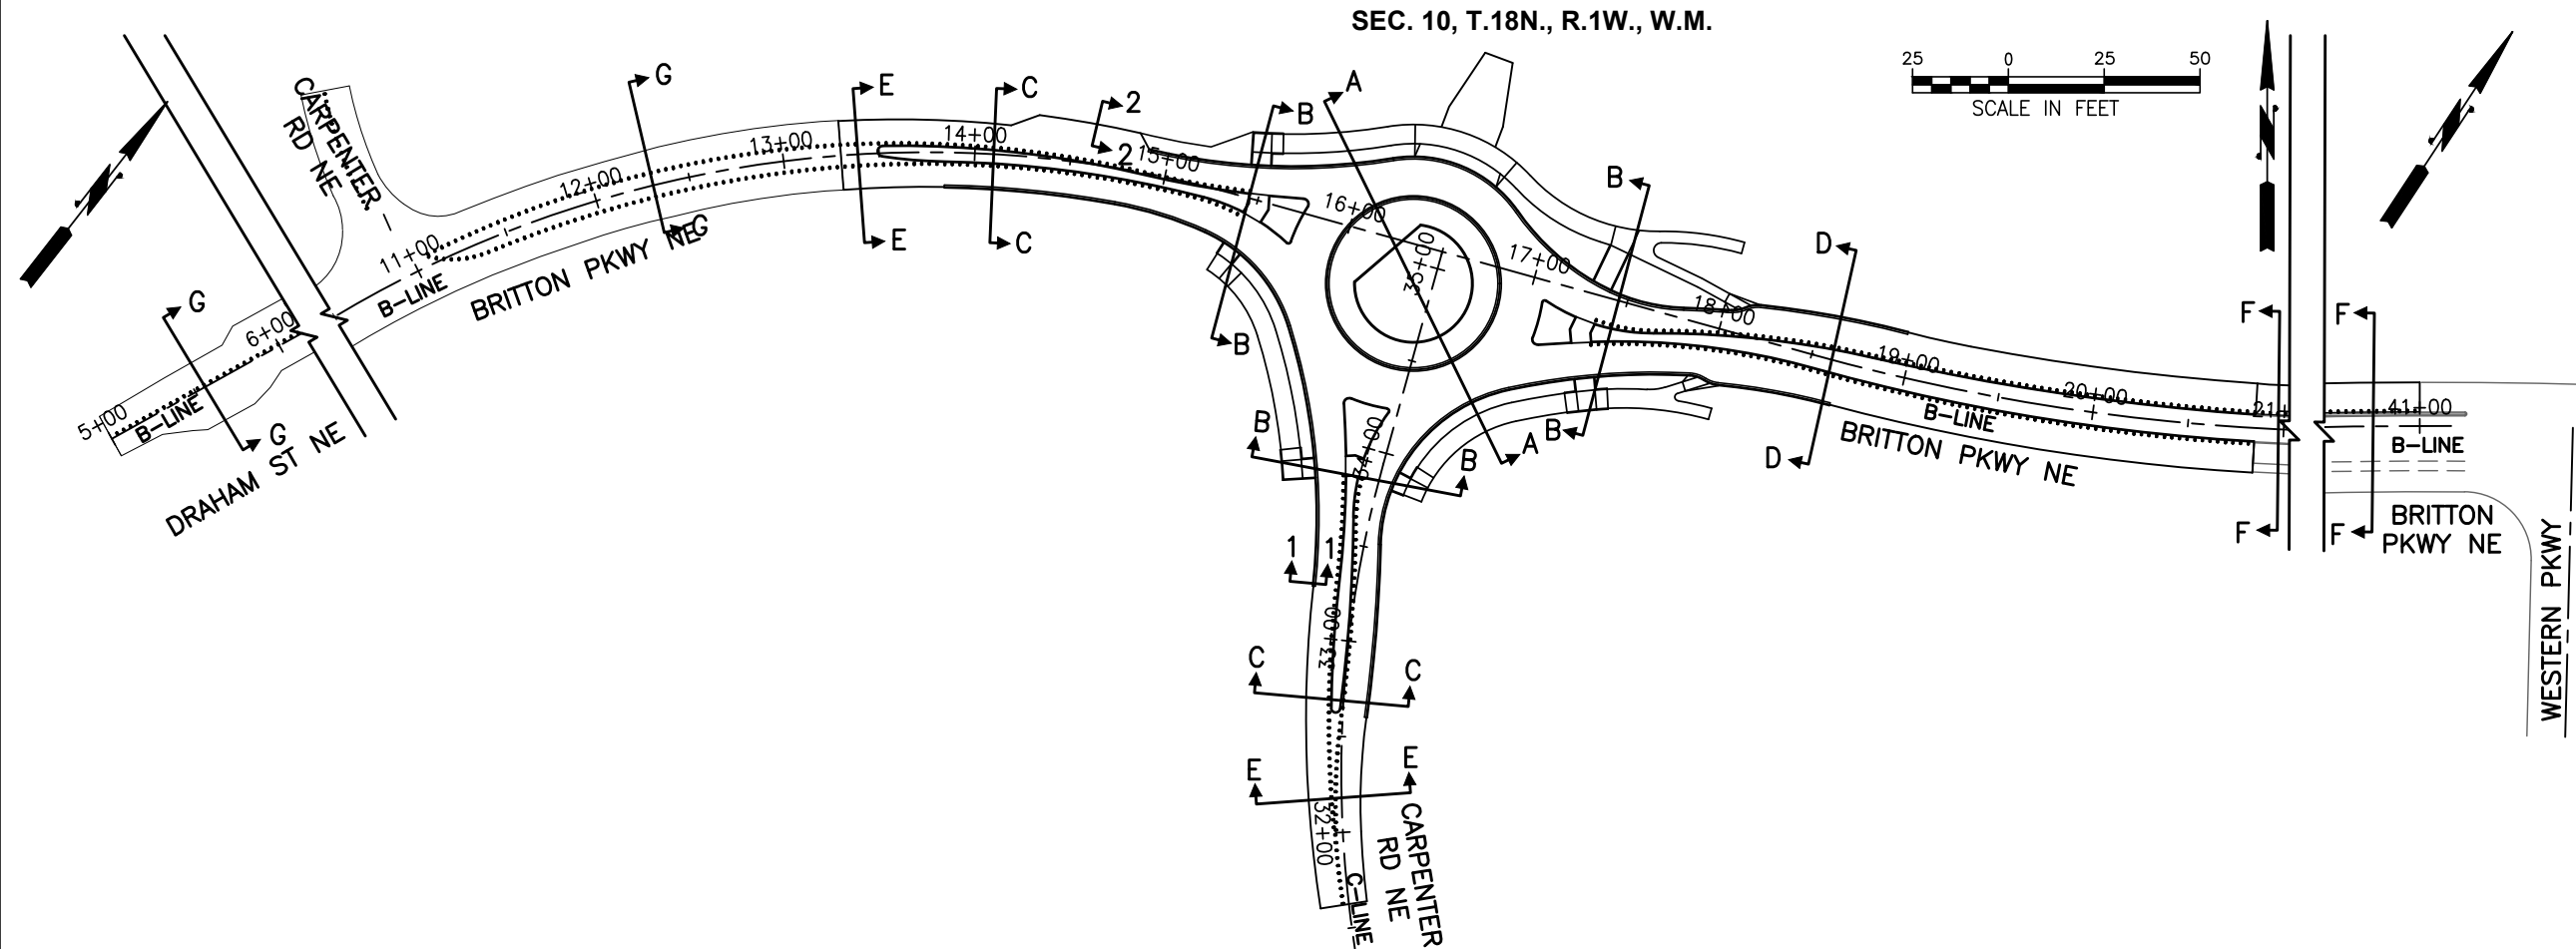


**CARPENTER ROAD/BRITTON PARKWAY
ROUNDBOUT**

SURVEY CONTROL AND ALIGNMENT PLAN

DRAWING NUMBER
AL2
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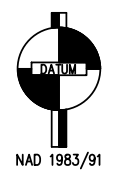
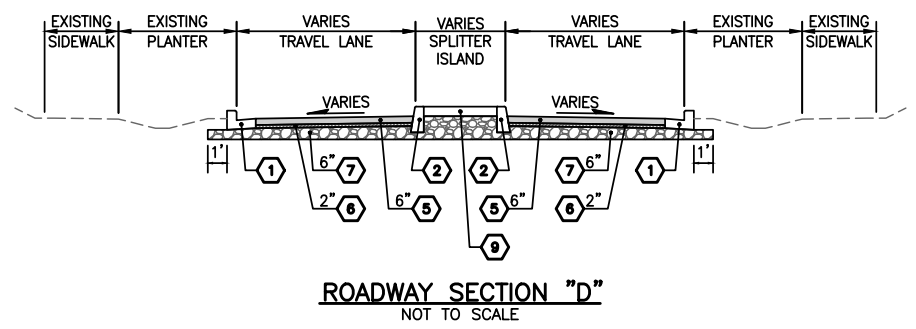
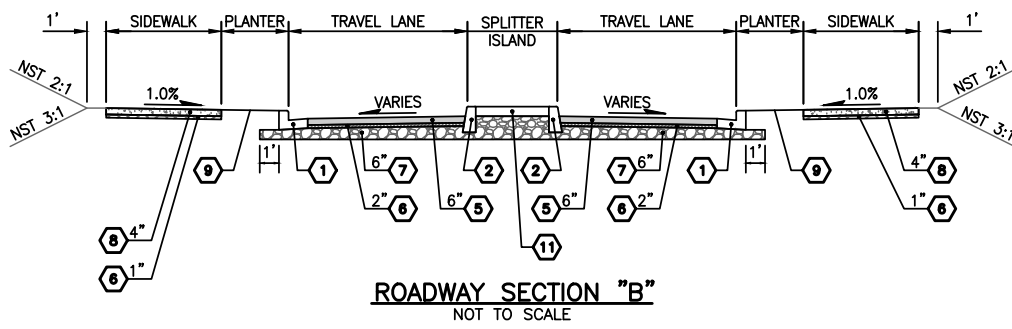
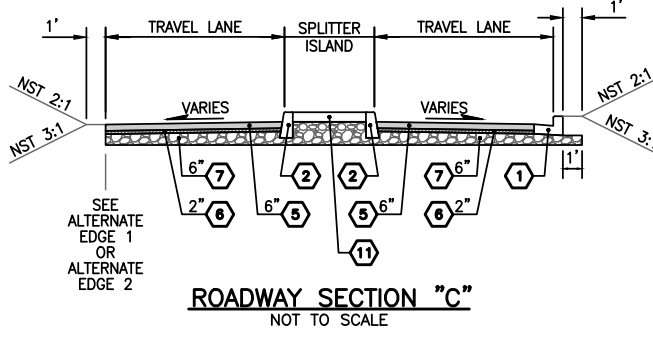
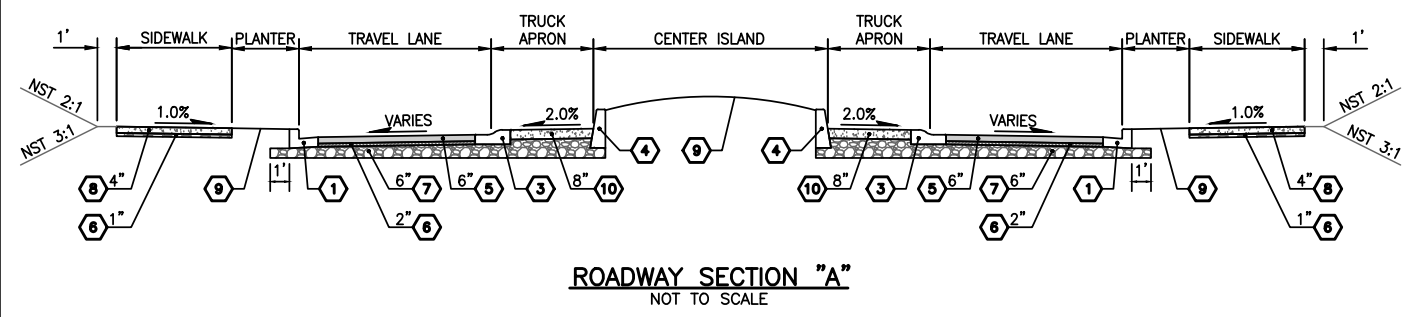
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- GENERAL NOTES:**
1. SIDEWALKS SHALL BE SLOPED TOWARDS ROADWAY. CROSS SLOPES SHALL NOT EXCEED 1.0% UNLESS OTHERWISE NOTED.
 2. CATCH SLOPES REQUIRING MOWING SHALL NOT EXCEED 6H:1V.
 3. ALL SURFACE AND PAVING DEPTHS ARE COMPACTED DEPTHS.

- CONSTRUCTION NOTES:**
- ① CEMENT CONCRETE TRAFFIC CURB & GUTTER
 - ② CEMENT CONCRETE TRAFFIC CURB
 - ③ ROUNDABOUT TRUCK APRON CEMENT CONCRETE CURB AND GUTTER
 - ④ MODIFIED CEMENT CONCRETE TRAFFIC CURB
 - ⑤ FIBER REINFORCED HMA CL. 3/8 IN, PG 58V-22
 - ⑥ CRUSHED SURFACING TOP COURSE
 - ⑦ CRUSHED SURFACING BASE COURSE
 - ⑧ CEMENT CONCRETE SIDEWALK
 - ⑨ LAWN AND LANDSCAPE RESTORATION
 - ⑩ CONCRETE PATTERN B - TRUCK APRON
 - ⑪ CONCRETE PATTERN C - ISLANDS/MEDIANS
 - ⑫ GRAVEL BORROW INCL. HAUL
 - ⑬ NOT USED
 - ⑭ GRIND AND FIBER REINFORCED HMA CL. 3/8 IN, PG 58V-22 OVERLAY

NST = NO STEEPER THAN



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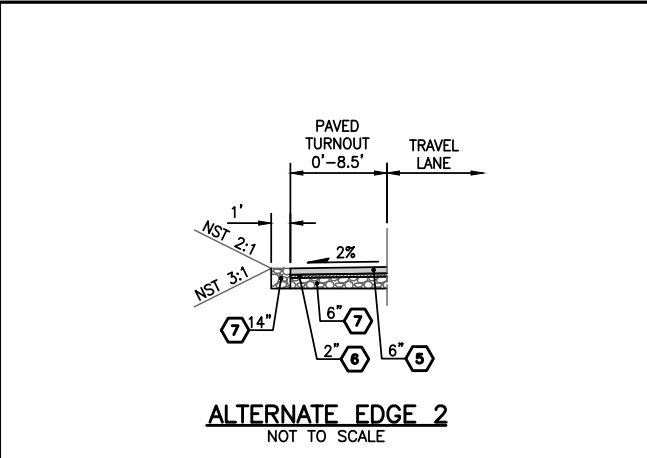
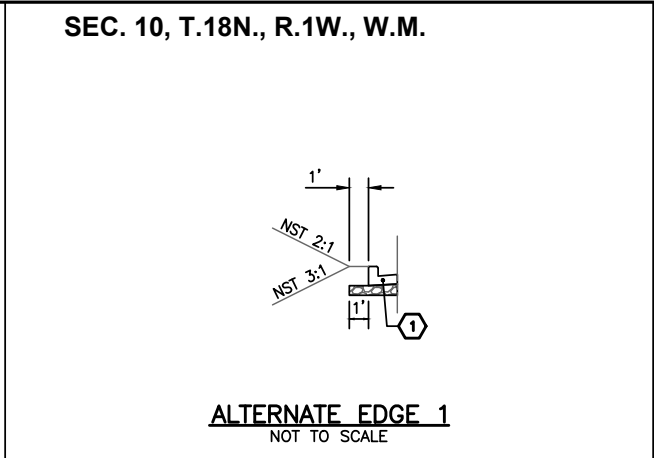
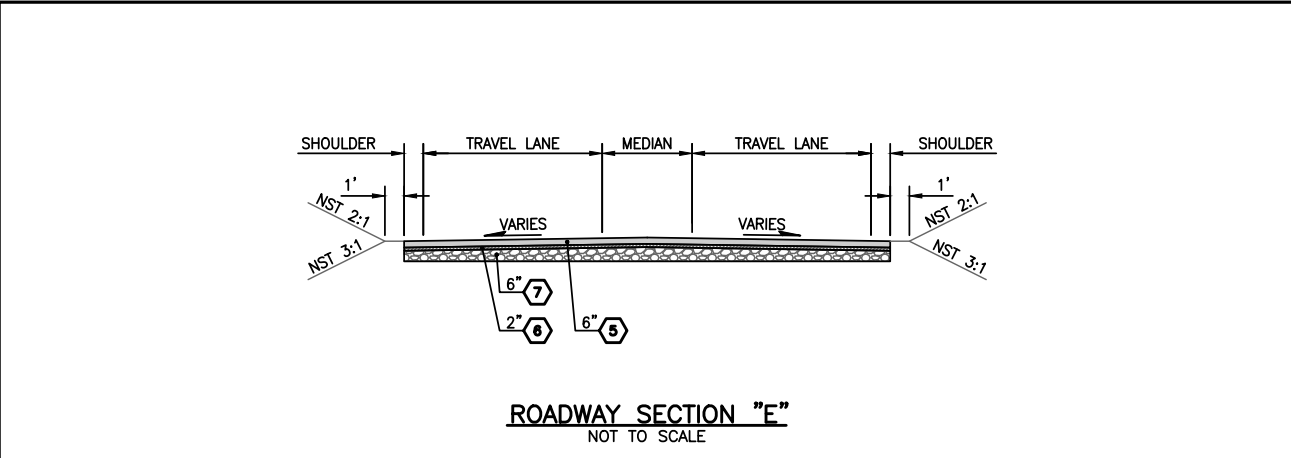


**CARPENTER ROAD/BRITTON PARKWAY
ROUNDABOUT**



TYPICAL ROADWAY SECTIONS

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**CARPENTER ROAD/BRITTON PARKWAY
ROUNDABOUT**

TYPICAL ROADWAY SECTIONS

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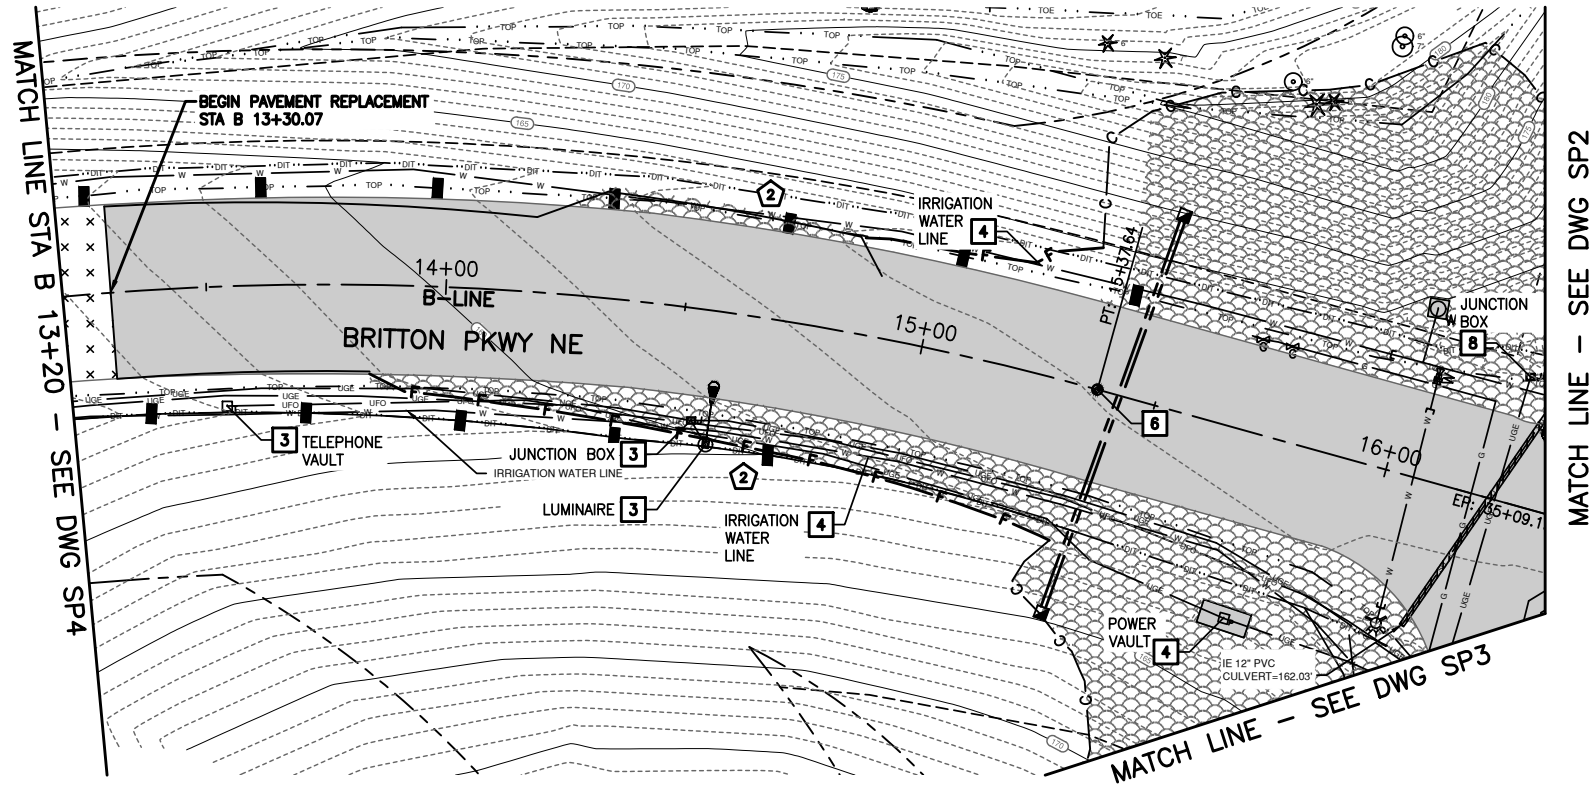


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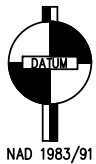
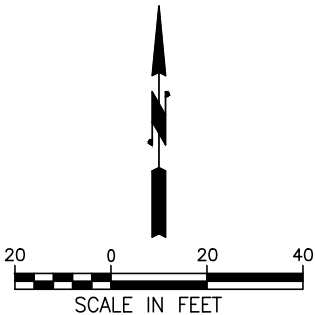


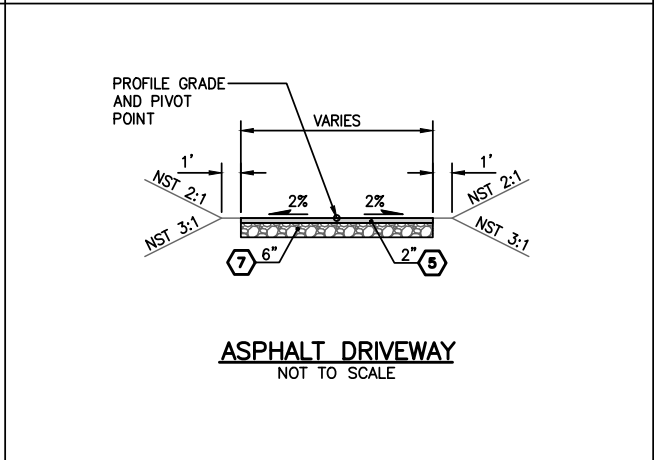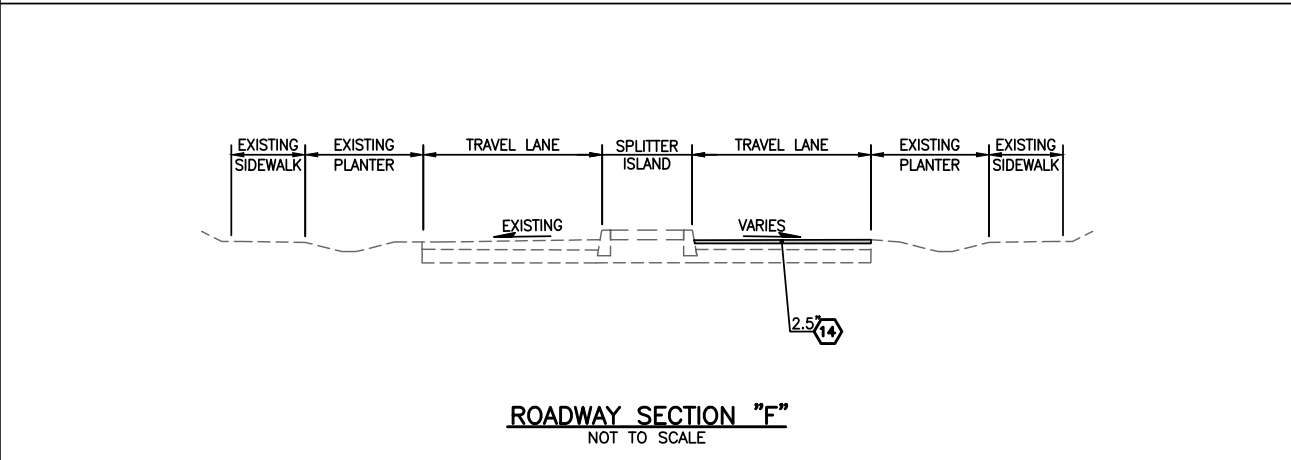- GENERAL NOTES:**
1. ADJUST GAS VALVES TO FINISHED GRADE.
 2. CATCH BASINS TO BE REMOVED SHALL HAVE INLET PROTECTION INSTALLED UNTIL REMOVAL.

- CONSTRUCTION NOTES:**
- 1 REMOVE ASPHALT CONC. PAVEMENT
 - 2 REMOVE CEMENT CONC. SIDEWALK
 - 3 PROTECT
 - 4 RELOCATE
 - 5 ADJUST TO FINISHED GRADE
 - 6 REPLACE MONUMENT
 - 7 PLUG AND ABANDON STORM SEWER LINE
 - 8 REMOVE
 - 9 CUT EXISTING STORMDRAIN PIPE
 - 10 RELOCATE (BY OTHERS)

- EROSION CONTROL NOTES:**
- 1 INSTALL STORM DRAIN INLET PROTECTION
 - 2 INSTALL STRAW BALES IN DITCH

- LEGEND**
- REMOVAL OF STRUCTURES AND OBSTRUCTIONS
 - 2.5" PAVEMENT PLANING
 - CLEAR AND GRUB AREA
 - STORM LINE TO BE ABANDONED
 - SAWCUT
 - CUT LINE
 - FILL LINE
 - STRAW BALE
 - EXISTING RIGHT OF WAY
 - EXISTING EASEMENT LINE
 - EXISTING PARCEL LINE
 - CITY/COUNTY BORDER



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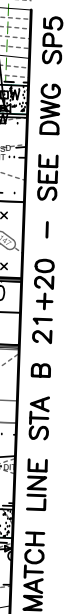
CARPENTERS ROAD/BRITTON PARKWAY
ROUNDBOUT

DEMOLITION AND TESC PLAN

DRAWING NUMBER

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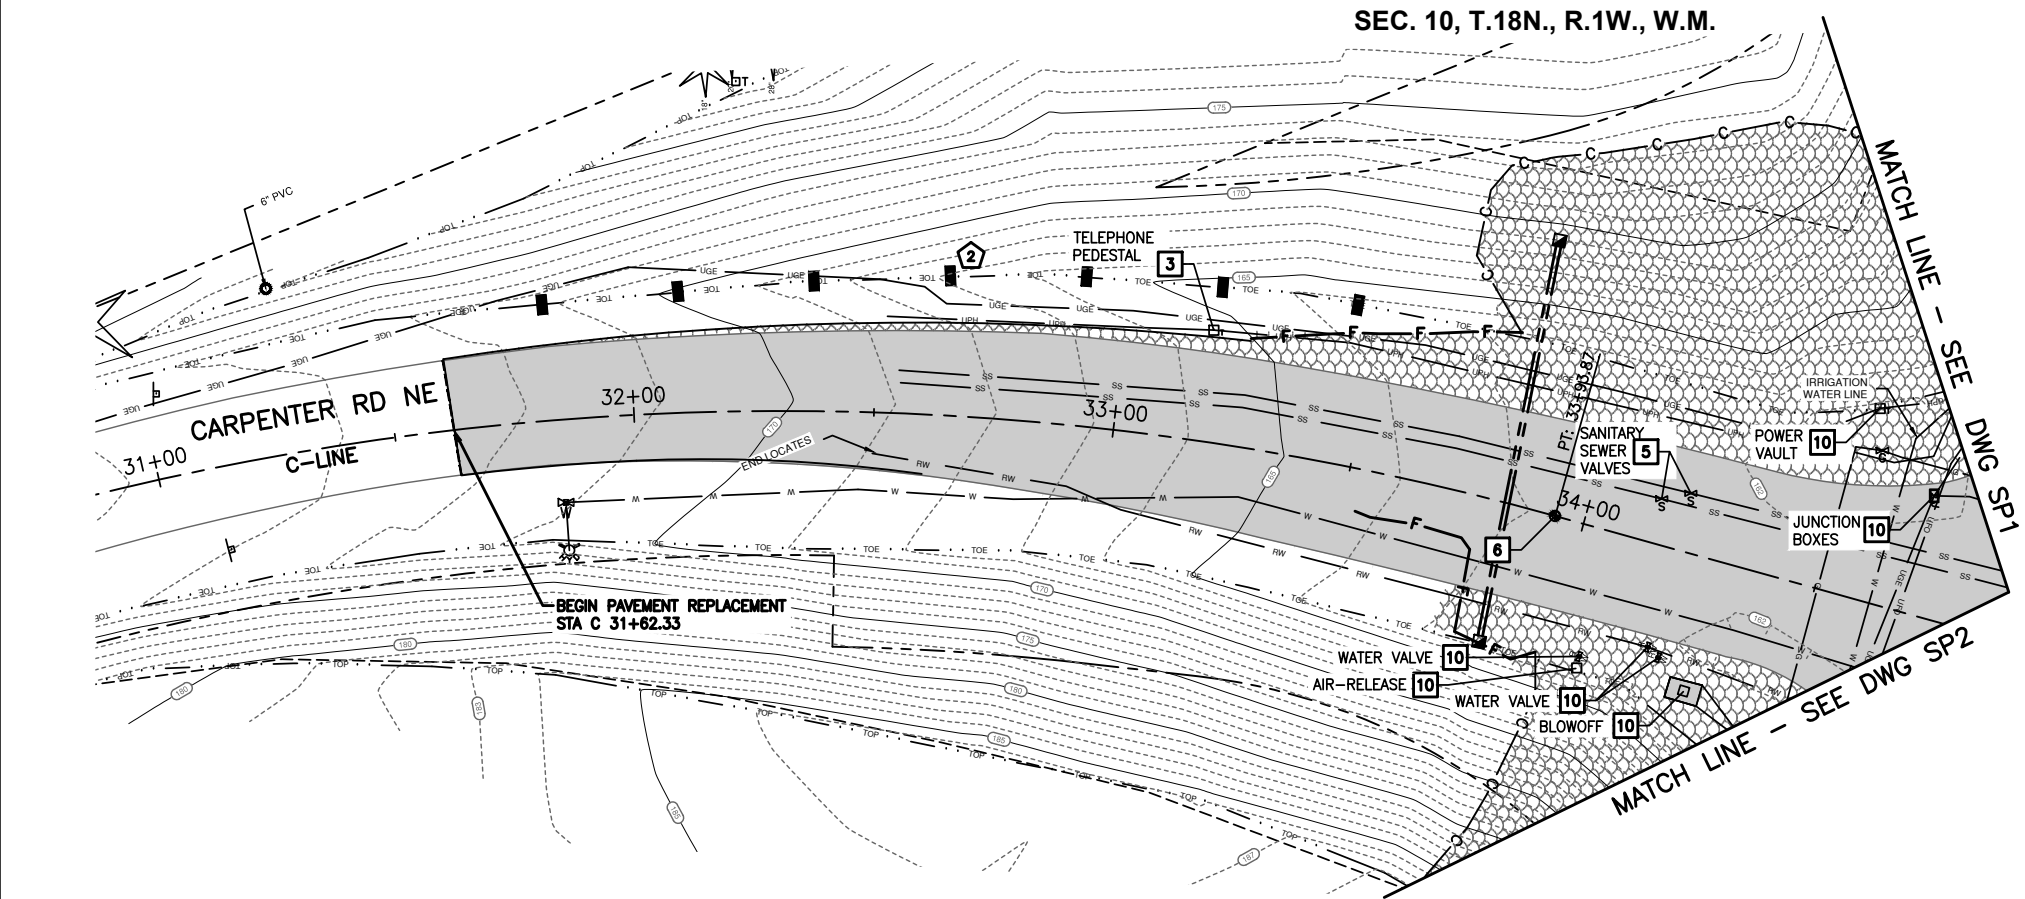
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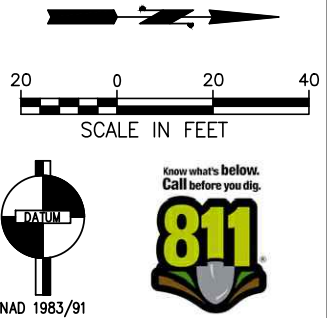


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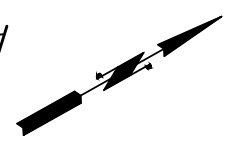


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CARPENTER ROAD/BRITTON PARKWAY
ROUNDBOUT
DEMOLITION AND TESC PLAN


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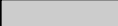
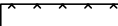








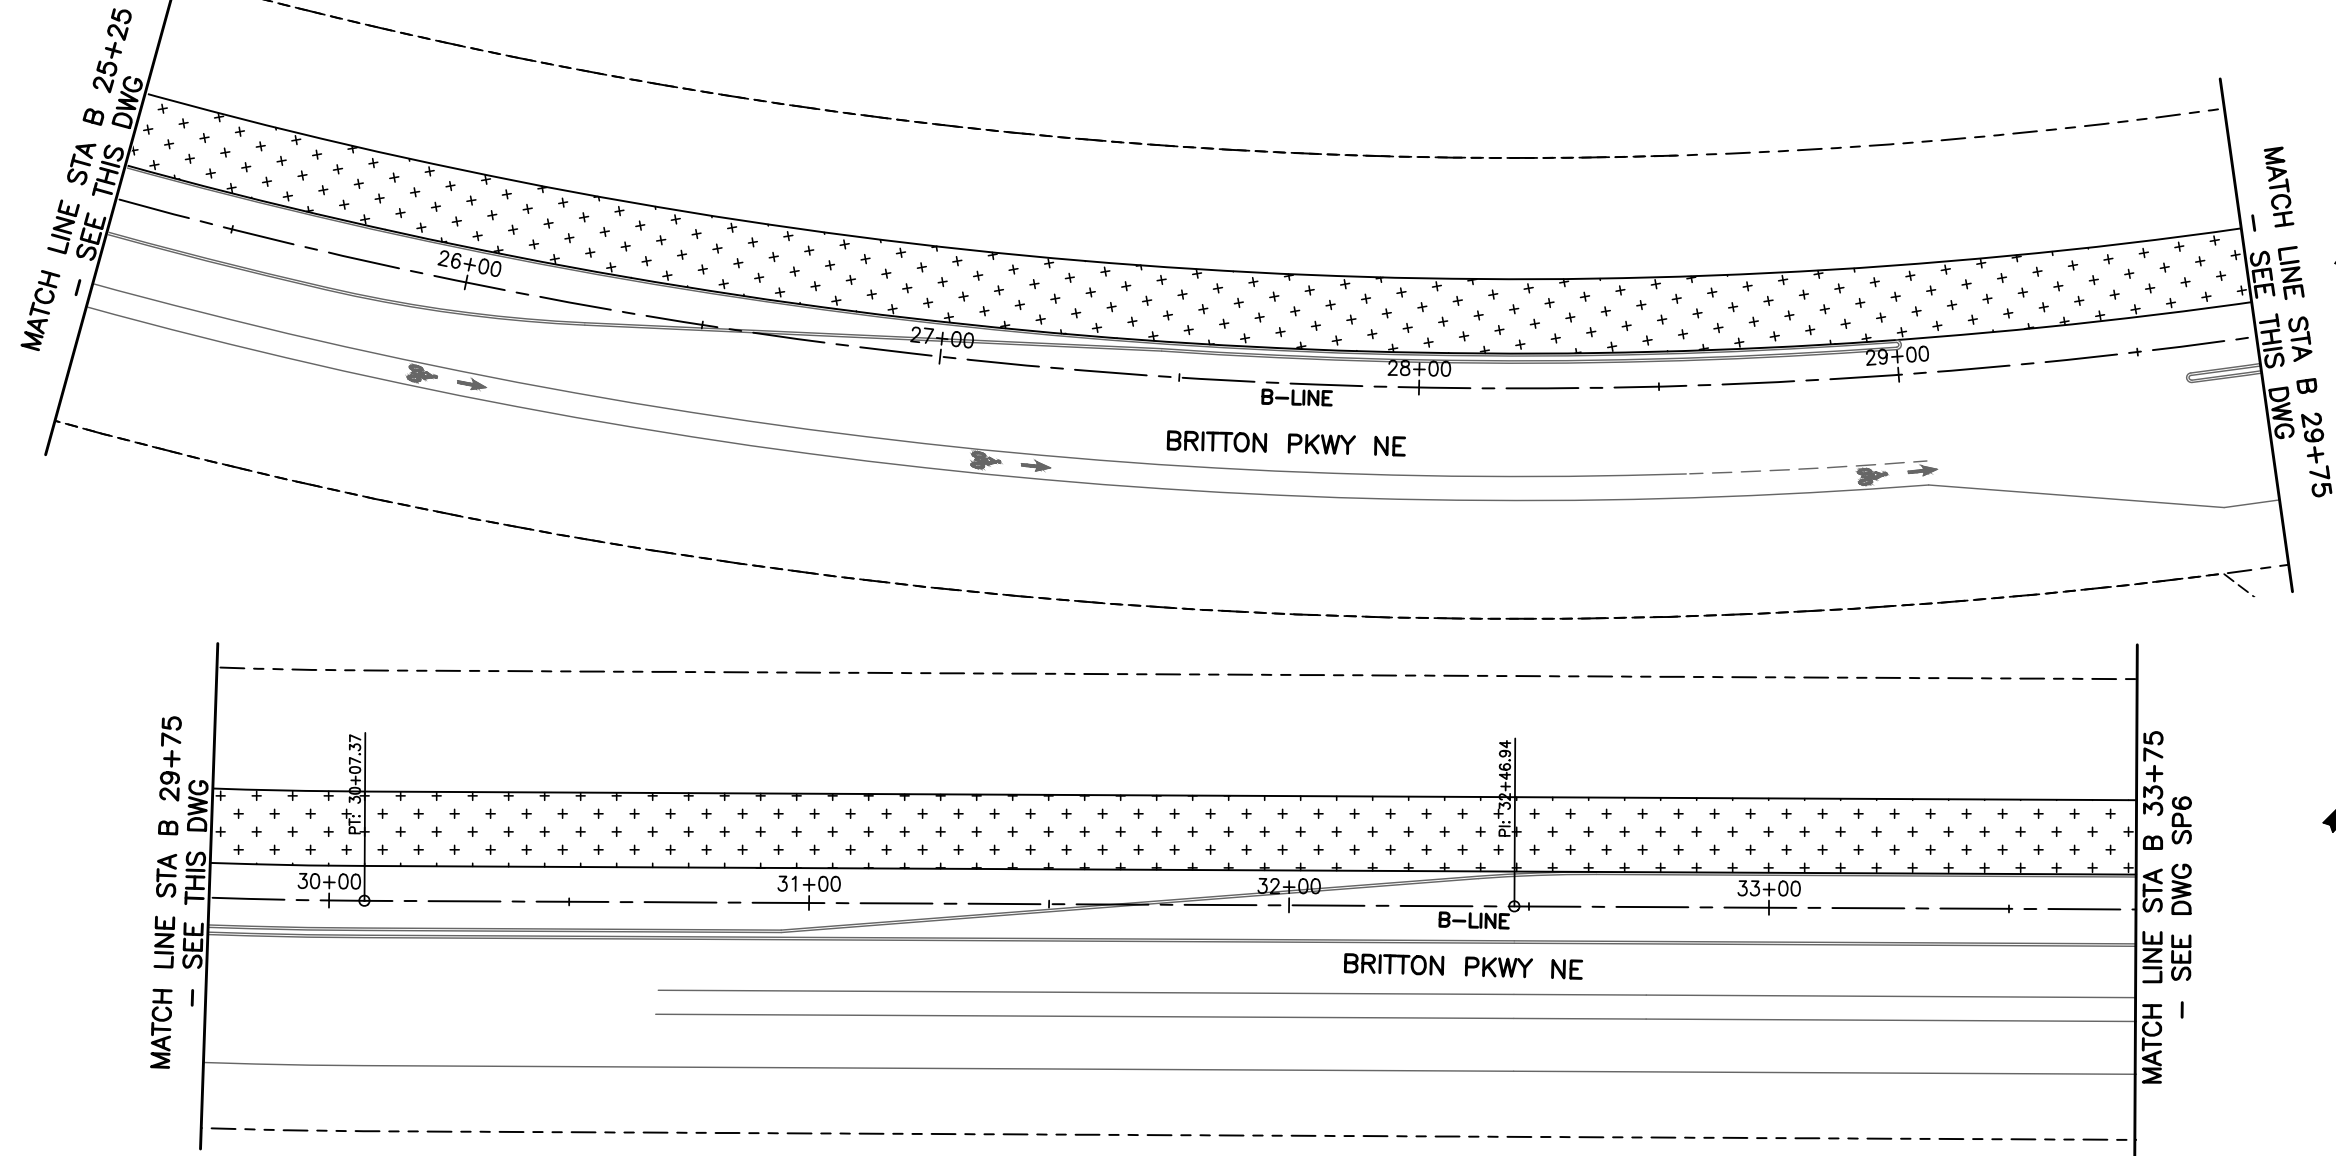

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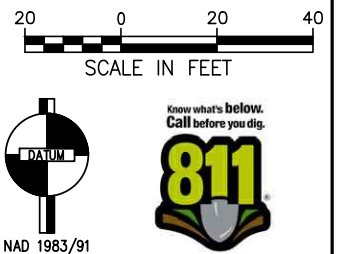
811

The logo for the 811 service, featuring the number 811 in a large, bold, yellow font with a black outline. Below the number is a stylized shovel with a silver head and a brown handle, set against a black background with green and brown accents.Page 9 of 64



- EROSION CONTROL NOTES:**
- 1** INSTALL STORM DRAIN INLET PROTECTION
- 2** INSTALL STRAW BALES IN DITCH

- | | |
|---|--|
|  | REMOVAL OF STRUCTURES AND OBSTRUCTIONS |
|  | 2.5" PAVEMENT PLANING |
|  | CLEAR AND GRUB AREA |
|  | STORM LINE TO BE ABANDONED |
|  | SAWCUT |
|  | CUT LINE |
|  | FILL LINE |
|  | STRAW BALE |
|  | EXISTING RIGHT OF WAY |
|  | EXISTING EASEMENT LINE |
|  | EXISTING PARCEL LINE |
|  | CITY/COUNTY BORDER |

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CARPENTER ROAD/BRITTON PARKWAY ROUNDBABOUT

DEMOLITION AND TESC PLAN


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- GENERAL NOTES:**
1. ADJUST GAS VALVES TO FINISHED GRADE.
 2. CATCH BASINS TO BE REMOVED SHALL HAVE INLET PROTECTION INSTALLED UNTIL REMOVAL.

- CONSTRUCTION NOTES:**
- 1 REMOVE ASPHALT CONC. PAVEMENT
 - 2 REMOVE CEMENT CONC. SIDEWALK
 - 3 PROTECT
 - 4 RELOCATE
 - 5 ADJUST TO FINISHED GRADE
 - 6 REPLACE MONUMENT
 - 7 PLUG AND ABANDON STORM SEWER LINE
 - 8 REMOVE
 - 9 CUT EXISTING STORMDRAIN PIPE
 - 10 RELOCATE (BY OTHERS)

- EROSION CONTROL NOTES:**
- 1 INSTALL STORM DRAIN INLET PROTECTION
 - 2 INSTALL STRAW BALES IN DITCH


- LEGEND**
- REMOVAL OF STRUCTURES AND OBSTRUCTIONS
 - 2.5" PAVEMENT PLANING
 - CLEAR AND GRUB AREA
 - STORM LINE TO BE ABANDONED
 - SAWCUT
 - CUT LINE
 - FILL LINE
 - STRAW BALE
 - EXISTING RIGHT OF WAY
 - EXISTING EASEMENT LINE
 - EXISTING PARCEL LINE
 - CITY/COUNTY BORDER

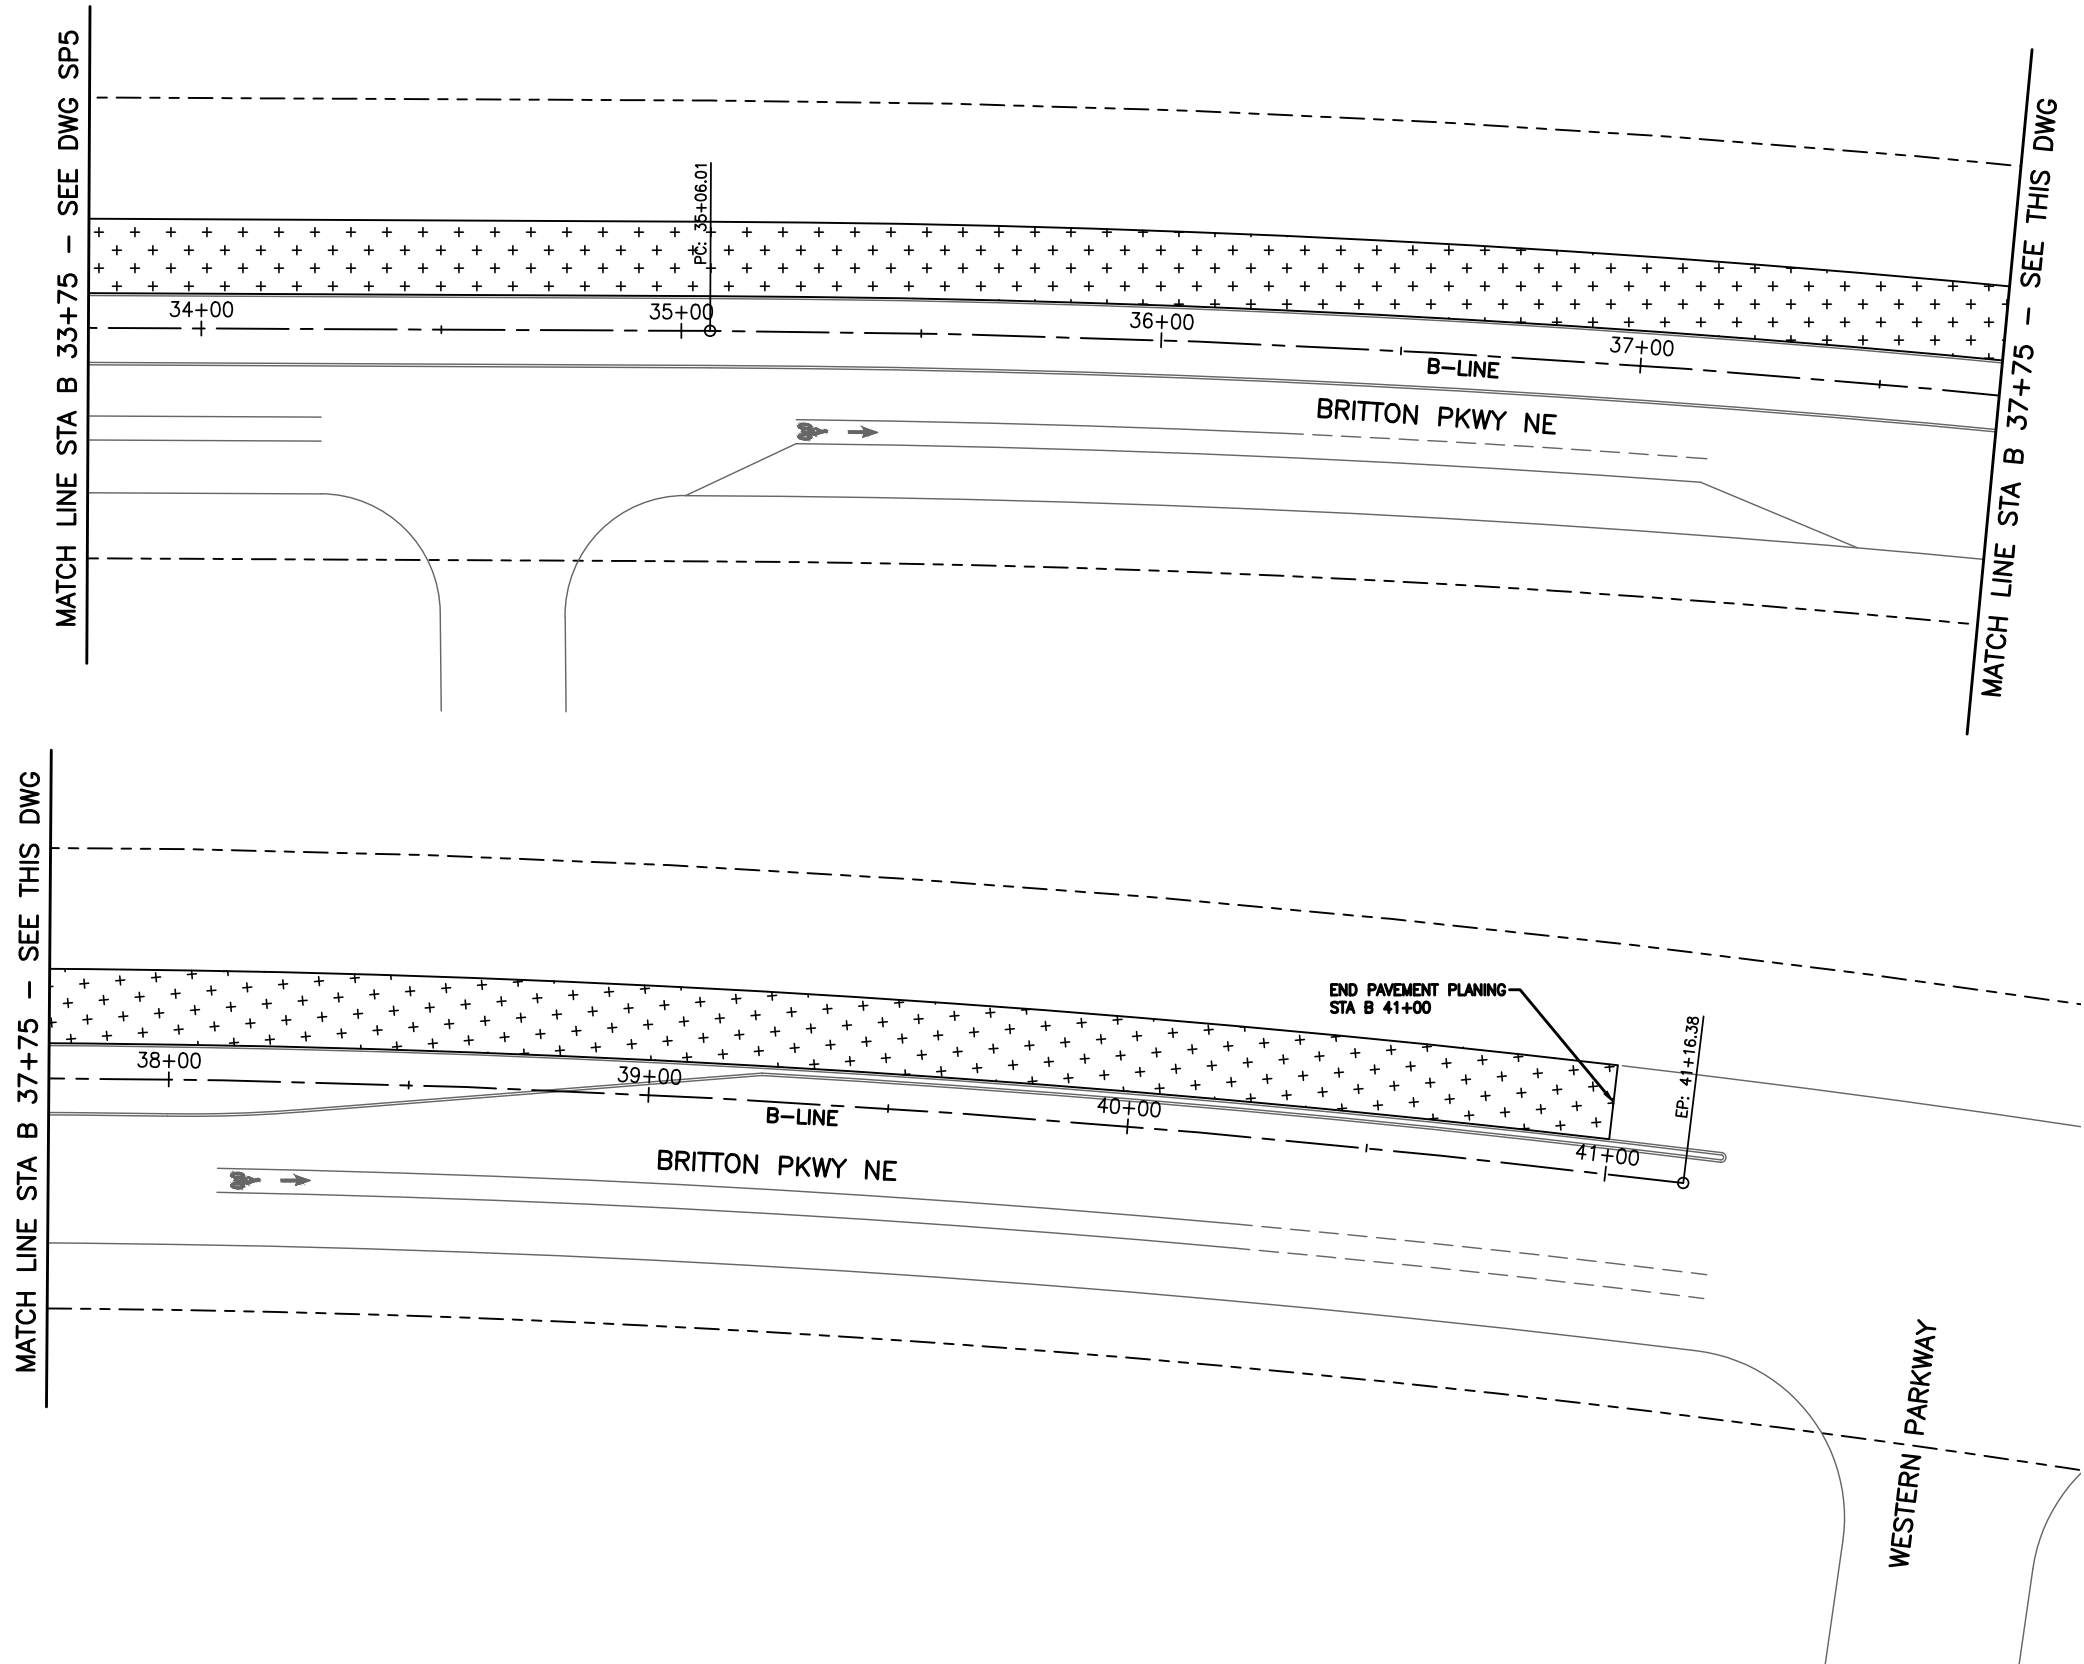

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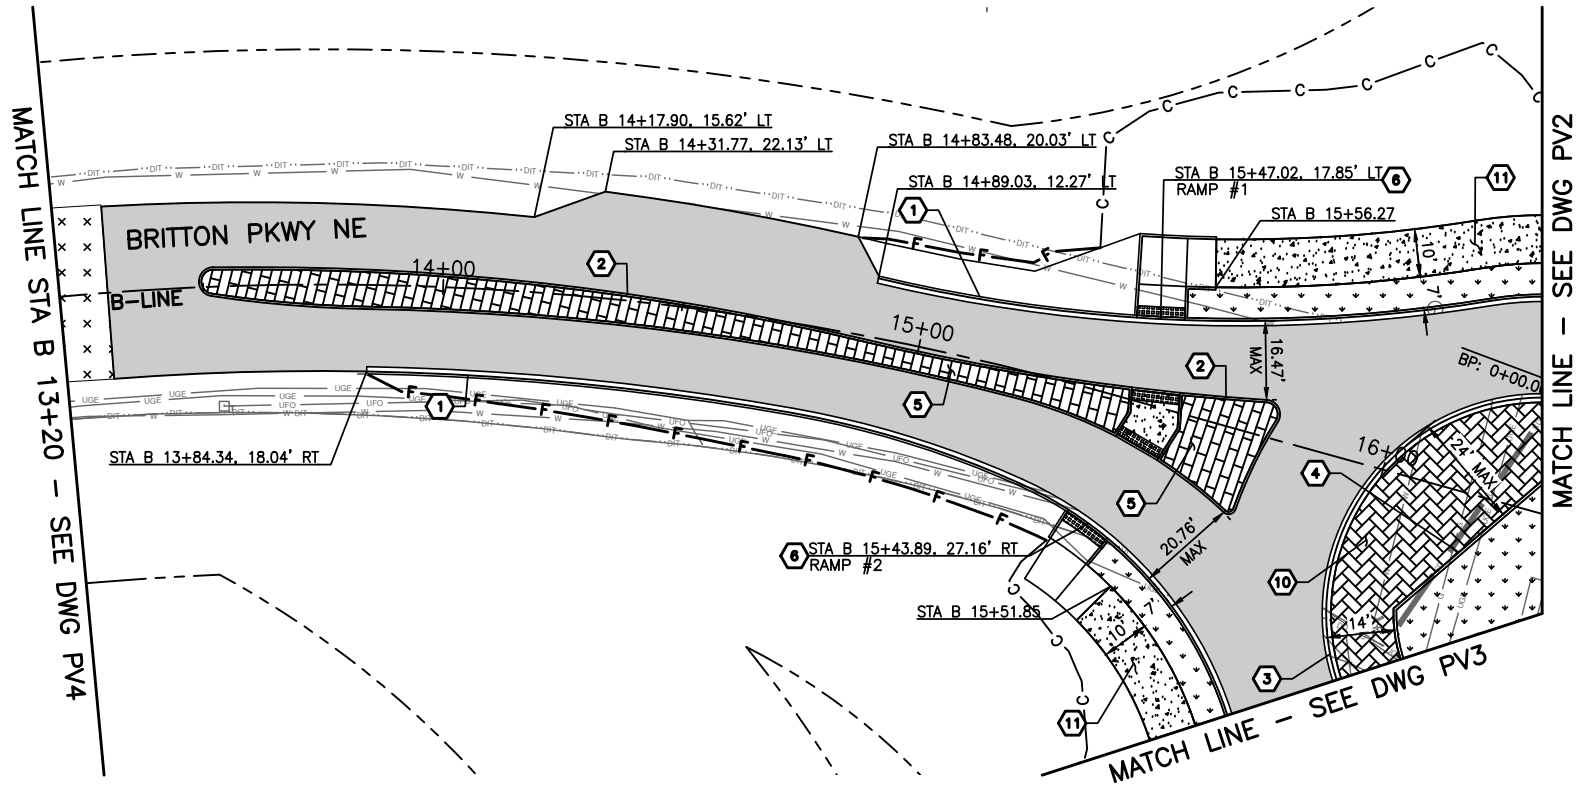


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| CARPENTER ROAD/BRITTON PARKWAY ROUNDBOUT |
| DEMOLITION AND TESC PLAN |

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SEC. 10, T.18N., R.1W., W.M.

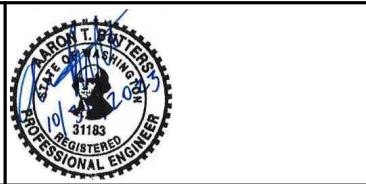

GENERAL NOTES

- DIMENSIONS ARE TO FACE OF CURB AND ARE GIVEN FOR INFORMATION PURPOSES ONLY. SEE GRADING PLAN FOR DETAILED HORIZONTAL GEOMETRY.
- STATIONS ARE TO FACE OF CURB. RAMP STATIONS ARE TO CENTERLINE OF RAMP.

LEGEND

- HMA FULL DEPTH PAVING
- HMA OVERLAY
- SIDEWALK
- TRUCK APRON
- LANDSCAPE PER DWG LS1-LS3
- TEXTURED PIGMENTED CONCRETE
- CUT LINE
- FILL LINE

CONSTRUCTION NOTES:


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- 2 CEMENT CONCRETE TRAFFIC CURB
- 3 ROUNDABOUT TRUCK APRON CEMENT CONCRETE CURB AND GUTTER
- 4 MODIFIED CEMENT CONCRETE TRAFFIC CURB
- 5 CONCRETE SPLITTER ISLAND
- 6 CEMENT CONCRETE CURB RAMP TYPE COMBINATION
- 7 CEMENT CONCRETE CURB RAMP TYPE III
- 8 CEMENT CONCRETE BIKE RAMP
- 9 CEMENT CONCRETE DRIVEWAY TYPE I
- 10 CONCRETE TRUCK APRON
- 11 CEMENT CONCRETE SIDEWALK



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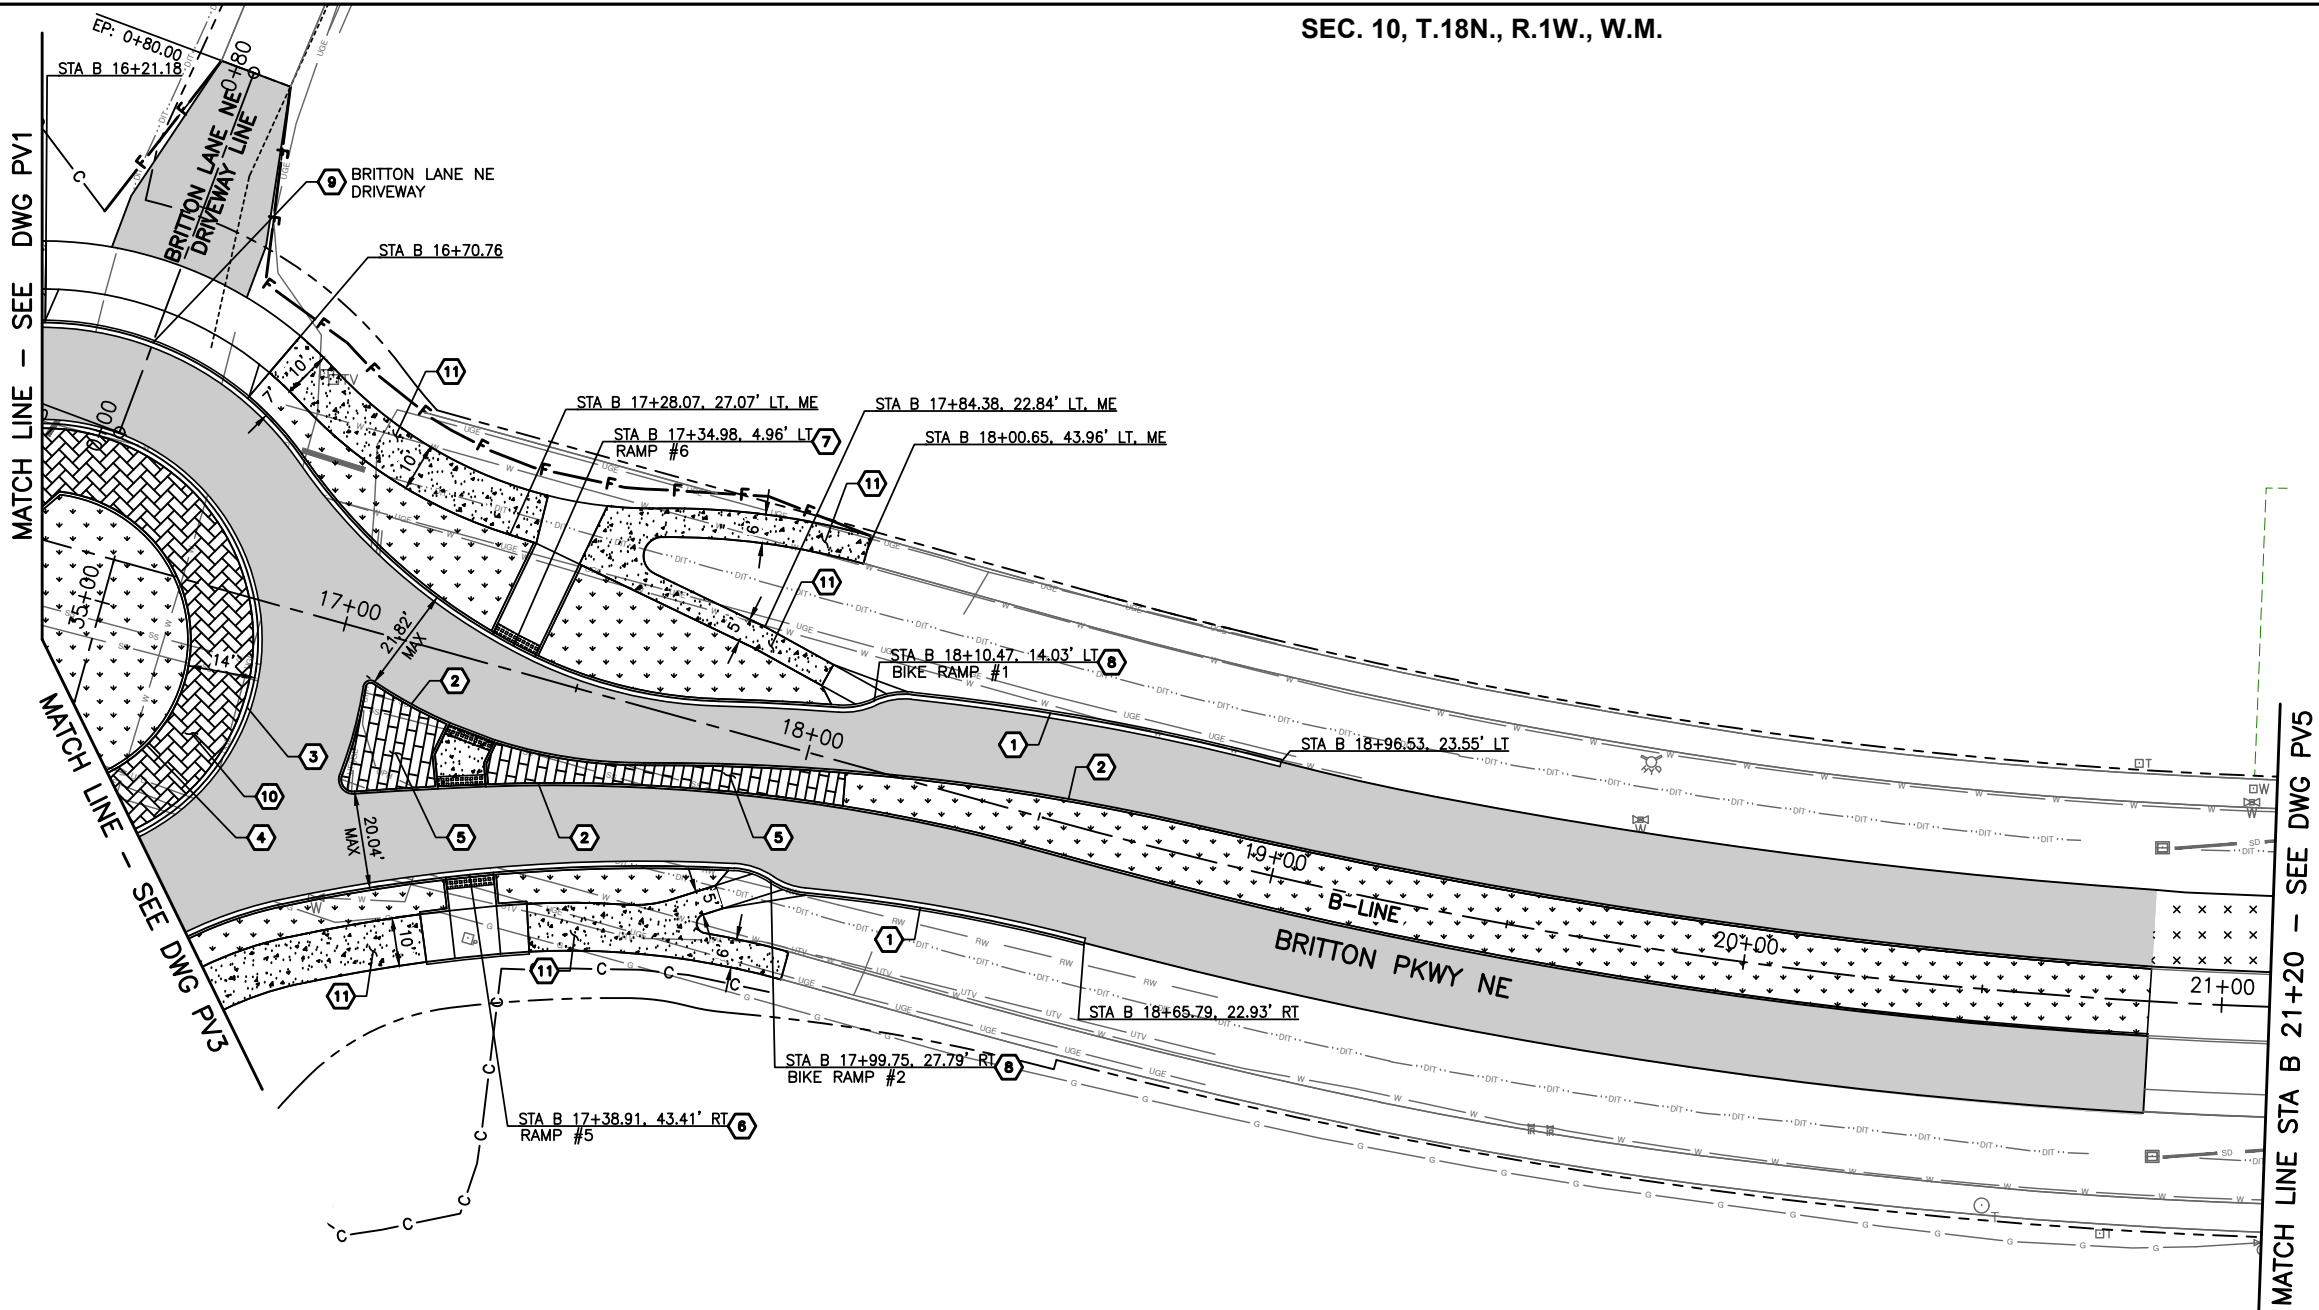


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| CARPENTER ROAD/BRITTON PARKWAY ROUNDABOUT |
| PAVING PLAN |

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GENERAL NOTES

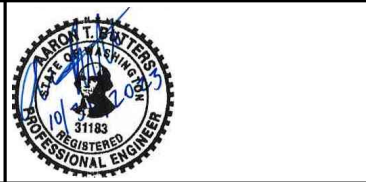- DIMENSIONS ARE TO FACE OF CURB AND ARE GIVEN FOR INFORMATION PURPOSES ONLY. SEE GRADING PLAN FOR DETAILED HORIZONTAL GEOMETRY.
- STATIONS ARE TO FACE OF CURB. RAMP STATIONS ARE TO CENTERLINE OF RAMP.

LEGEND

- HMA FULL DEPTH PAVING
- HMA OVERLAY
- SIDEWALK
- TRUCK APRON
- LANDSCAPE PER DWG LS1-LS3
- TEXTURED PIGMENTED CONCRETE
- CUT LINE
- FILL LINE

CONSTRUCTION NOTES:

- 1 CEMENT CONCRETE CURB & GUTTER
- 2 CEMENT CONCRETE TRAFFIC CURB
- 3 ROUNDABOUT TRUCK APRON CEMENT CONCRETE CURB AND GUTTER
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- 10 CONCRETE TRUCK APRON
- 11 CEMENT CONCRETE SIDEWALK



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CARPENTER ROAD/BRITTON PARKWAY
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GENERAL NOTES

- DIMENSIONS ARE TO FACE OF CURB AND ARE GIVEN FOR INFORMATION PURPOSES ONLY. SEE GRADING PLAN FOR DETAILED HORIZONTAL GEOMETRY.
- STATIONS ARE TO FACE OF CURB. RAMP STATIONS ARE TO CENTERLINE OF RAMP.

LEGEND

- HMA FULL DEPTH PAVING
- HMA OVERLAY
- SIDEWALK
- TRUCK APRON
- LANDSCAPE PER DWG LS1-LS3
- TEXTURED PIGMENTED CONCRETE
- CUT LINE
- FILL LINE

CONSTRUCTION NOTES:

- 1 CEMENT CONCRETE CURB & GUTTER
- 2 CEMENT CONCRETE TRAFFIC CURB
- 3 ROUNDABOUT TRUCK APRON CEMENT CONCRETE CURB AND GUTTER
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- 11 CEMENT CONCRETE SIDEWALK



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CARPENTER ROAD/BRITTON PARKWAY
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PV3

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GENERAL NOTES

1. DIMENSIONS ARE TO FACE OF CURB AND ARE GIVEN FOR INFORMATION PURPOSES ONLY. SEE GRADING PLAN FOR DETAILED HORIZONTAL GEOMETRY.
2. STATIONS ARE TO FACE OF CURB. RAMP STATIONS ARE TO CENTERLINE OF RAMP.

LEGEND

- HMA FULL DEPTH PAVING
- HMA OVERLAY
- SIDEWALK
- TRUCK APRON
- LANDSCAPE PER DWG LS1-LS3
- TEXTURED PIGMENTED CONCRETE
- C CUT LINE
- F FILL LINE

CONSTRUCTION NOTES:

- 1 CEMENT CONCRETE CURB & GUTTER
- 2 CEMENT CONCRETE TRAFFIC CURB
- 3 ROUNDABOUT TRUCK APRON CEMENT CONCRETE CURB AND GUTTER
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- 9 CEMENT CONCRETE DRIVEWAY TYPE I
- 10 CONCRETE TRUCK APRON
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CARPENTER ROAD/BRITTON PARKWAY
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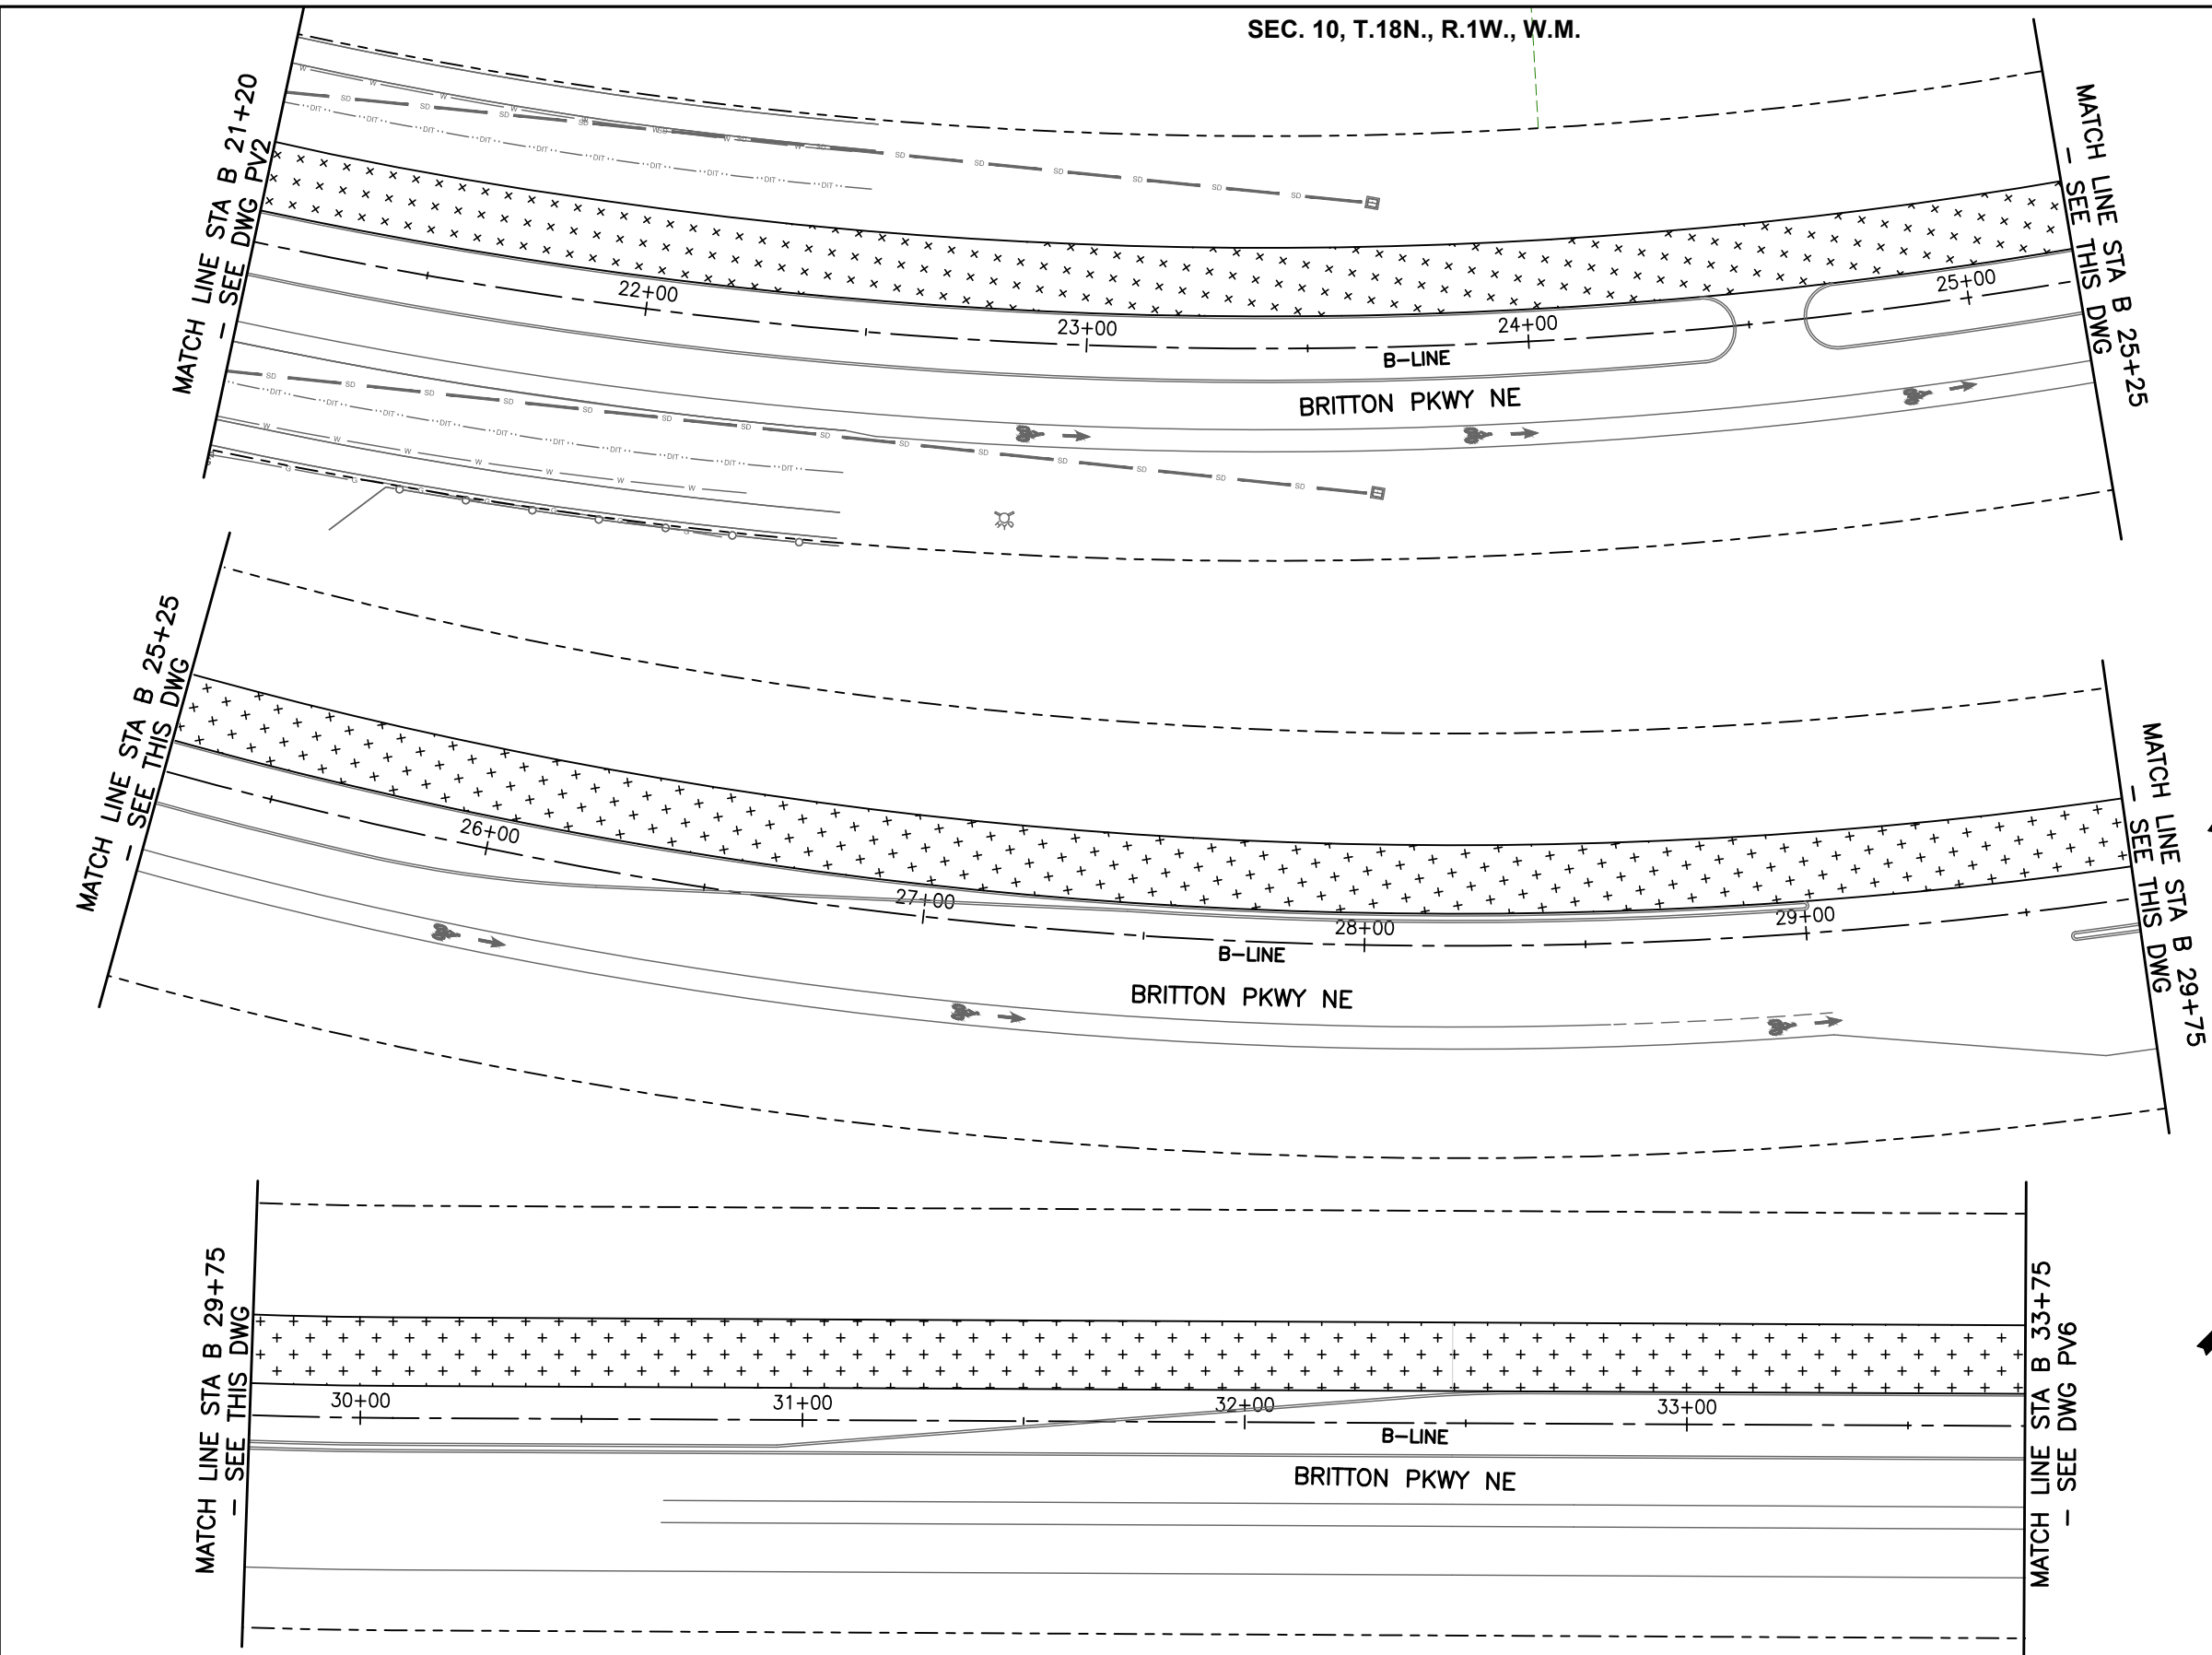
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- GENERAL NOTES**
- DIMENSIONS ARE TO FACE OF CURB AND ARE GIVEN FOR INFORMATION PURPOSES ONLY. SEE GRADING PLAN FOR DETAILED HORIZONTAL GEOMETRY.
 - STATIONS ARE TO FACE OF CURB. RAMP STATIONS ARE TO CENTERLINE OF RAMP.

- LEGEND**
- HMA FULL DEPTH PAVING
 - HMA OVERLAY
 - SIDEWALK
 - TRUCK APRON
 - LANDSCAPE PER DWG LS1-LS3
 - TEXTURED PIGMENTED CONCRETE
 - CUT LINE
 - FILL LINE

- CONSTRUCTION NOTES:**
- CEMENT CONCRETE CURB & GUTTER
 - CEMENT CONCRETE TRAFFIC CURB
 - ROUNDABOUT TRUCK APRON CEMENT CONCRETE CURB AND GUTTER
 - MODIFIED CEMENT CONCRETE TRAFFIC CURB
 - CONCRETE SPLITTER ISLAND
 - CEMENT CONCRETE CURB RAMP TYPE COMBINATION
 - CEMENT CONCRETE CURB RAMP TYPE III
 - CEMENT CONCRETE BIKE RAMP
 - CEMENT CONCRETE DRIVEWAY TYPE I
 - CONCRETE TRUCK APRON
 - CEMENT CONCRETE SIDEWALK

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**CARPENTER ROAD/BRITTON PARKWAY
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PV5
SHT 16 OF 64

GENERAL NOTES

1. DIMENSIONS ARE TO FACE OF CURB AND ARE GIVEN FOR INFORMATION PURPOSES ONLY. SEE GRADING PLAN FOR DETAILED HORIZONTAL GEOMETRY.
2. STATIONS ARE TO FACE OF CURB. RAMP STATIONS ARE TO CENTERLINE OF RAMP.

LEGEND

- HMA FULL DEPTH PAVING
- HMA OVERLAY
- SIDEWALK
- TRUCK APRON
- LANDSCAPE PER DWG LS1-LS3
- TEXTURED PIGMENTED CONCRETE
- C

CUT LINE
- F

FILL LINE

CONSTRUCTION NOTES:

- 1 CEMENT CONCRETE CURB & GUTTER
- 2 CEMENT CONCRETE TRAFFIC CURB
- 3 ROUNDABOUT TRUCK APRON CEMENT CONCRETE CURB AND GUTTER
- 4 MODIFIED CEMENT CONCRETE TRAFFIC CURB
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CARPENTER ROAD/BRITTON PARKWAY
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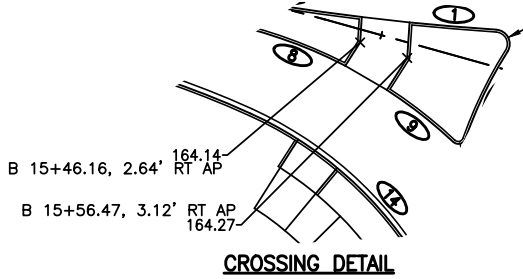
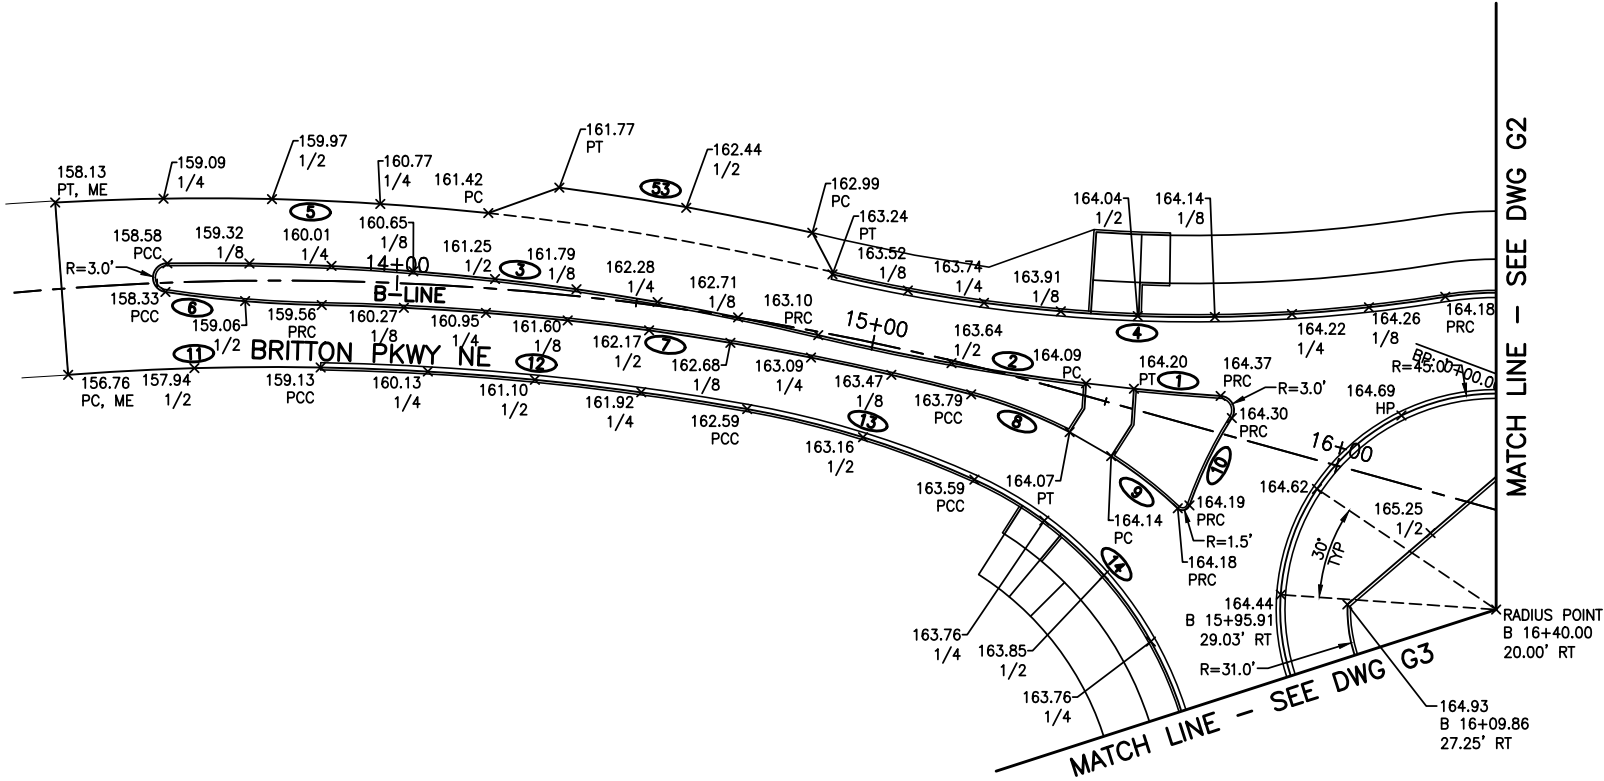
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GENERAL NOTES:


1. SPOT ELEVATIONS LOCATED ON CURB LINES ARE AT FLOWLINE, FACE OF CURB, OR EDGE OF PAVEMENT UNLESS OTHERWISE NOTED.

LEGEND:

| | |
|----------|--|
| | CURVE |
| | GRADE BREAK LINE |
| X 123.45 | SPOT ELEVATION, FINISHED GRADE |
| ME | MATCH EXISTING |
| 1/2 | 1/2 DELTA OF CURVE OR 1/2 POINT ALONG LINE SEGMENT |
| 1/4 | 1/4 DELTA OF CURVE OR 1/4 POINT ALONG LINE SEGMENT |
| 1/8 | 1/8 DELTA OF CURVE OR 1/8 POINT ALONG LINE SEGMENT |
| LP | LOW POINT |
| HP | HIGH POINT |
| C | CUT LIMIT |
| F | FILL LIMIT |



| CURVE TABLE | | | | | | | |
|-------------|--------|--------|-----------|---------|-------------------------------|-------------------------------|------------------------------|
| CURVE | LENGTH | RADIUS | DELTA | TANGENT | STATION, OFFSET | STATION, OFFSET | RADIUS POINT STATION, OFFSET |
| 1 | 18.12 | 501.00 | 2°04'20" | 9.06 | PRC STA B 15+72.77, 7.51' LT | PT STA B 15+54.97, 4.13' LT | STA B 15+00.95, 500.00' LT |
| 2 | 56.73 | 501.00 | 6°29'15" | 28.39 | PC STA B 15+45.08, 2.54' LT | PRC STA B 14+88.52, 0.72' RT | STA B 15+00.95, 500.00' LT |
| 3 | 136.76 | 549.00 | 14°16'24" | 68.74 | PRC STA B 14+88.52, 0.72' RT | PCC STA B 13+52.27, 4.02' LT | STA B 12+14.65, 543.35' RT |
| 4 | 128.60 | 325.00 | 22°40'17" | 65.15 | PRC STA B 16+12.36, 39.93' LT | PT STA B 14+89.03, 12.27' LT | STA B 14+98.29, 337.06' LT |
| 5 | 90.34 | 562.50 | 9°12'07" | 45.27 | PC STA B 14+17.90, 15.62' LT | PT STA B 13+30.07, 18.00' LT | STA B 12+14.65, 543.35' RT |
| 6 | 32.71 | 250.00 | 7°29'50" | 16.38 | PCC STA B 13+51.64, 1.93' RT | PRC STA B 13+84.38, 5.04' RT | STA B 13+84.82, 244.96' LT |
| 7 | 136.86 | 576.00 | 13°36'48" | 68.75 | PRC STA B 13+84.38, 5.04' RT | PCC STA B 15+22.47, 5.89' RT | STA B 13+39.28, 580.98' RT |
| 8 | 21.99 | 100.00 | 12°36'08" | 11.04 | PCC STA B 15+22.47, 5.89' RT | PT STA B 15+44.47, 8.16' RT | STA B 15+21.26, 105.89' RT |
| 9 | 17.65 | 100.00 | 10°06'42" | 8.85 | PC STA B 15+54.16, 10.68' RT | PRC STA B 15+70.44, 17.43' RT | STA B 15+21.26, 105.89' RT |
| 10 | 20.28 | 90.00 | 12°54'28" | 10.18 | PRC STA B 15+72.63, 16.20' RT | PRC STA B 15+76.25, 3.71' LT | STA B 16+62.43, 22.26' RT |
| 11 | 52.65 | 563.00 | 5°21'29" | 26.34 | PC STA B 13+30.07, 17.99' RT | PCC STA B 13+84.34, 18.04' RT | STA B 13+39.28, 580.98' RT |
| 12 | 89.37 | 563.00 | 9°05'43" | 44.78 | PCC STA B 13+84.34, 18.04' RT | PCC STA B 14+76.51, 18.50' RT | STA B 13+39.28, 580.98' RT |
| 13 | 49.66 | 200.00 | 14°13'38" | 24.96 | PCC STA B 14+76.51, 18.50' RT | PCC STA B 15+27.63, 22.91' RT | STA B 14+74.11, 218.49' RT |
| 14 | 67.67 | 80.00 | 48°27'54" | 36.01 | PCC STA B 15+27.63, 22.91' RT | PCC STA B 15+83.05, 58.82' RT | STA B 15+11.26, 101.56' RT |
| 53 | 53.57 | 569.50 | 5°23'21" | 26.80 | PCC STA B 14+83.48, 20.03' LT | PCC STA B 14+31.77, 22.13' LT | STA B 12+14.65, 543.35' RT |

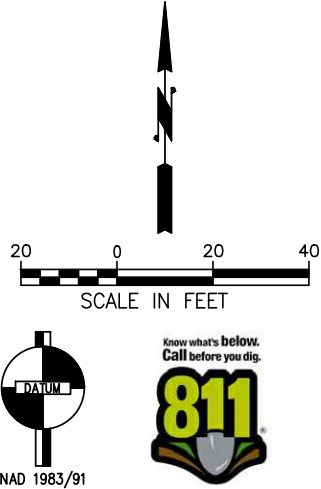

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CARPENTER ROAD/BRITTON PARKWAY
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ROUNDAABOUT GRADING PLAN

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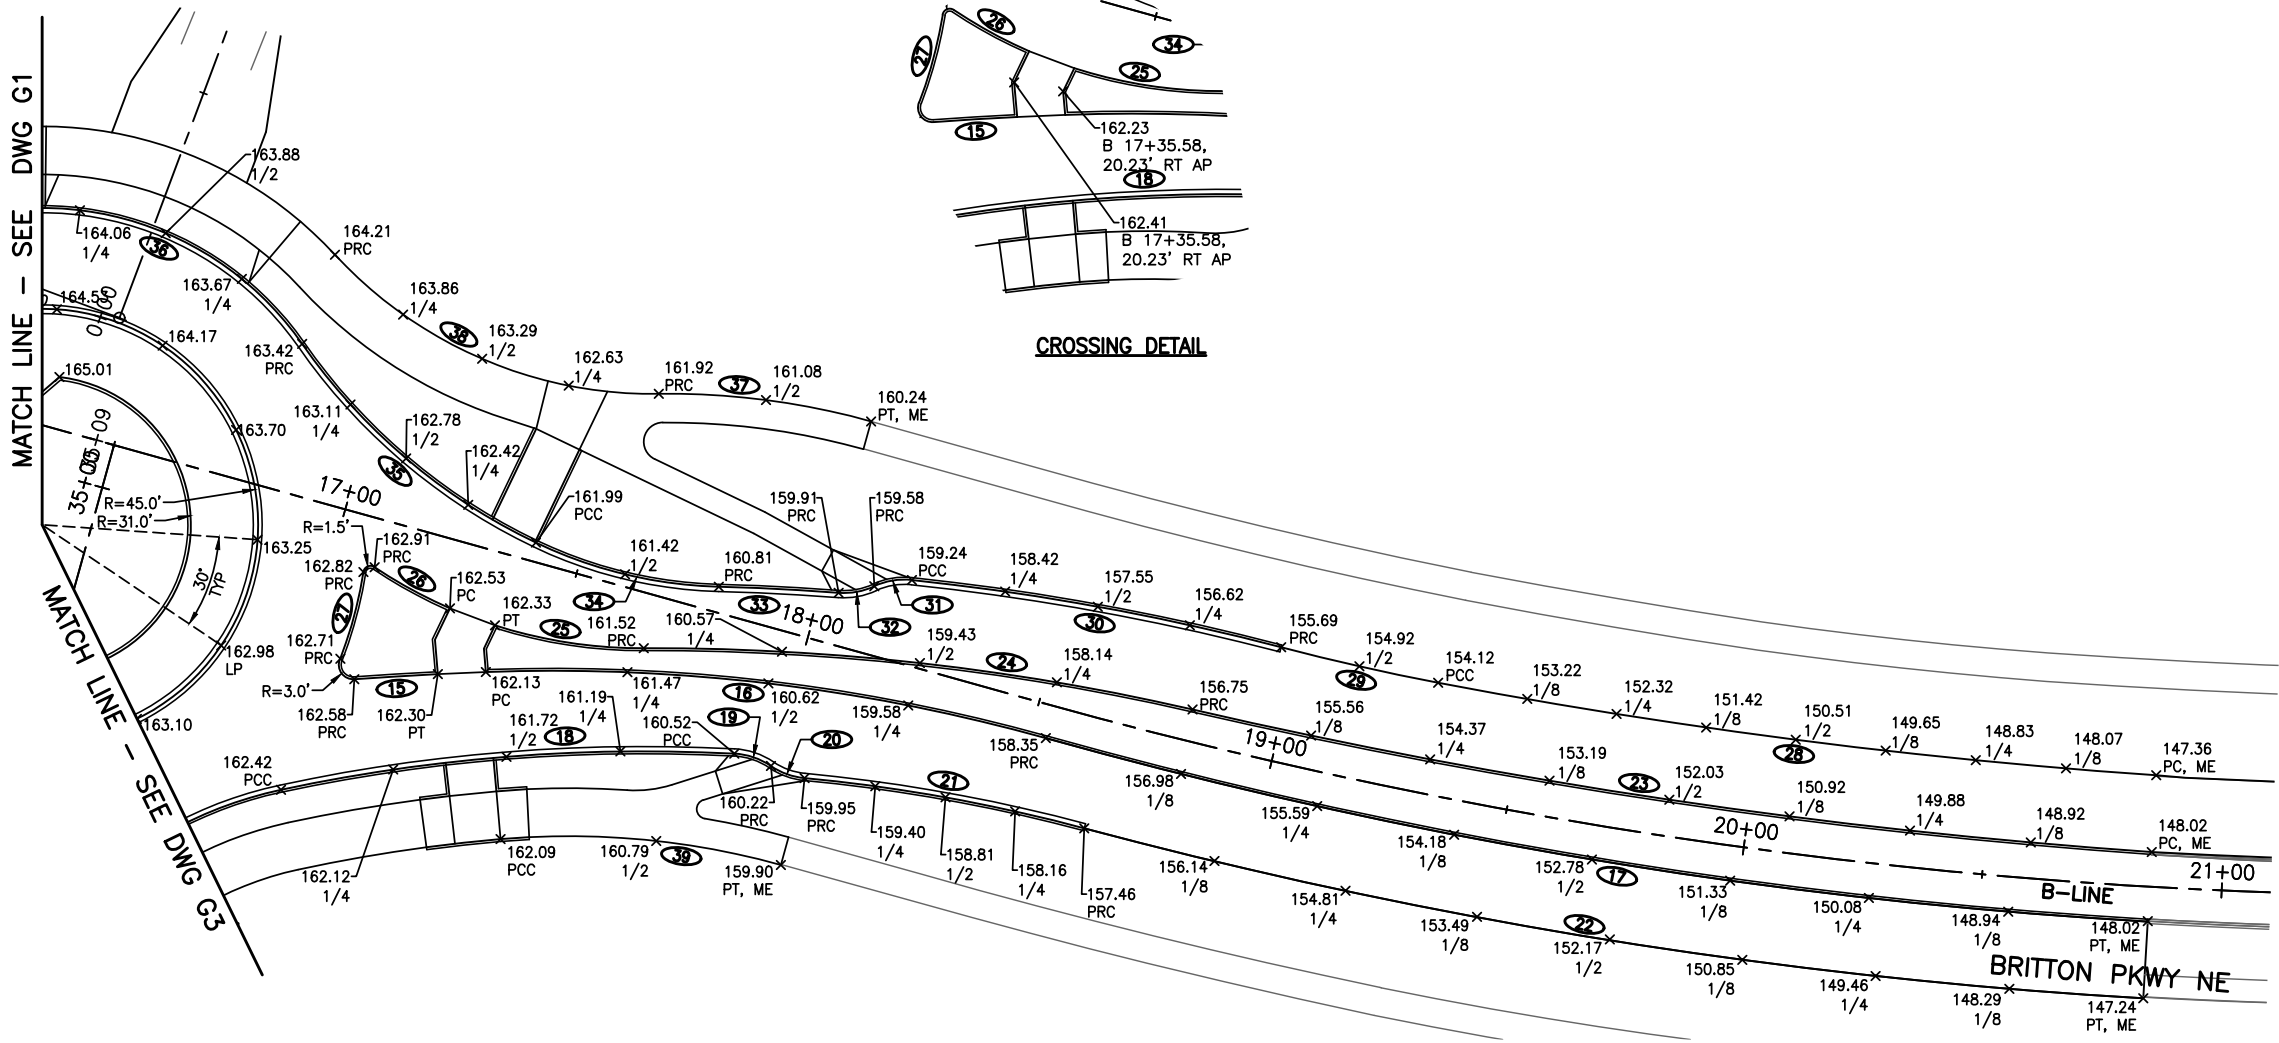
SHT 18 OF 64

GENERAL NOTES:

1. SPOT ELEVATIONS LOCATED ON CURB LINES ARE AT FLOWLINE, FACE OF CURB, OR EDGE OF PAVEMENT UNLESS OTHERWISE NOTED.

LEGEND:

- (X) CURVE
----- GRADE BREAK LINE
X 123.45 SPOT ELEVATION, FINISHED GRADE
ME MATCH EXISTING
1/2 1/2 DELTA OF CURVE OR 1/2 POINT ALONG LINE SEGMENT
1/4 1/4 DELTA OF CURVE OR 1/4 POINT ALONG LINE SEGMENT
1/8 1/8 DELTA OF CURVE OR 1/8 POINT ALONG LINE SEGMENT
LP LOW POINT
HP HIGH POINT
---C--- CUT LIMIT
---F--- FILL LIMIT



| CURVE TABLE | | | | | | | |
|-------------|--------|---------|-----------|---------|-------------------------------|-------------------------------|------------------------------|
| CURVE | LENGTH | RADIUS | DELTA | TANGENT | STATION, OFFSET | STATION, OFFSET | RADIUS POINT STATION, OFFSET |
| 15 | 17.44 | 800.00 | 1°14'57" | 8.72 | PRC STA B 17+11.29, 33.60' RT | PT STA B 17+27.78, 27.92' RT | STA B 19+26.18, 791.46' RT |
| 16 | 117.92 | 381.00 | 17°44'00" | 59.44 | PC STA B 17+37.30, 24.82' RT | PRC STA B 18+53.35, 6.89' RT | STA B 18+52.30, 387.89' RT |
| 17 | 233.16 | 1085.00 | 12°18'46" | 117.03 | PRC STA B 18+53.35, 6.89' RT | PT STA B 20+85.01, 7.26' RT | STA B 20+55.73, 1077.73' LT |
| 18 | 95.00 | 360.00 | 15°07'11" | 47.78 | PCC STA B 17+02.73, 59.87' RT | PCC STA B 17+91.70, 27.36' RT | STA B 18+64.87, 378.93' RT |
| 19 | 8.15 | 15.00 | 31°08'48" | 4.18 | PCC STA B 17+91.70, 27.36' RT | PRC STA B 17+99.75, 27.79' RT | STA B 17+94.95, 42.01' RT |
| 20 | 7.53 | 15.00 | 28°44'59" | 3.84 | PRC STA B 17+99.75, 27.79' RT | PRC STA B 18+07.17, 28.35' RT | STA B 18+04.54, 13.58' RT |
| 21 | 59.25 | 356.00 | 9°32'11" | 29.70 | PRC STA B 18+07.17, 28.35' RT | PRC STA B 18+65.79, 22.93' RT | STA B 18+64.87, 378.93' RT |
| 22 | 223.85 | 1101.00 | 11°38'56" | 112.31 | PRC STA B 18+65.79, 22.93' RT | PT STA B 20+85.02, 23.26' RT | STA B 20+55.73, 1077.73' LT |
| 23 | 202.22 | 1276.00 | 9°04'48" | 101.32 | PC STA B 20+85.00, 7.26' LT | PRC STA B 18+81.42, 6.63' LT | STA B 18+24.85, 1281.80' LT |
| 24 | 115.31 | 499.00 | 13°14'25" | 57.91 | PRC STA B 18+81.42, 6.63' LT | PRC STA B 17+67.64, 11.25' RT | STA B 18+87.08, 492.33' RT |
| 25 | 31.47 | 100.00 | 18°01'45" | 15.86 | PRC STA B 17+67.64, 11.25' RT | PT STA B 17+36.53, 14.94' RT | STA B 17+40.46, 84.98' LT |
| 26 | 17.91 | 100.00 | 10°15'36" | 8.98 | PC STA B 17+26.53, 14.04' RT | PRC STA B 17+09.11, 9.98' RT | STA B 17+40.46, 84.98' LT |
| 27 | 18.95 | 90.00 | 12°03'48" | 9.51 | PRC STA B 17+07.15, 11.57' RT | PRC STA B 17+07.29, 30.48' RT | STA B 16+17.72, 21.70' RT |
| 28 | 150.91 | 1260.00 | 6°51'44" | 75.54 | PC STA B 20+85.00, 23.26' LT | PCC STA B 19+30.80, 23.28' LT | STA B 18+24.85, 1281.80' LT |
| 29 | 33.55 | 495.00 | 3°52'59" | 16.78 | PCC STA B 19+30.80, 23.28' LT | PRC STA B 18+96.53, 23.55' LT | STA B 19+21.34, 518.23' LT |
| 30 | 78.25 | 516.00 | 8°41'20" | 39.20 | PRC STA B 18+96.53, 23.55' LT | PCC STA B 18+17.68, 17.39' LT | STA B 18+87.08, 492.33' RT |

| CURVE TABLE | | | | | | | |
|-------------|--------|--------|-----------|---------|-------------------------------|-------------------------------|------------------------------|
| CURVE | LENGTH | RADIUS | DELTA | TANGENT | STATION, OFFSET | STATION, OFFSET | RADIUS POINT STATION, OFFSET |
| 31 | 8.06 | 15.00 | 30°46'17" | 4.13 | PCC STA B 18+17.68, 17.39' LT | PRC STA B 18+10.47, 14.03' LT | STA B 18+20.17, 2.59' LT |
| 32 | 7.62 | 15.00 | 29°06'09" | 3.89 | PRC STA B 18+10.47, 14.03' LT | PRC STA B 18+03.68, 10.75' LT | STA B 18+00.76, 25.47' LT |
| 33 | 25.00 | 512.00 | 2°47'52" | 12.50 | PRC STA B 18+03.68, 10.75' LT | PRC STA B 17+79.28, 5.29' LT | STA B 18+87.08, 492.33' RT |
| 34 | 39.48 | 94.00 | 24°03'48" | 20.03 | PRC STA B 17+79.28, 5.29' LT | PCC STA B 17+40.12, 3.94' LT | STA B 17+56.52, 96.50' LT |
| 35 | 64.63 | 125.00 | 29°37'20" | 33.05 | PCC STA B 17+40.12, 3.94' LT | PRC STA B 16+82.13, 30.80' LT | STA B 17+61.93, 127.02' LT |
| 36 | 74.22 | 66.00 | 64°25'57" | 41.59 | PRC STA B 16+82.13, 30.80' LT | PRC STA B 16+12.36, 39.93' LT | STA B 16+40.00, 20.00' RT |
| 37 | 44.75 | 156.00 | 16°26'10" | 22.53 | PC STA B 18+00.66, 46.96' LT | PRC STA B 17+56.51, 40.66' LT | STA B 18+00.40, 109.04' RT |
| 38 | 75.64 | 90.00 | 48°09'03" | 40.21 | PRC STA B 17+56.51, 40.66' LT | PRC STA B 16+83.75, 50.54' LT | STA B 17+31.18, 127.02' LT |
| 39 | 58.98 | 165.00 | 20°28'50" | 29.81 | PCC STA B 17+49.54, 57.55' RT | PT STA B 18+07.26, 47.09' RT | STA B 18+07.34, 212.09' RT |

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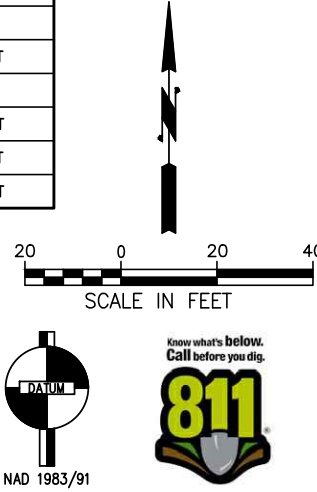
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CARPENTER ROAD/BRITTON PARKWAY
ROUNDAABOUT

ROUNDAABOUT GRADING PLAN

DRAWING NUMBER
G2
SHT 19 OF 64




GENERAL NOTES:


1. SPOT ELEVATIONS LOCATED ON CURB LINES ARE AT FLOWLINE, FACE OF CURB, OR EDGE OF PAVEMENT UNLESS OTHERWISE NOTED.

LEGEND:

- (X) CURVE
--- GRADE BREAK LINE
x 123.45 SPOT ELEVATION, FINISHED GRADE
ME MATCH EXISTING
1/2 1/2 DELTA OF CURVE OR 1/2 POINT ALONG LINE SEGMENT
1/4 1/4 DELTA OF CURVE OR 1/4 POINT ALONG LINE SEGMENT
1/8 1/8 DELTA OF CURVE OR 1/8 POINT ALONG LINE SEGMENT
LP LOW POINT
HP HIGH POINT
---C--- CUT LIMIT
---F--- FILL LIMIT

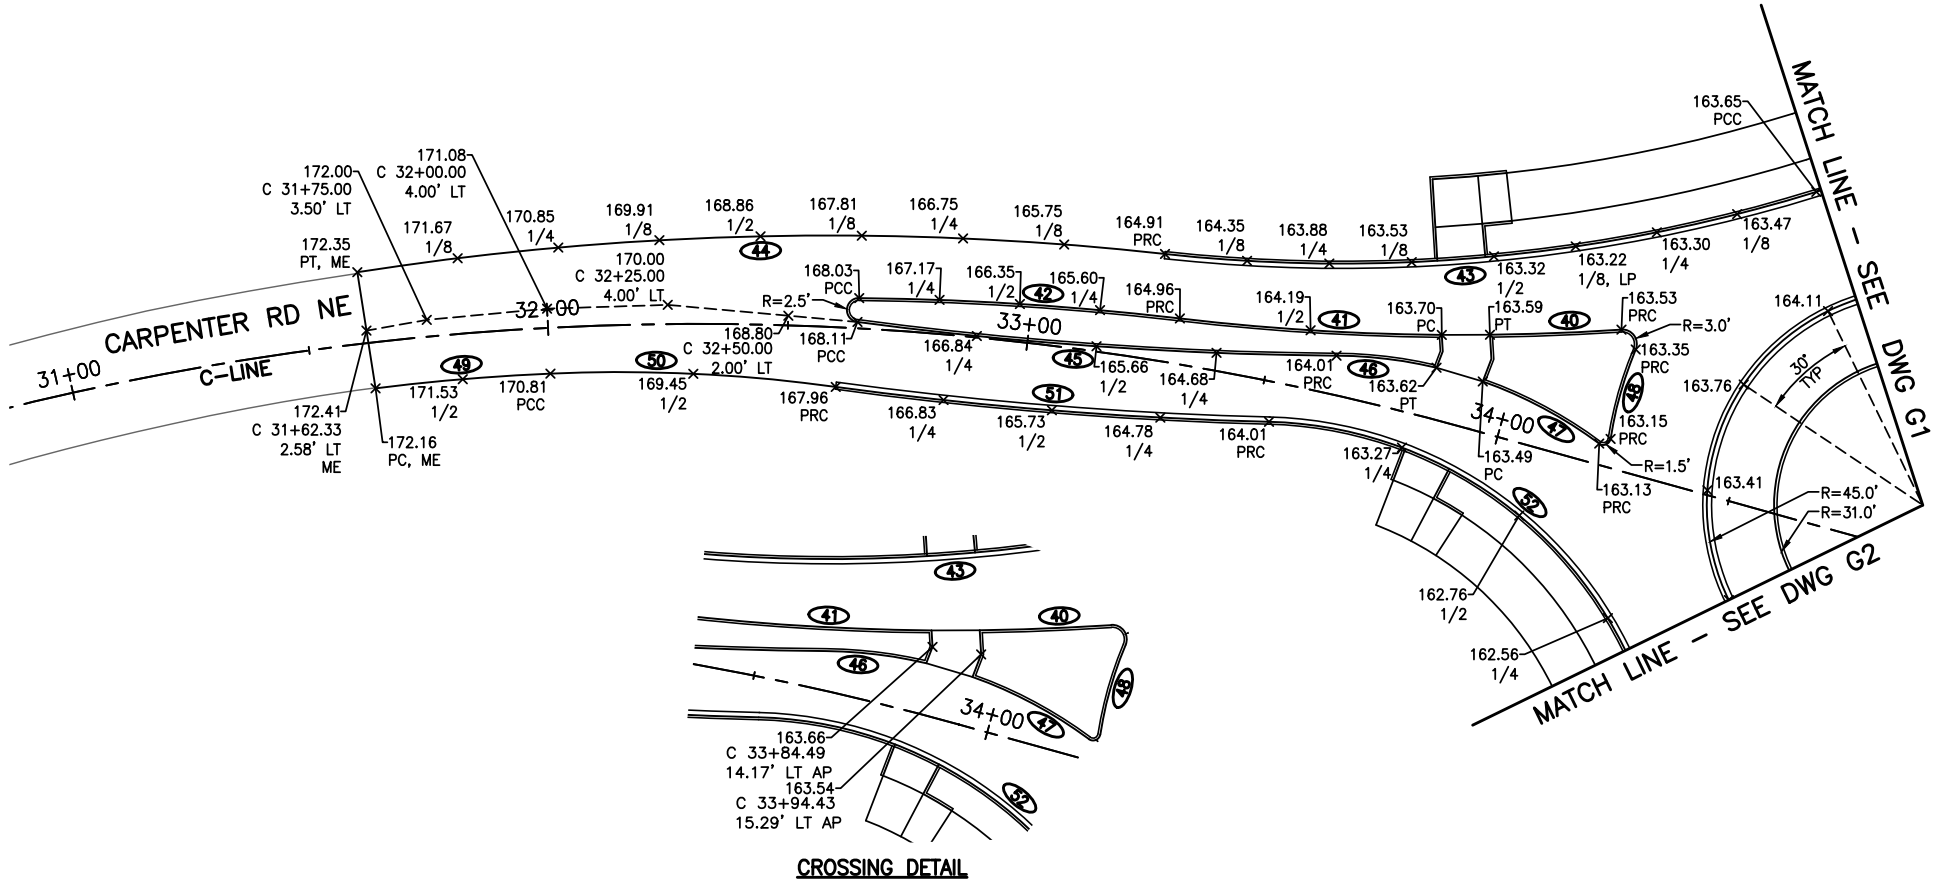

| CURVE TABLE | | | | | | | |
|-------------|--------|--------|-----------|---------|-------------------------------|-------------------------------|------------------------------|
| CURVE | LENGTH | RADIUS | DELTA | TANGENT | STATION, OFFSET | | RADIUS POINT STATION, OFFSET |
| 40 | 27.45 | 501.00 | 3°08'21" | 13.73 | PRC STA C 34+18.93, 28.43' LT | PT STA C 33+92.83, 20.06' LT | STA C 33+17.51, 510.13' LT |
| 41 | 54.69 | 501.00 | 6°15'18" | 27.37 | PC STA C 33+83.45, 17.45' LT | PRC STA C 33+30.54, 9.44' LT | STA C 33+17.51, 510.13' LT |
| 42 | 66.97 | 624.00 | 6°08'58" | 33.52 | PRC STA C 33+30.54, 9.44' LT | PCC STA C 32+64.51, 6.31' LT | STA C 34+25.18, 610.59' RT |
| 43 | 137.29 | 335.00 | 23°28'52" | 69.62 | PCC STA B 15+83.05, 58.82' RT | PRC STA C 33+25.44, 22.21' LT | STA C 33+15.58, 356.97' LT |
| 44 | 168.78 | 637.00 | 15°10'51" | 84.89 | PRC STA C 33+25.44, 22.21' LT | PT STA C 31+61.85, 14.89' LT | STA C 34+25.18, 610.59' RT |
| 45 | 100.11 | 799.00 | 7°10'44" | 50.12 | PCC STA C 32+64.43, 1.32' LT | PRC STA C 33+63.58, 8.10' LT | STA C 32+91.03, 799.28' LT |
| 46 | 21.02 | 93.00 | 12°56'55" | 10.55 | PRC STA C 33+63.58, 8.10' LT | PT STA C 33+84.09, 10.55' LT | STA C 33+86.36, 82.43' RT |
| 47 | 27.59 | 93.00 | 17°00'00" | 13.90 | PC STA C 33+93.95, 10.30' LT | PRC STA C 34+20.78, 4.33' LT | STA C 33+86.36, 82.43' RT |
| 48 | 19.37 | 80.00 | 13°52'34" | 9.73 | PRC STA C 34+22.81, 5.90' LT | PRC STA C 34+22.90, 25.23' LT | STA C 35+02.27, 15.20' LT |
| 49 | 36.58 | 449.00 | 4°40'03" | 18.30 | PC STA C 31+62.83, 9.57' RT | PCC STA C 31+99.99, 9.54' RT | STA C 31+82.93, 458.46' RT |
| 50 | 59.58 | 332.00 | 10°16'58" | 29.87 | PCC STA C 31+99.99, 9.54' RT | PRC STA C 32+60.56, 12.41' RT | STA C 31+93.09, 341.51' RT |
| 51 | 90.60 | 813.00 | 6°23'05" | 45.34 | PRC STA C 32+60.56, 12.41' RT | PRC STA C 33+52.70, 8.32' RT | STA C 32+91.03, 799.28' LT |
| 52 | 113.45 | 85.00 | 76°28'14" | 66.97 | PRC STA C 33+52.70, 8.32' RT | PCC STA B 17+02.73, 59.87' RT | STA C 33+70.42, 91.77' RT |

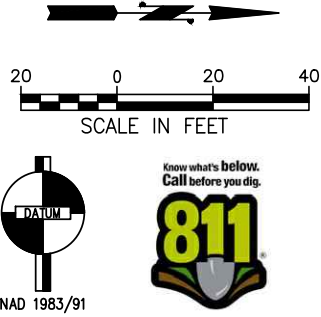

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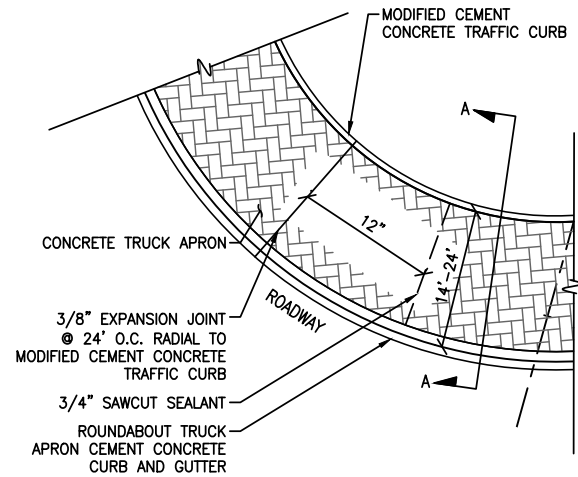


CARPENTER ROAD/BRITTON PARKWAY
ROUNDAABOUT


ROUNDAABOUT GRADING PLAN

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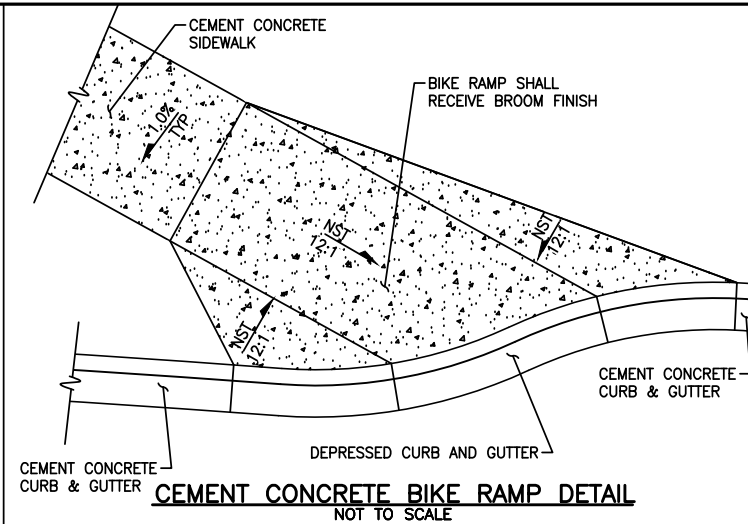
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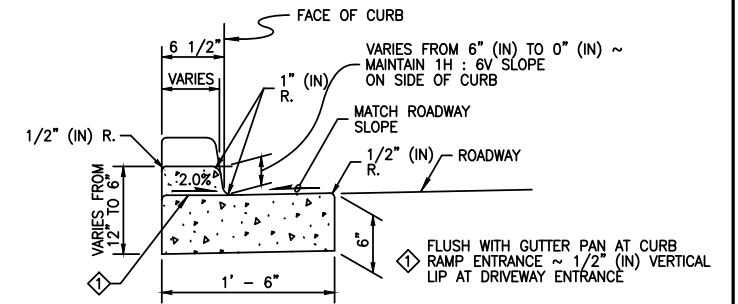
TRUCK APRON PLAN DETAIL
NOT TO SCALE




ROUNDABOUT TRUCK APRON
CEMENT CONCRETE CURB & GUTTER
(ROLLED CURB)
NOT TO SCALE

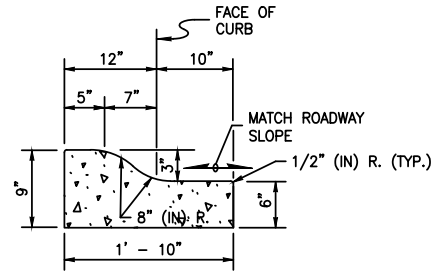


CEMENT CONCRETE BIKE RAMP DETAIL
NOT TO SCALE




DEPRESSED CURB AND GUTTER DETAIL
NOT TO SCALE

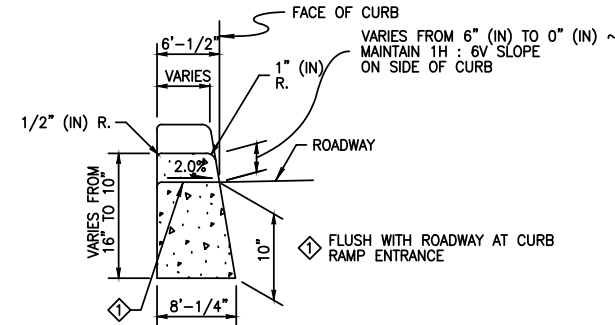


DEPRESSED CURB DETAIL
NOT TO SCALE

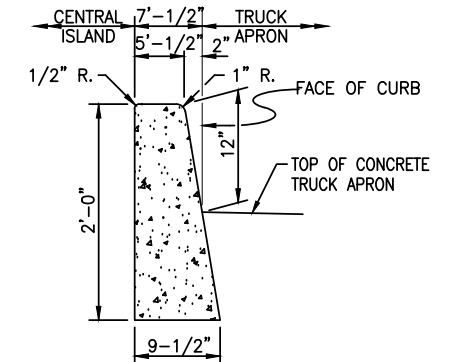


MODIFIED CEMENT CONCRETE TRAFFIC CURB DETAIL
NOT TO SCALE

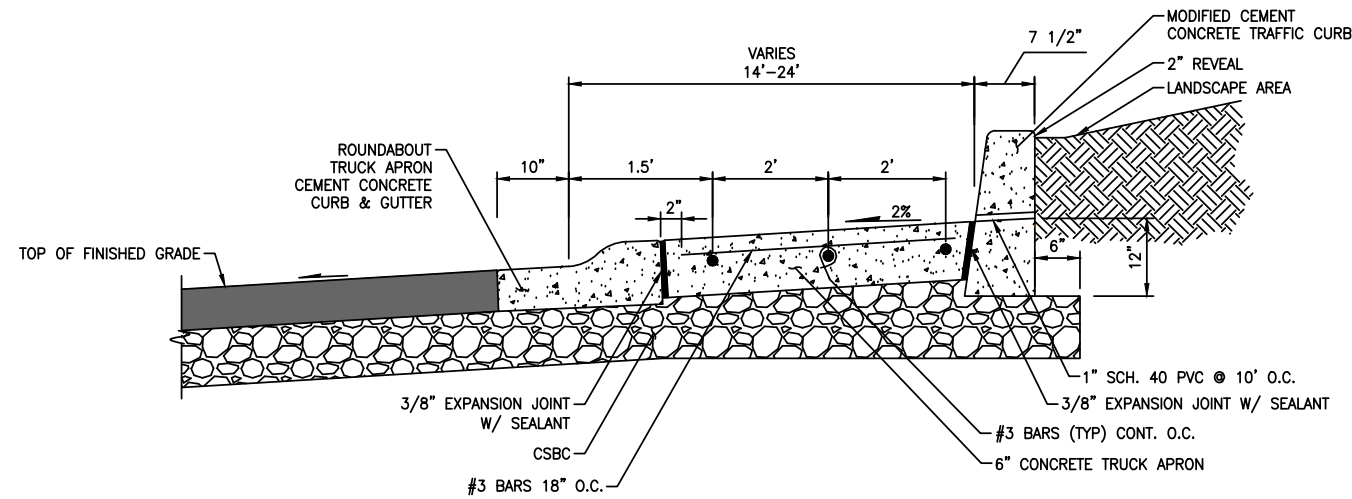


TRUCK APRON CROSS SECTION A-A
NOT TO SCALE

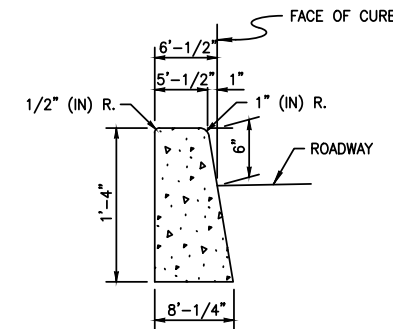


CEMENT CONCRETE TRAFFIC CURB DETAIL
NOT TO SCALE

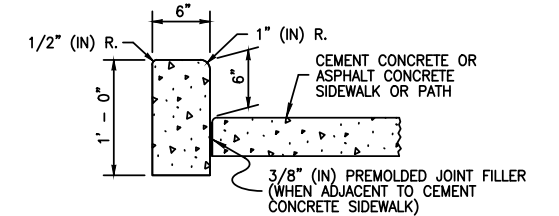

CEMENT CONCRETE
PEDESTRIAN
CURB DETAIL
NOT TO SCALE

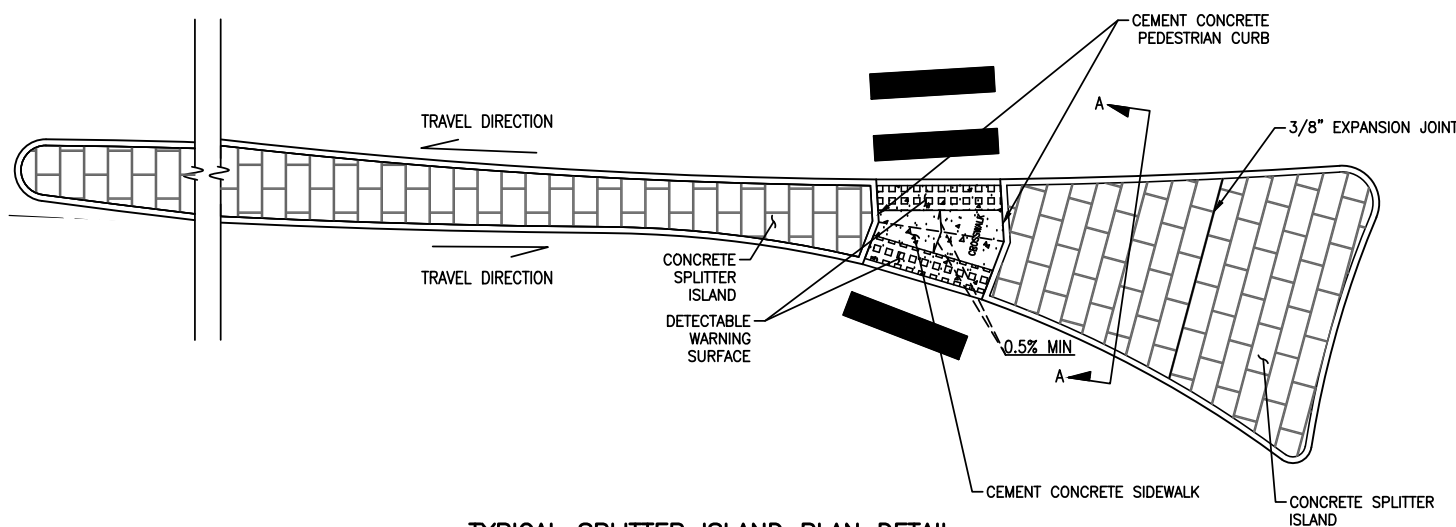

TYPICAL SPLITTER ISLAND PLAN DETAIL
NOT TO SCALE

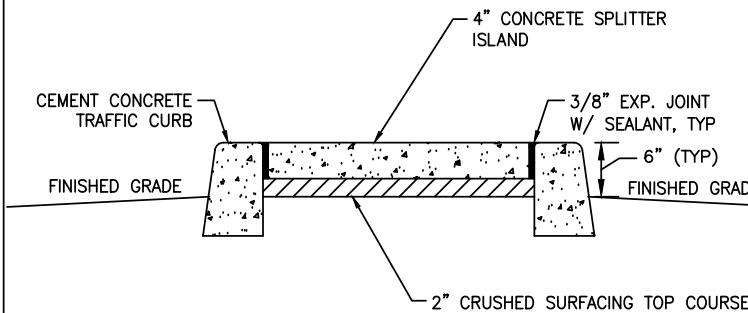

SPLITTER ISLAND CROSS SECTION A-A
NOT TO SCALE

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CARPENTER ROAD/BRITTON PARKWAY
ROUNDABOUT

ROADWAY DETAILS


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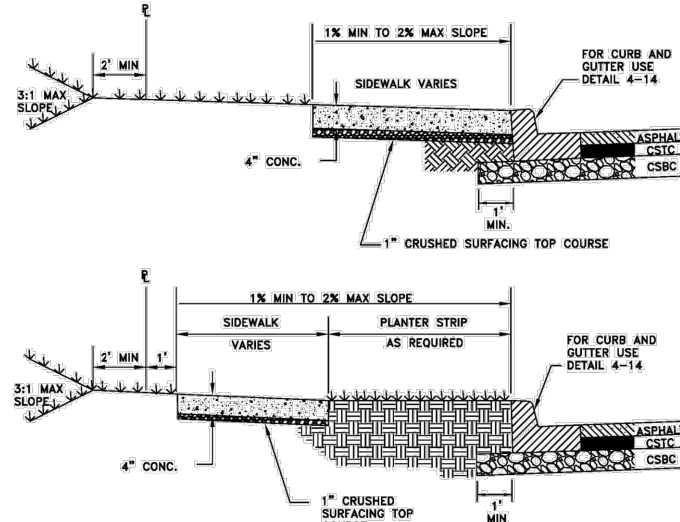


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- GENERAL NOTES:
1. FORMS SHALL BE OF WOOD OR METAL AND SHALL EXTEND FOR THE FULL DEPTH OF THE CONCRETE, SEE SECTION 8-14.3(2).
 2. ALL FORMS SHALL BE STRAIGHT, FREE FROM WARP AND OF SUFFICIENT STRENGTH TO RESIST THE PRESSURE OF THE CONCRETE WITHOUT SPRING.
 3. WHERE D/W EXCEEDS 16' WIDTH A 2" DEEP EXPANSION JOINT SHALL BE PLACED TRANSVERSELY, CENTERED IN WALK.
 4. FORM AND SUBGRADE INSPECTION ARE REQUIRED BEFORE POURING CONCRETE.
 5. DRIVEWAYS SHALL BE 6" THICK. MIN. SIDEWALK AND DRIVEWAY APRON SHALL BE 6" THICK MIN. THROUGH DRIVEWAY SECTION.
 6. SIDEWALK CROSS SLOPE 1% MIN. TO MAX. 2%.


CEMENT CONCRETE DRIVEWAY



- GENERAL NOTES:
1. FORMS SHALL BE WOOD OR METAL AND SHALL EXTEND FOR THE FULL DEPTH OF THE CONCRETE, SEE SECTION 8-14.3(2).
 2. ALL FORMS SHALL BE STRAIGHT, FREE FROM WARP, AND OF SUFFICIENT STRENGTH TO RESIST THE PRESSURE OF THE CONCRETE WITHOUT SPRING.
 3. FOR JOINTS AND SCORING SEE DETAIL 4-10.
 4. CONCRETE DRIVEWAYS REQUIRE A MINIMUM DEPTH OF 6".
 5. SEE ROADWAY SECTIONS FOR STREET TREE LOCATIONS.
 6. THE TOP OR TOE OF ALL SLOPES SHALL BEGIN 2' BACK OF THE SIDEWALK OR THE RIGHT-OF-WAY LINE.
 7. WHEN APPLICABLE THE RIGHT-OF-WAY LINE SHALL BE 1' BEHIND THE SIDEWALK.

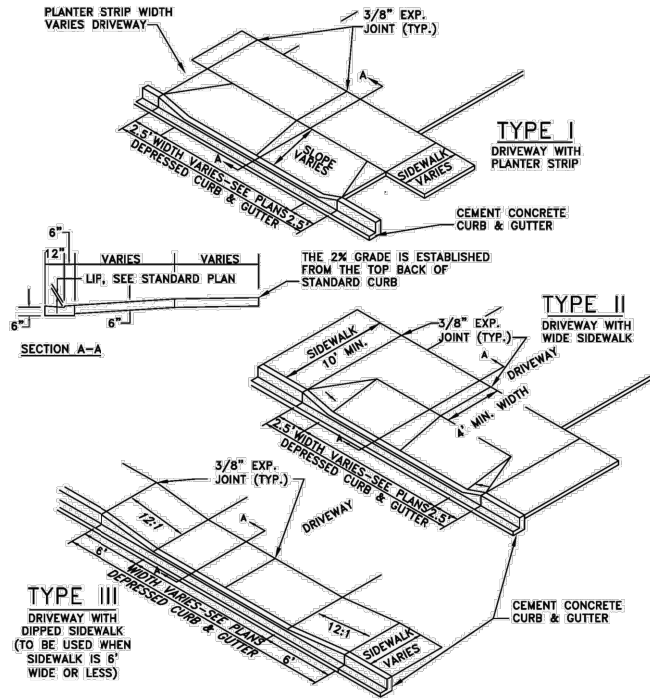
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SIDEWALK

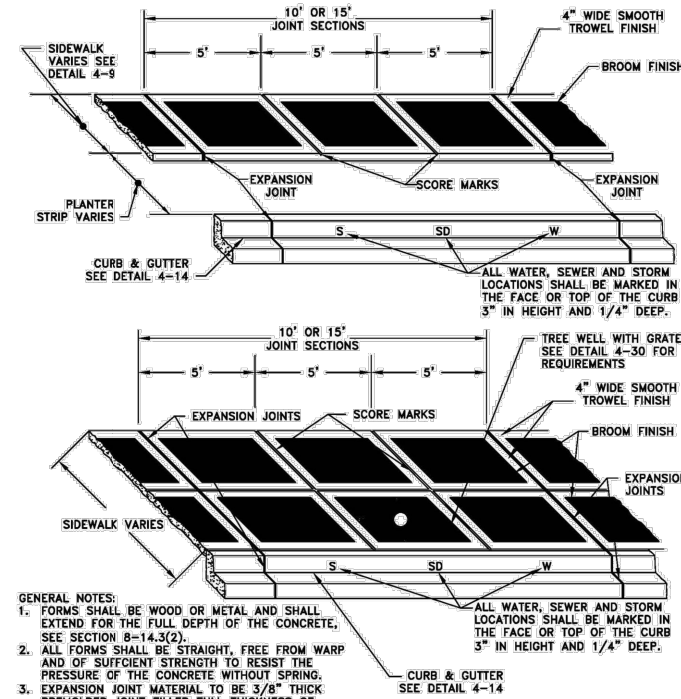


- GENERAL NOTES:
1. FORMS SHALL BE WOOD OR METAL AND SHALL EXTEND FOR THE FULL DEPTH OF THE CONCRETE, SEE SECTION 8-14.3(2).
 2. ALL FORMS SHALL BE STRAIGHT, FREE FROM WARP AND OF SUFFICIENT STRENGTH TO RESIST THE PRESSURE OF THE CONCRETE WITHOUT SPRING.
 3. EXPANSION JOINT MATERIAL TO BE 3/8" THICK PREMOLED JOINT FILLER FULL THICKNESS OF CONCRETE AND INSTALLED FLUSH OR 1/4" BELOW FINISH GRADE.
 4. FORM AND SUBGRADE INSPECTION ARE REQUIRED BEFORE POURING CONCRETE.
 5. PLACEMENT OF STREET LIGHTING, TREES, HYDRANTS AND WATER METERS SHALL BE PER THE DETAILS OF ITS PERSPECTIVE SECTIONS.
 6. SCORE MARKS SHALL BE 1/8" TO 1/4" WIDE AND A MINIMUM OF 1" DEEP.
 7. EXPANSION JOINTS SHALL BE INSTALLED IN THE CURB & GUTTER AND SIDEWALK AT THE PC AND PT FOR ALL CURB RETURNS. EXPANSION JOINTS SHALL BE PLACED IN THE SIDEWALK AT THE SAME LOCATIONS AS THOSE IN THE CURB & GUTTER WHEN THE SIDEWALK IS ADJACENT TO CURB & GUTTER, OR UNLESS OTHERWISE DIRECTED BY THE CITY.


SIDEWALK SPACING
EXPANSION JOINTS & SCORE MARKS

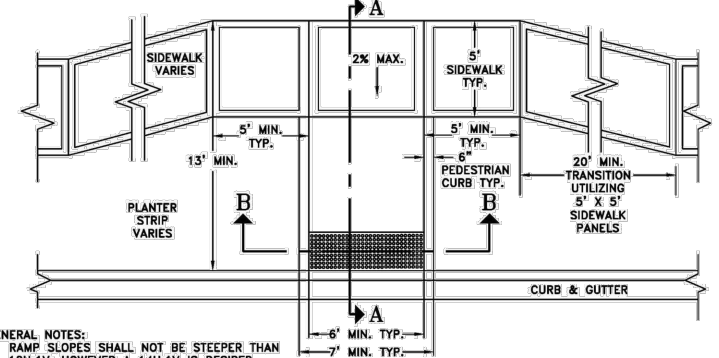

- GENERAL NOTES:
1. RAMP SLOPES SHALL NOT BE STEEPER THAN 12H:1V; HOWEVER A 14H:1V IS DESIRED.
 2. THE RIGHT-OF-WAY LINE SHALL BE 1' BEHIND THE SIDEWALK.
 3. THE CURB RAMP SHALL BE POURED SEPARATE FROM THE SIDEWALK SECTION.
 4. THE TRUNCATED DOME PANELS ARE REQUIRED AS SHOWN AND SHALL BE INSTALLED PER THE MANUFACTURER'S REQUIREMENTS.
 5. STAMPING OF TRUNCATED DOMES SHALL NOT BE ALLOWED.
 6. THE MINIMUM DIMENSIONS FOR THE TRUNCATED DOME PANELS ARE 2' X 3' WITH A MINIMUM OF 2 PANELS AND AN OVERALL LENGTH OF 6'. THE DETECTABLE WARNING PATTERN AREA SHALL BE YELLOW IN COMPLIANCE WITH THE STANDARD SPECIFICATION 8-14.3.
 7. CUTTING OR ALTERING TRUNCATED DOME PANELS SHALL NOT BE ALLOWED.
 8. THERE SHALL BE NO EXPANSION MATERIAL AROUND THE TRUNCATED DOME PANEL.
 9. FOR SIDEWALK SPACING, EXPANSION JOINTS, SCORE MARKS, CRUSHED BEDDING OR ADDITIONAL NOTES SEE DETAILS 4-9 AND 4-10.

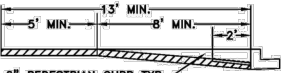


SECTION A-A

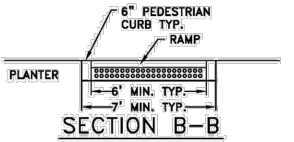

SECTION B-B


CURB RAMP
TYPE III

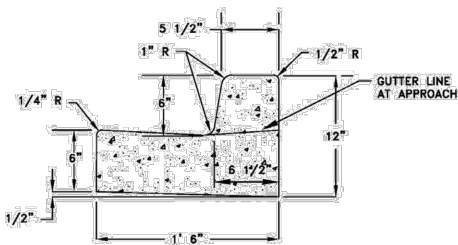

TYPE I

- GENERAL NOTES:
1. EXPANSION JOINT MATERIAL TO BE 3/8" THICK PREMOLED. JOINT FILLER FULL THICKNESS OF CONCRETE SPACING.
 2. FORM AND SUBGRADE INSPECTION REQUIRED BEFORE POURING CONCRETE.
 3. TYPE I USED ON OUTSIDE LANES.
 4. TYPE II USED IN REVERSE SLOPE AREAS.
 5. SEE 48.025 FOR SPECIFICATIONS FOR CURBS AT MEDIANS.


CEMENT CONCRETE CURB & GUTTER

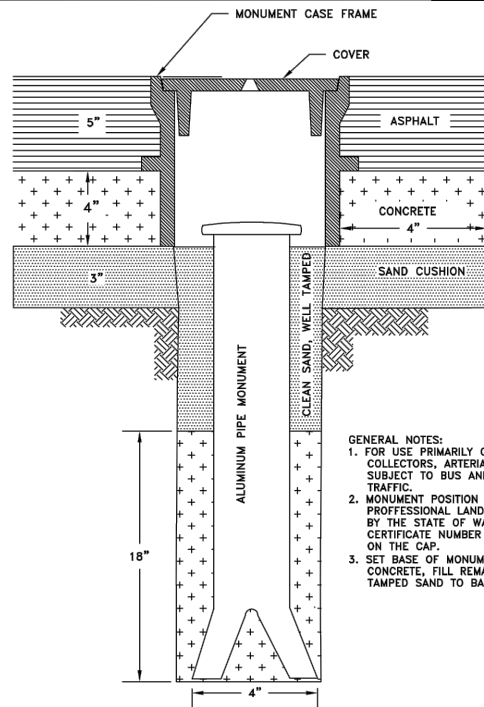


FLARE BOTTOM 3" OF PIPE PRIOR TO INSTALLATION

PIPE MONUMENT & CASE
INSTALLATION

- GENERAL NOTES:
1. FOR USE PRIMARILY ON MAJOR & MINOR COLLECTORS, ARTERIALS, AND STREETS SUBJECT TO BUS AND COMMERCIAL TRUCK TRAFFIC.
 2. MONUMENT POSITION SHALL BE SET BY A PROFESSIONAL LAND SURVEYOR LICENSED BY THE STATE OF WASHINGTON WHOSE CERTIFICATE NUMBER SHALL BE STAMPED ON THE CAP.
 3. SET BASE OF MONUMENT IN 18" OF CONCRETE, FILL REMAINING SPACE WITH TAMPED SAND TO BASE OF CASE FRAME.

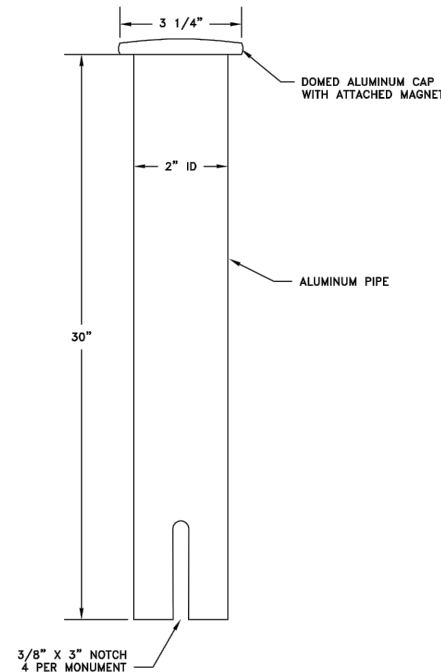

ALUMINUM PIPE
MONUMENT

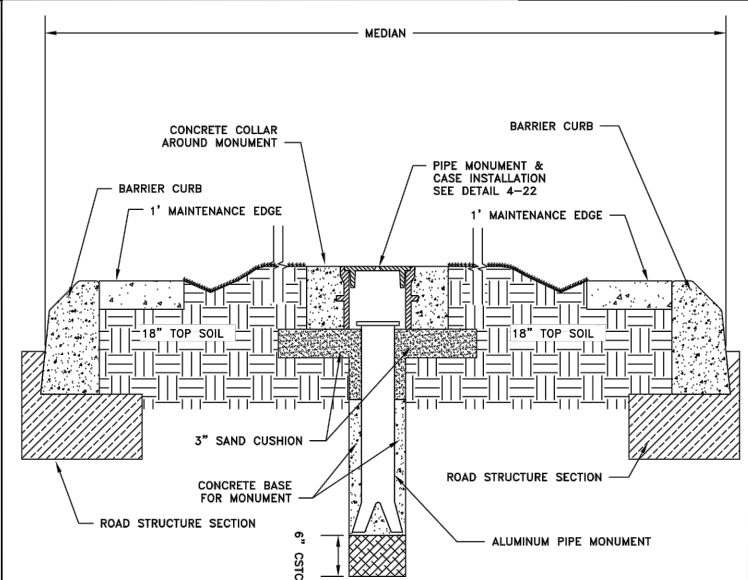

MONUMENT IN MEDIAN




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CARPENTER ROAD/BRITTON PARKWAY
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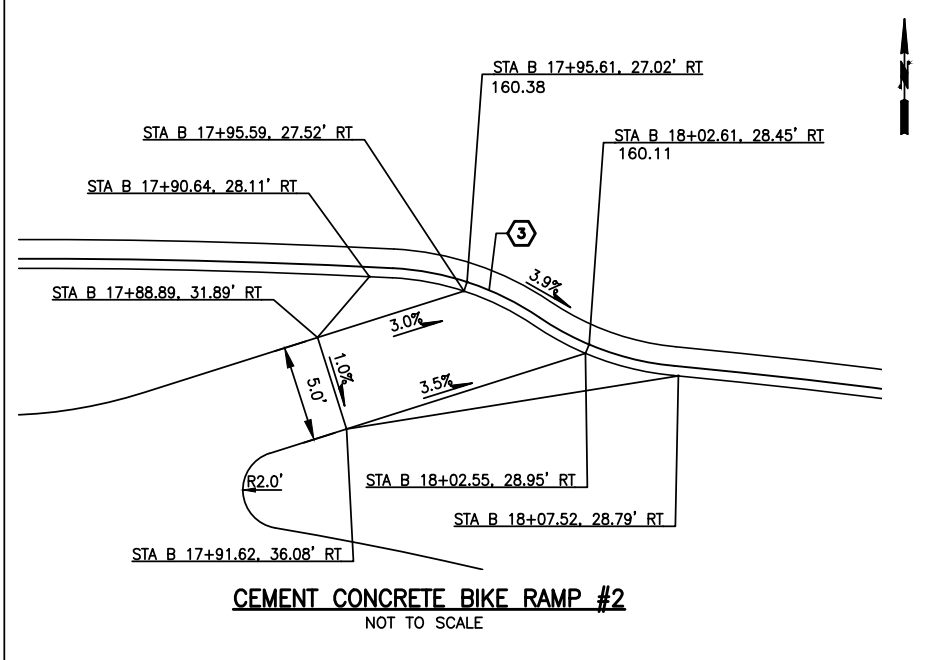
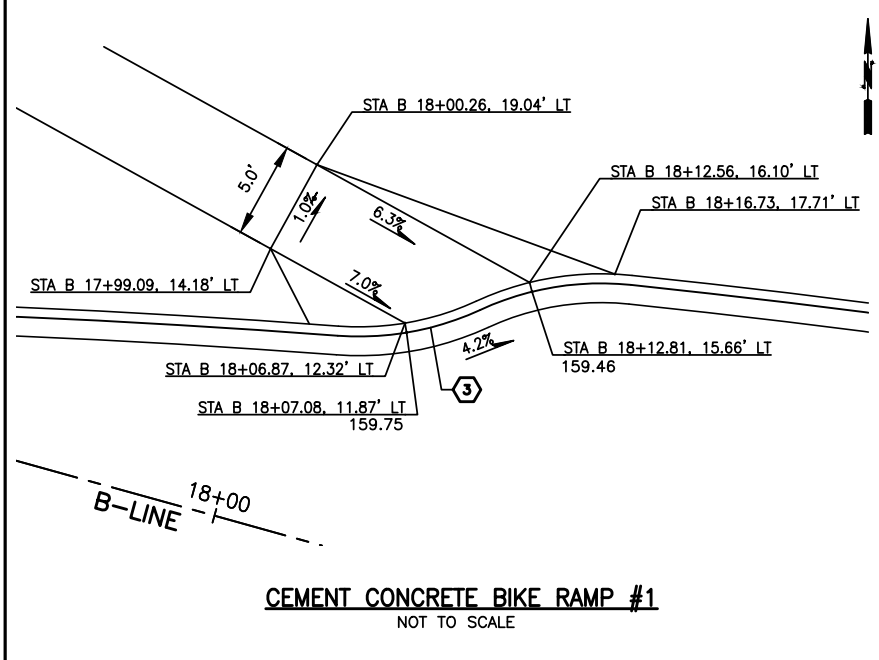
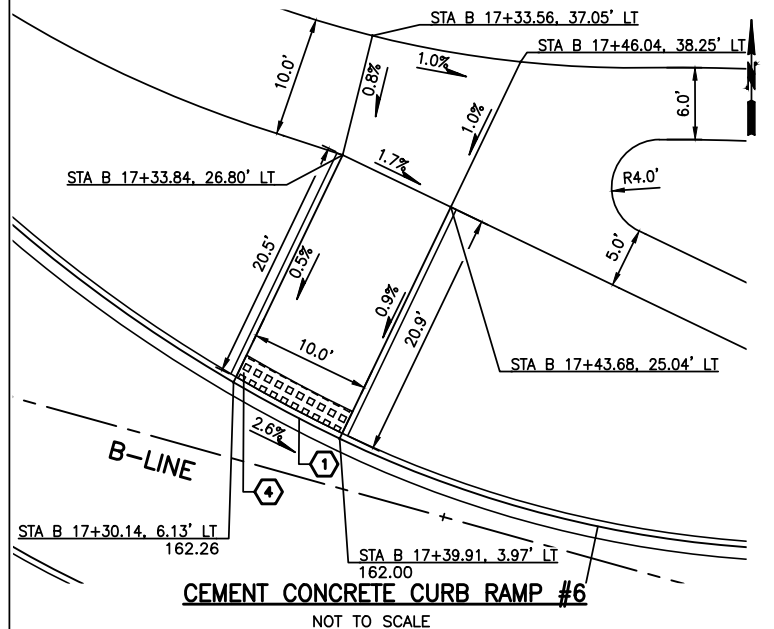
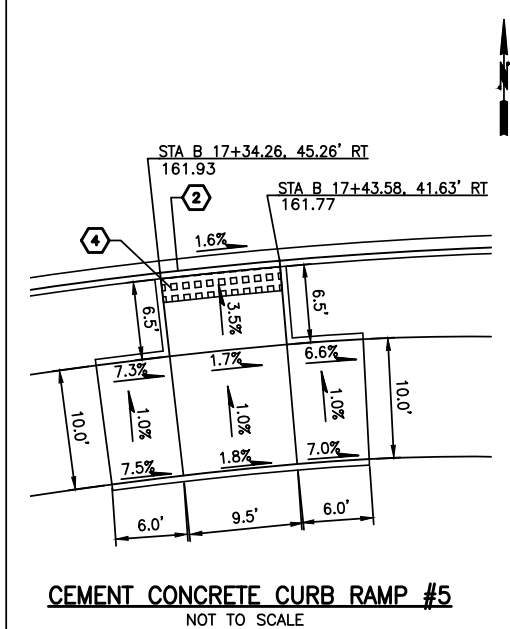
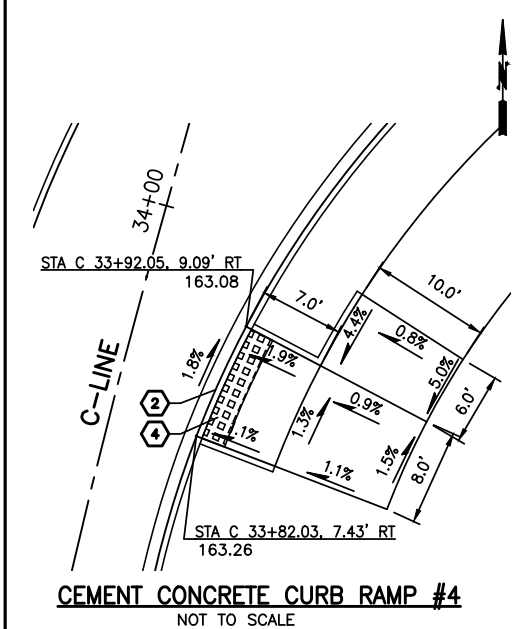
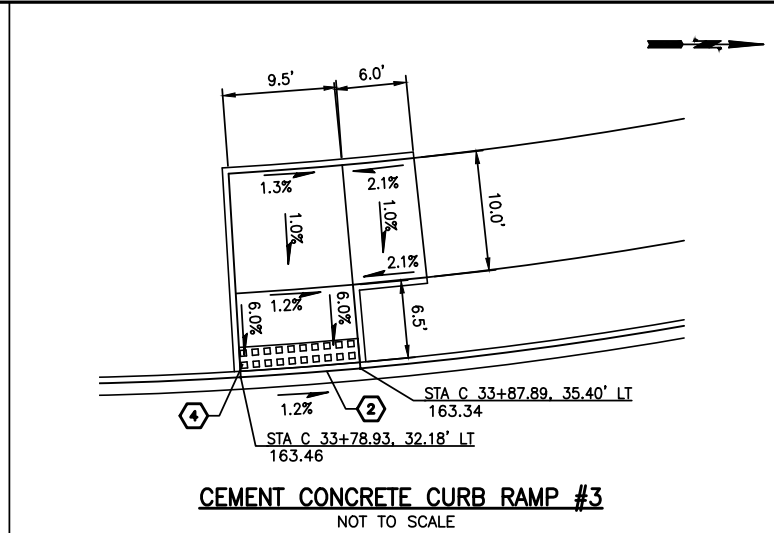
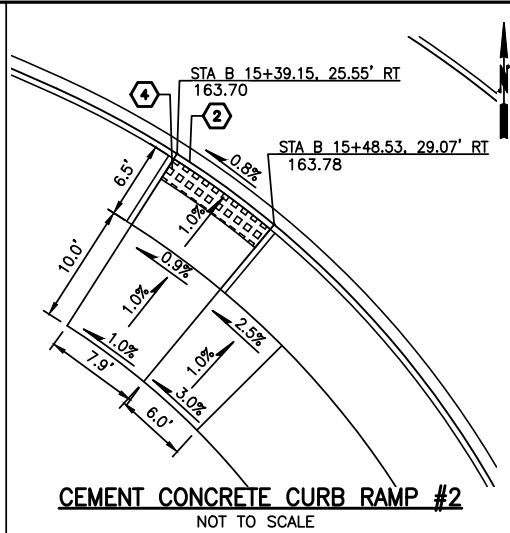
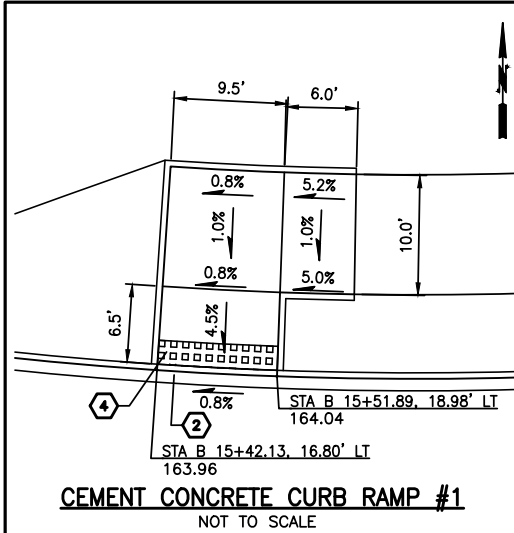
ROADWAY DETAILS

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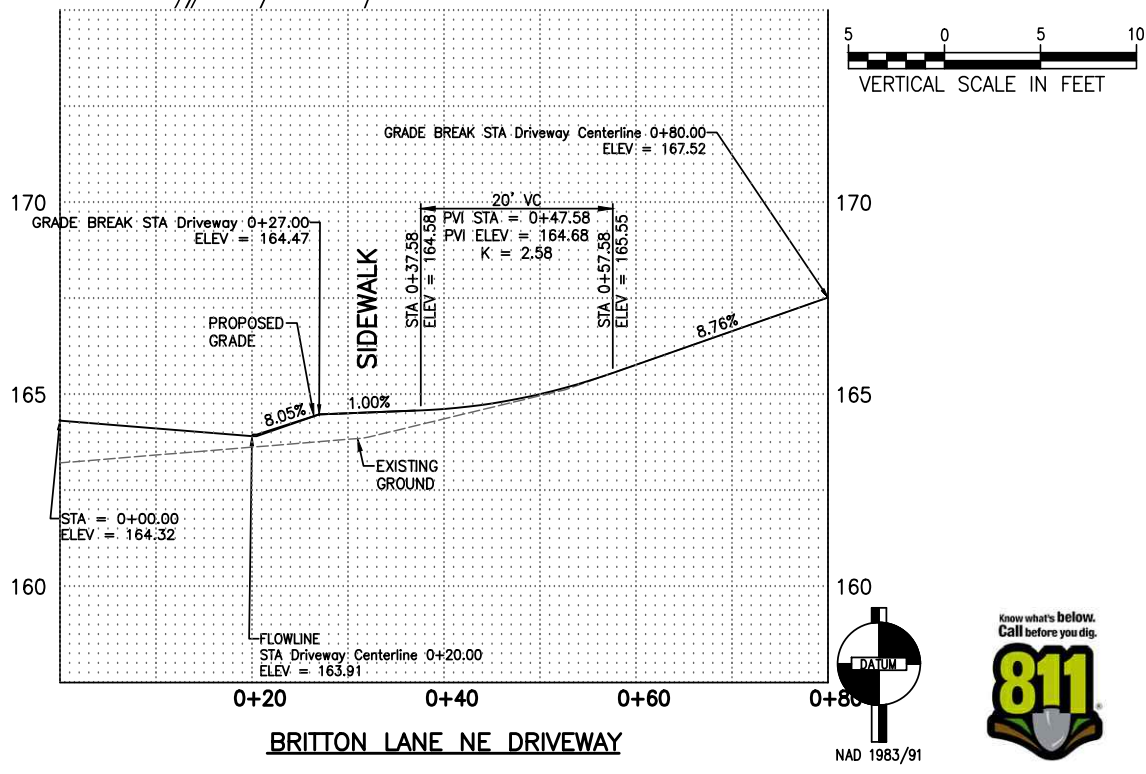
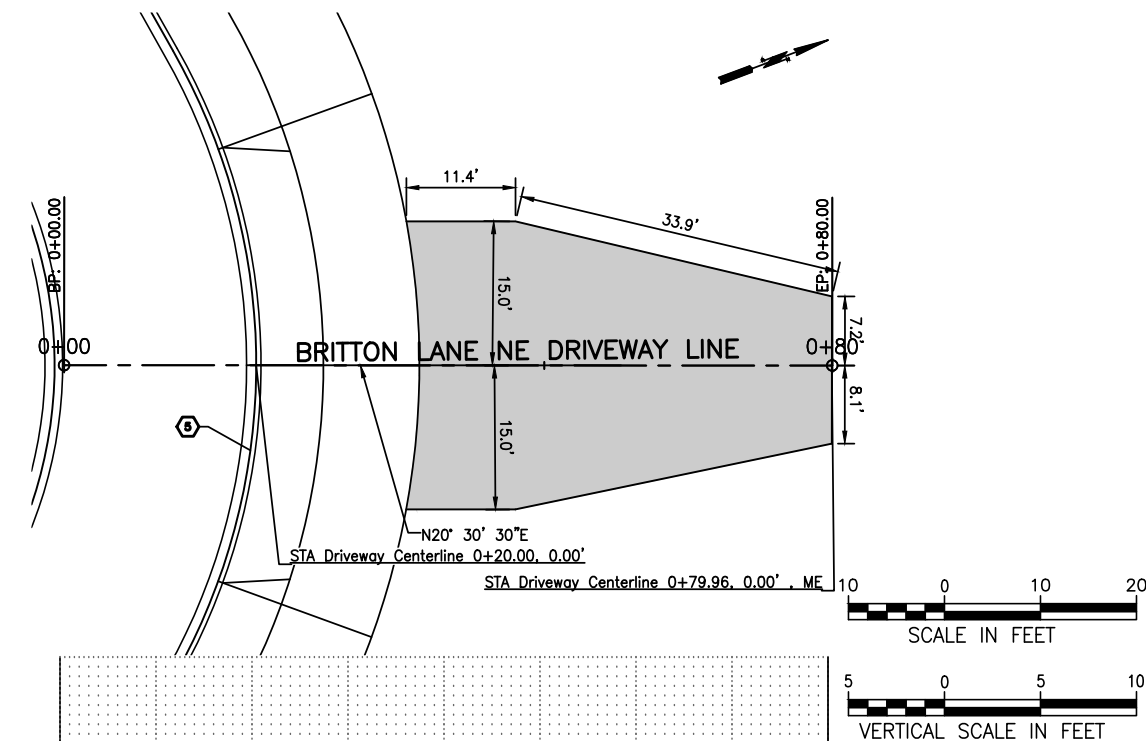
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- CONSTRUCTION NOTES:**
- ① CEMENT CONCRETE CURB RAMP TYPE III
 - ② CEMENT CONCRETE CURB RAMP TYPE COMBINATION
 - ③ CEMENT CONCRETE BIKE RAMP
 - ④ DETECTABLE WARNING SURFACE
 - ⑤ CEMENT CONCRETE DRIVEWAY TYPE I

LEGEND

ASPHALT DRIVEWAY

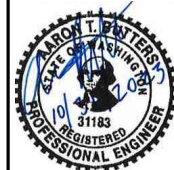

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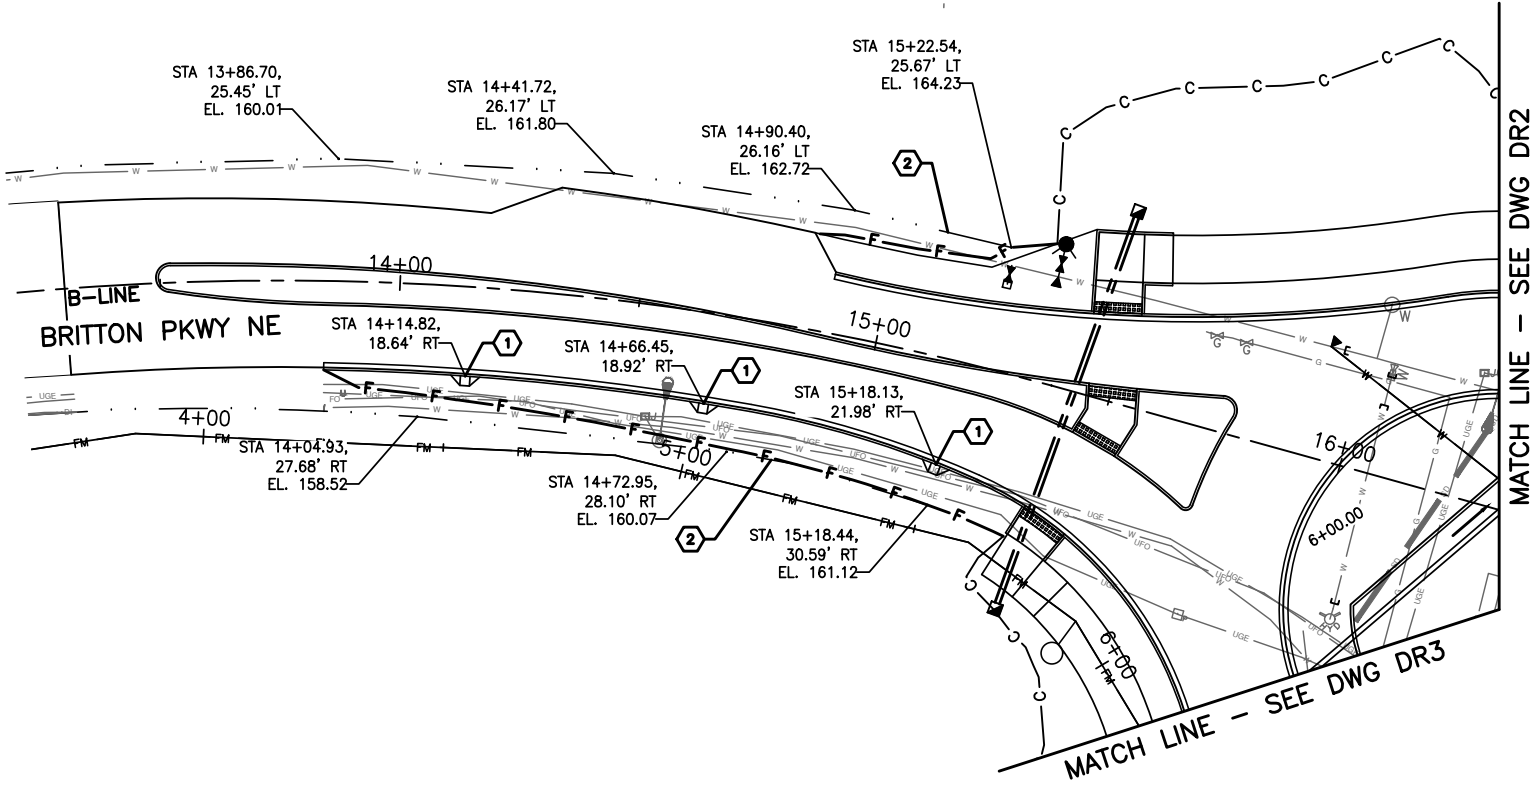


CARPENTER ROAD/BRITTON PARKWAY
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SEC. 10, T.18N., R.1W., W.M.



GENERAL NOTES

1. SEE DWG AL1 FOR ROAD CENTERLINE ALIGNMENT DATA.
2. EXISTING UTILITIES SHOWN ARE APPROXIMATE.
3. TYPE 1 AND 1L CATCH BASINS TO HAVE 2' SUMP DEPTH BELOW LOWEST INVERT ELEVATION.

PROFILE ABBREVIATIONS

EX EXISTING
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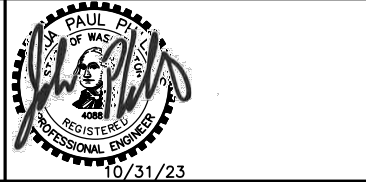
CONSTRUCTION NOTES:

- 1 CONCRETE SCUPPER PER DETAIL
- 2 DRAINAGE DITCH PER TYPICAL DITCH SECTION
- 3 TYPE 1 CATCH BASIN WITH VANED GRATE
- 4 CUT EXISTING STORMDRAIN PIPE AND CONNECT
- 5 TYPE 1 CATCH BASIN WITH CURB INLET GRATE
- 6 TYPE 1L CATCH BASIN WITH CURB INLET GRATE
- 7 STORMDRAIN INLET IN DITCH BOTTOM
- 8 BIOSWALE PER TYPICAL SECTION
- 9 STORMDRAIN OUTLET PER DETAIL
- 10 QUARRY SPALL CHANNEL PROTECTION
- 11 TYPE 1 CATCH BASIN WITH SOLID RECTANGULAR LID
- 12 TYPE 2 CATCH BASIN, 48" DIA. WITH CURB INLET GRATE
- 13 TYPE 1 CATCH BASIN WITH BEEHIVE GRATE PER DETAIL
- 14 TYPE 2 CATCH BASIN, 48" DIA. WITH SOLID RECTANGULAR LID

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CARPENTER ROAD/BRITTON PARKWAY
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DRAINAGE PLAN


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| SWALE COORDINATES | | | |
|-------------------|---|----------|-----------|
| POINT | X | STATION | OFFSET |
| 1 | | 19+47.53 | 30.34' LT |
| 2 | | 20+34.79 | 31.63' LT |
| 3 | | 18+96.36 | 32.02' RT |
| 4 | | 19+43.85 | 32.21' RT |



- GENERAL NOTES**
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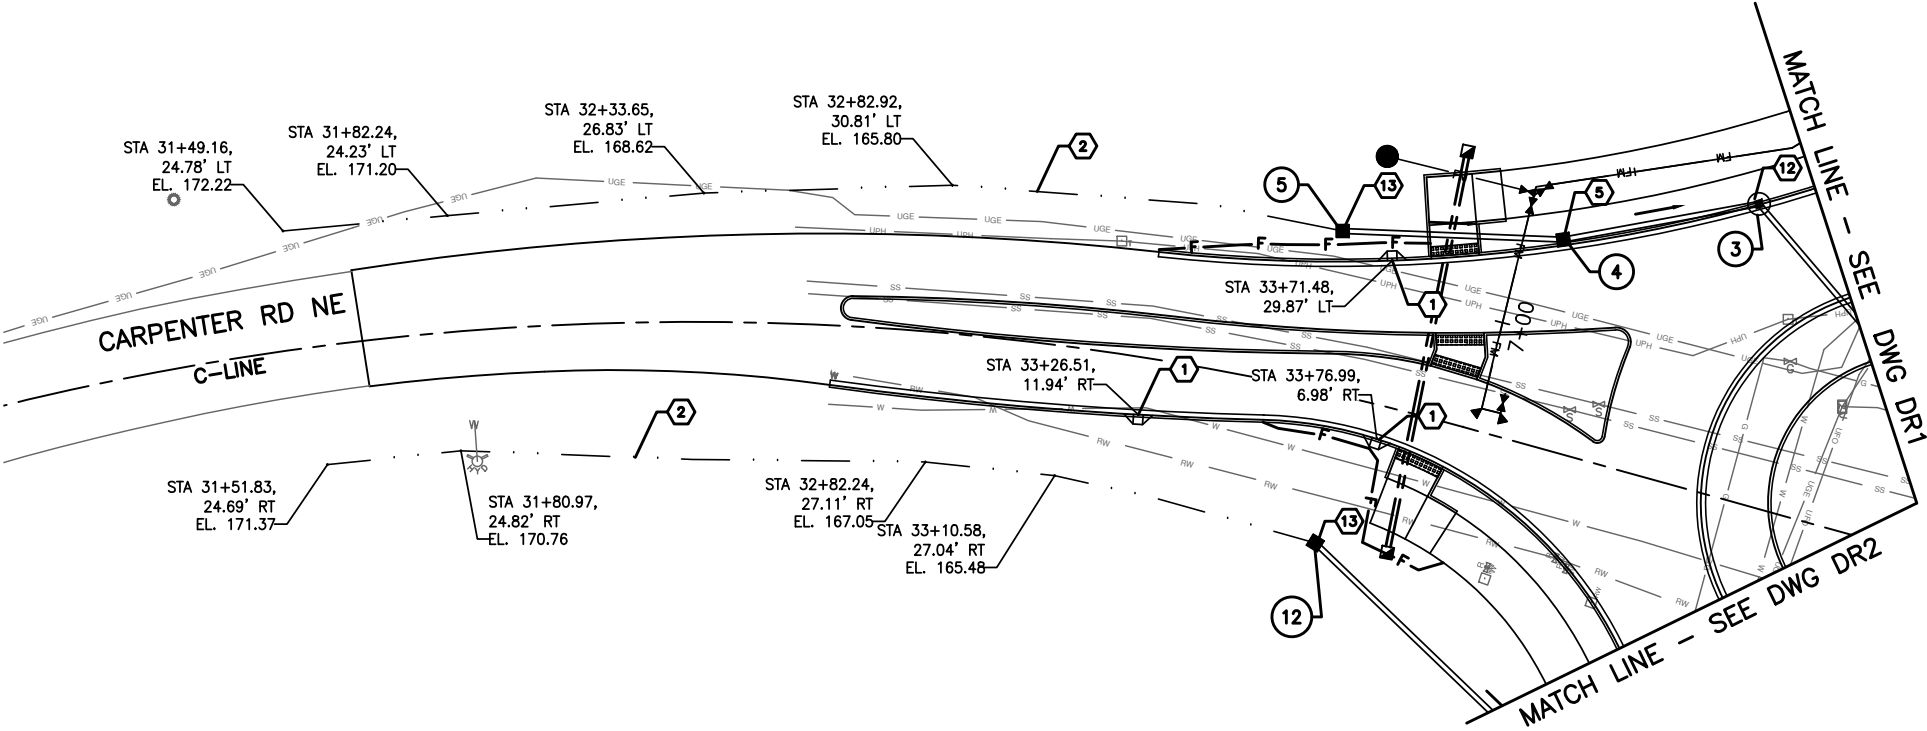
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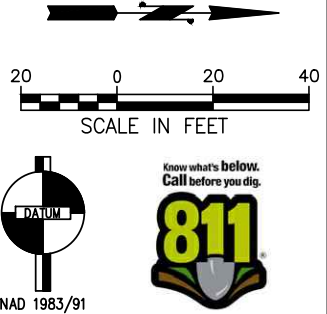
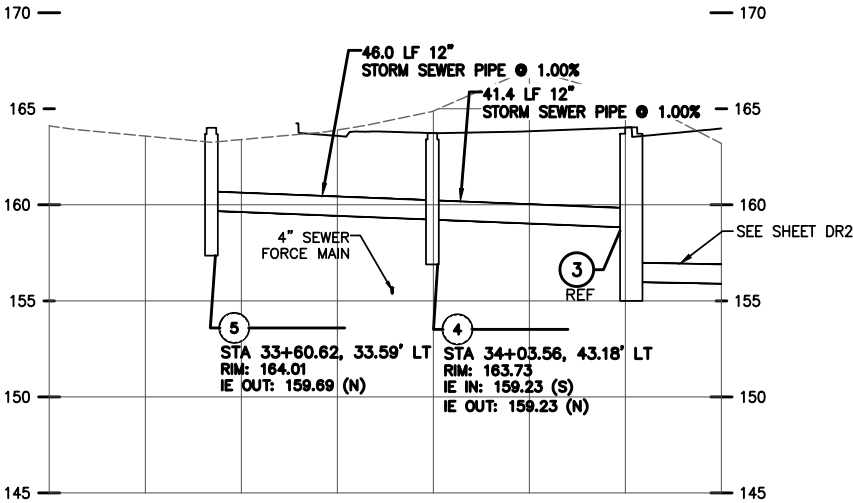
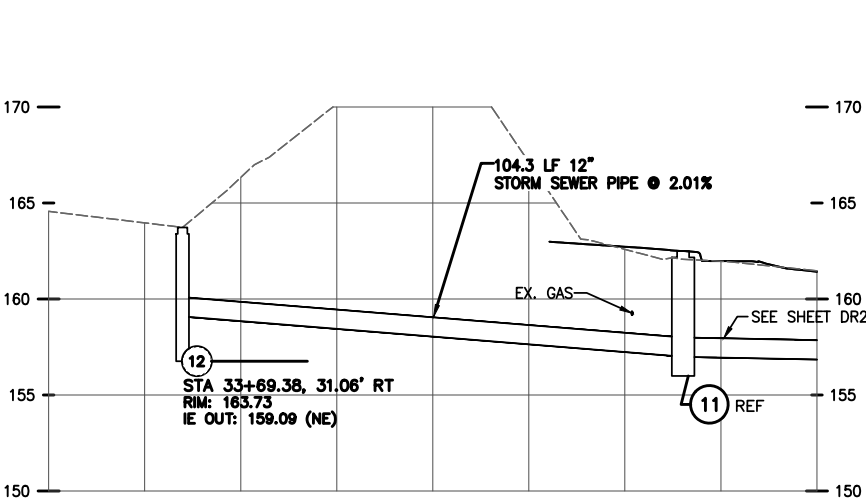
CARPENTER ROAD/BRITTON PARKWAY
ROUNDBABOUT
DRAINAGE PLAN

DRAWING NUMBER
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SHT 25 OF 64

- GENERAL NOTES**
- 1. SEE DWG AL1 FOR ROAD CENTERLINE ALIGNMENT DATA.
 - 2. EXISTING UTILITIES SHOWN ARE APPROXIMATE.
 - 3. TYPE 1 AND 1L CATCH BASINS TO HAVE 2' SUMP DEPTH BELOW LOWEST INVERT ELEVATION.
- PROFILE ABBREVIATIONS**
- EX EXISTING
EX RECLAIMED EXISTING RECLAIMED WATER LINE

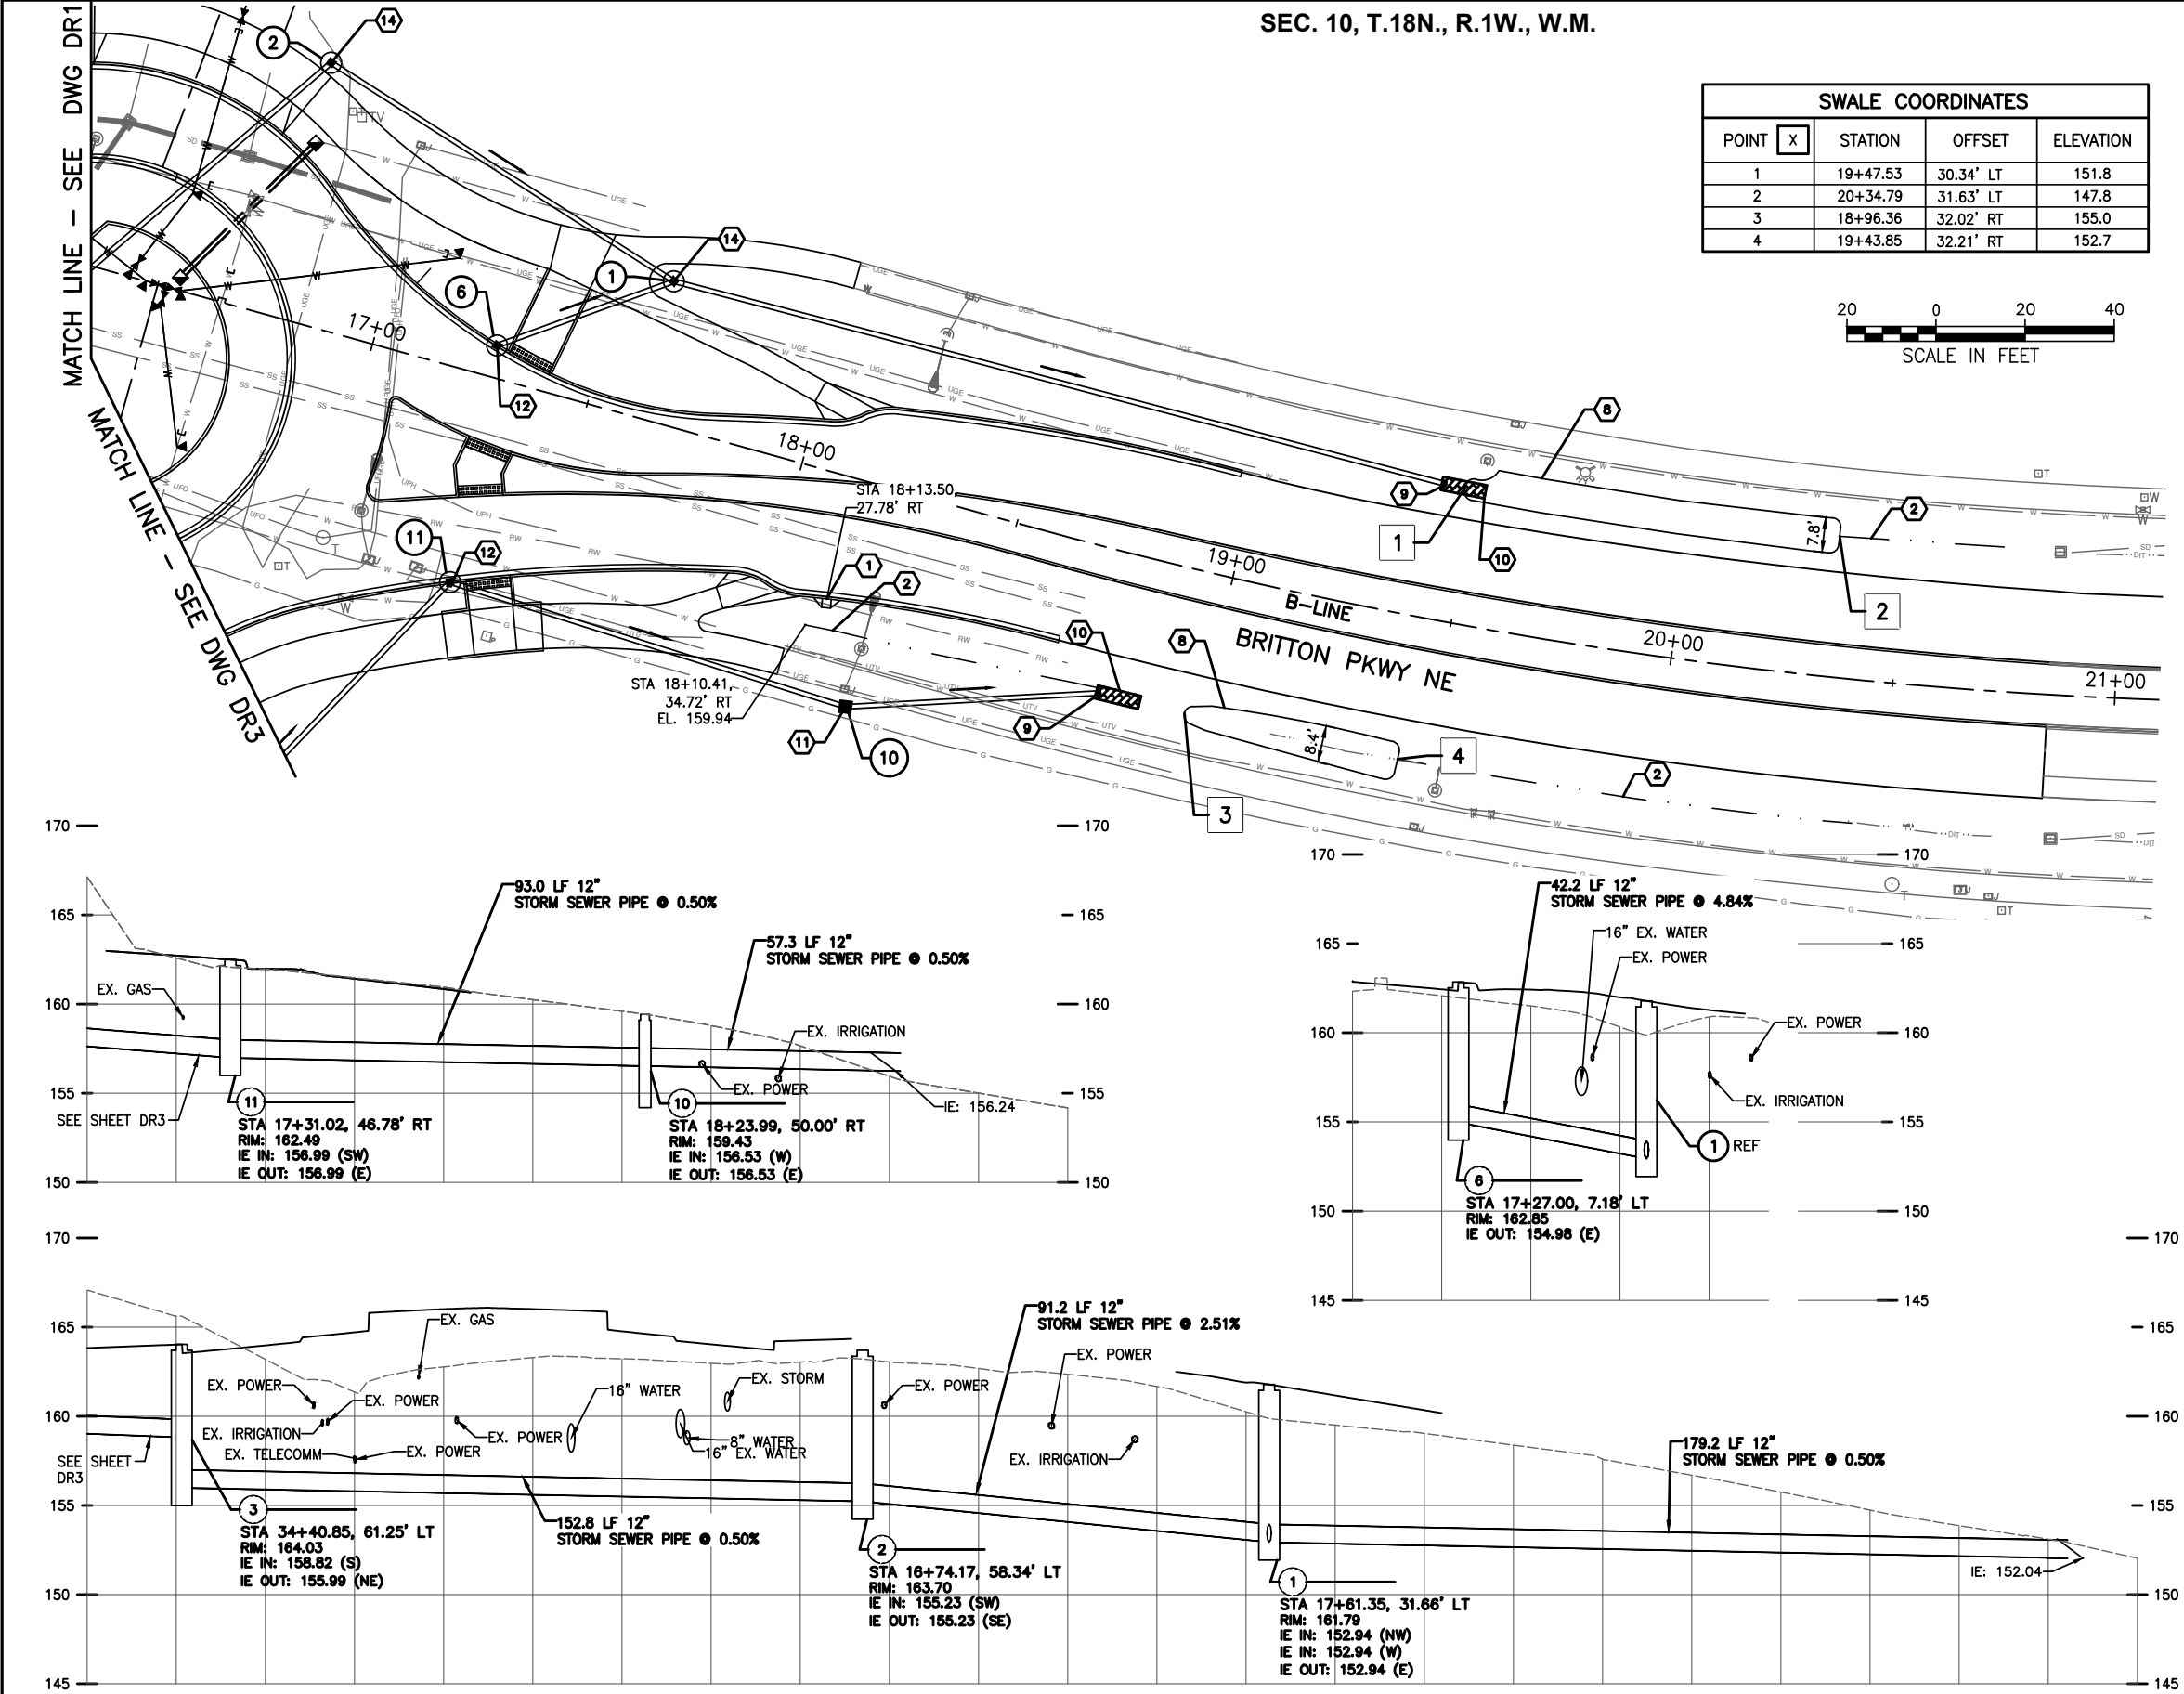

- CONSTRUCTION NOTES:**
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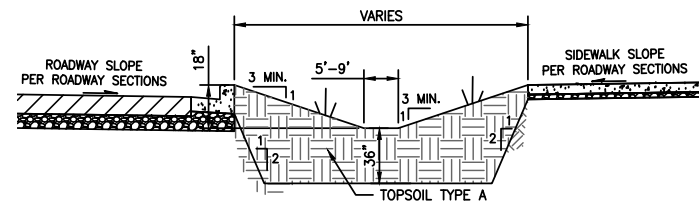
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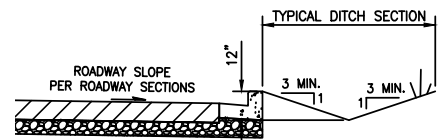
CARPENTER ROAD/BRITTON PARKWAY
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DRAINAGE PLAN

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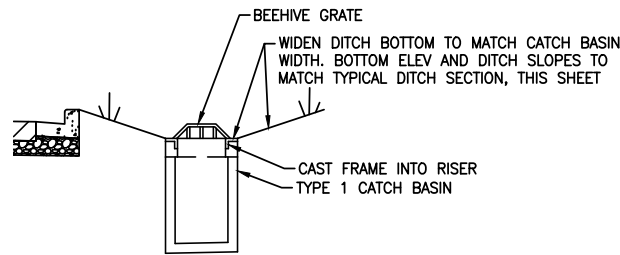
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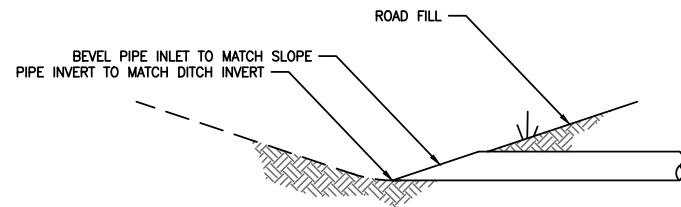
TYPICAL BIOSWALE SECTION
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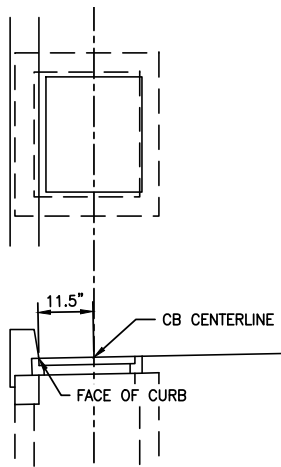
TYPICAL DITCH SECTION
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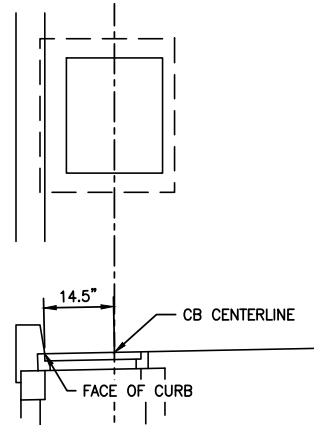
TYPE 1 CATCH BASIN WITH BEEHIVE GRATE
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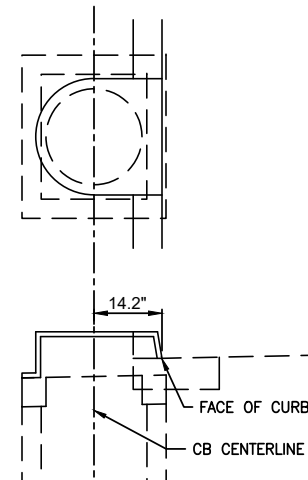
STORMDRAIN INLET DETAIL
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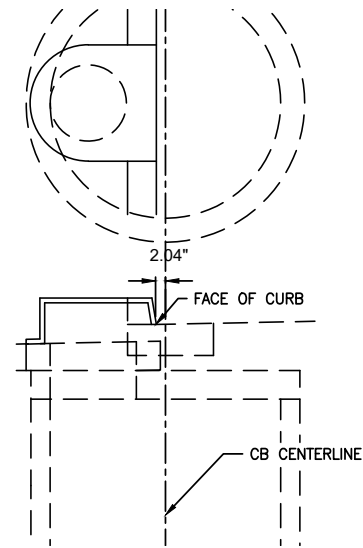
TYPE 1 CATCH BASIN
WITH VANED GRATE



TYPE 1L CATCH BASIN
WITH VANED GRATE




TYPE 1 CATCH BASIN
WITH CURB INLET GRATE




TYPE 2 CATCH BASIN, 48\"/>

TYPICAL CATCH BASIN PLACEMENT
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BIOSWALE TO DITCH TRANSITION SECTION
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STORMDRAIN OUTLET DETAIL
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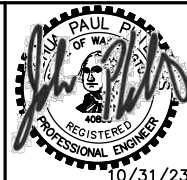
GENERAL NOTES

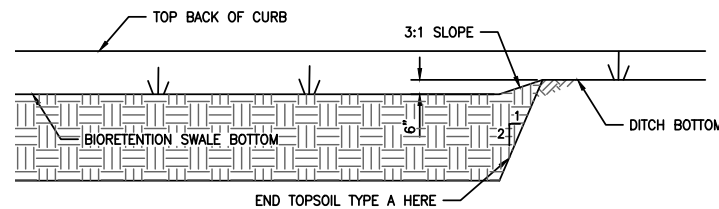1. COMPACTED SOILS IN BIORETENTION SWALES SHALL BE SCARIFIED AT 4 INCHES BELOW THE AMENDED LAYER.
2. CATCH BASIN STATIONING AND OFFSET TO CENTER OF STRUCTURE.

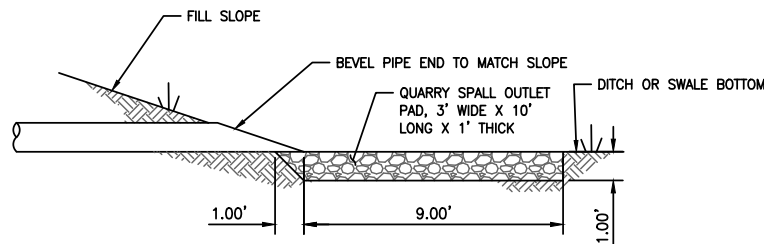

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CARPENTER ROAD/BRITTON PARKWAY
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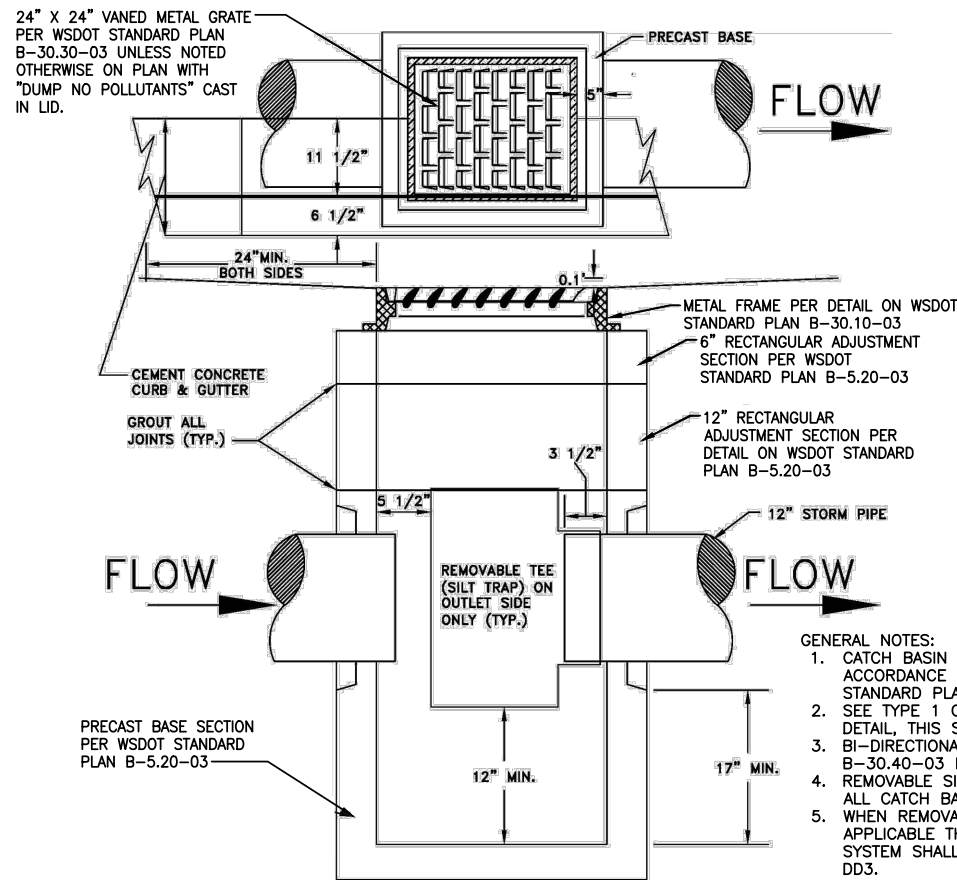
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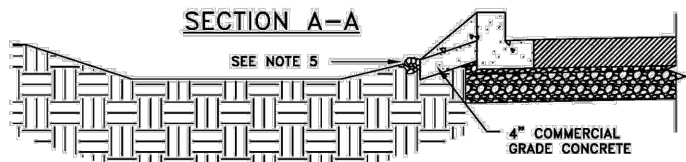
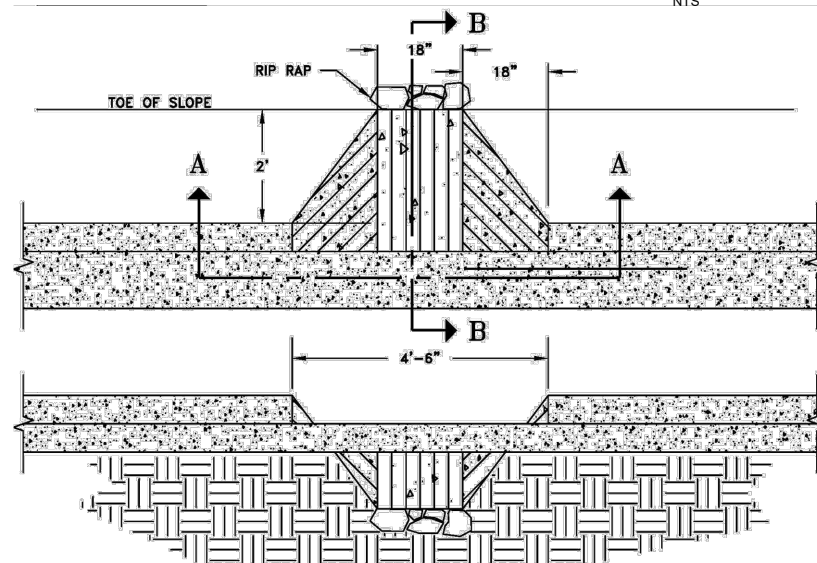
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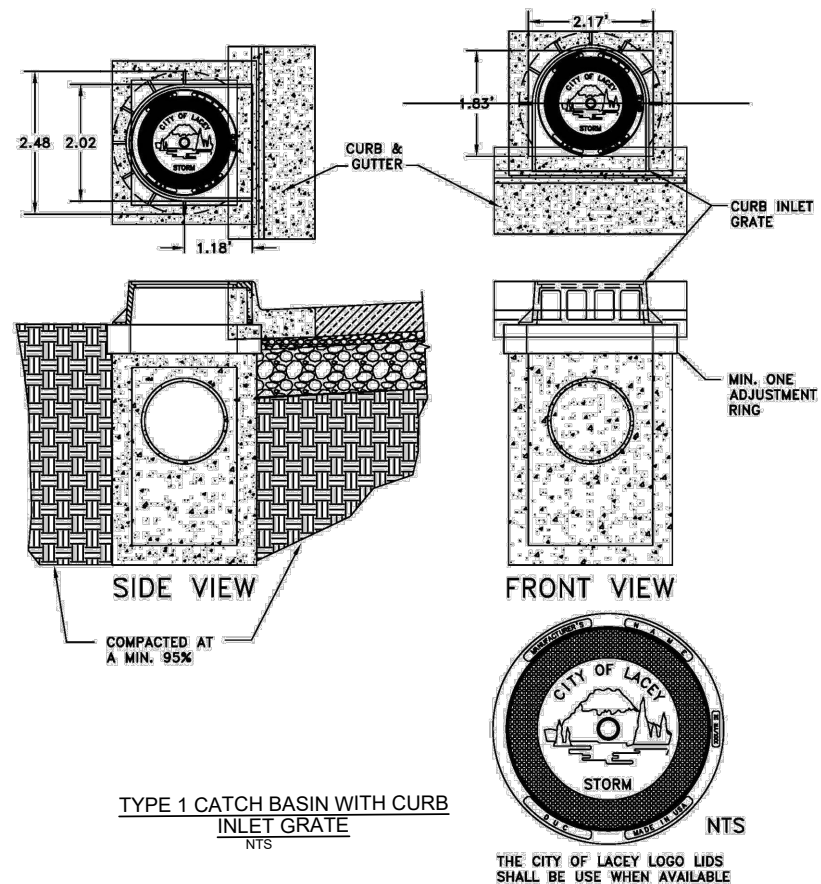


- GENERAL NOTES:
1. CATCH BASIN SHALL BE CONSTRUCTED IN ACCORDANCE WITH SPECIFICATIONS IN WSDOT STANDARD PLANS.
 2. SEE TYPE 1 CATCH BASIN WITH CURB INLET GRATE DETAIL, THIS SHEET, FOR PAD REQUIREMENTS.
 3. BI-DIRECTIONAL VANED PER WSDOT STANDARD PLAN B-30.40-03 IS FOR BI-DIRECTIONAL FLOWS.
 4. REMOVABLE SILT TRAP TEES SHALL BE INSTALLED IN ALL CATCH BASINS.
 5. WHEN REMOVABLE SILT TRAP TEES ARE NOT APPLICABLE THE STORM MANHOLE OUTLET BAFFLE SYSTEM SHALL BE USED PER DETAILS ON SHEET DD3.
 6. WHEN THE ANGLE OF THE STORM PIPE DOES NOT FIT THE KNOCK-OUT THE BASIN SHALL BE UPGRADED. THE CORNERS OF THE BASIN SHALL NOT BE ALTERED OR BROKEN.
 7. SEE DETAIL 5-5 FOR PAD REQUIREMENTS.




CONCRETE SCUPPER
NTS

- GENERAL NOTES:
1. CONCRETE SCUPPER SHALL BE CONSTRUCTED IN ACCORDANCE WITH ASTM C 478 (AASHTO M 199).
 2. THE TOP SURFACE SHALL BE BROOM FINISHED.
 3. ALL EXTERNAL EDGES NOT LABELED SHALL BE TROWELLED WITH 1/4" RADIUS EDGER.
 4. CONCRETE SCUPPERS SHOULD BE SPACED CONSISTENT WITH CATCH BASIN SPACING REQUIRED IN THE STORM WATER MANUAL.
 5. WHERE CONCRETE SCUPPERS ARE USED, APPROXIMATELY 6 INCHES OF ROCK OR OTHER EROSION PROTECTION MATERIAL SHALL BE USED TO DISSIPATE ENERGY AND/OR FLOW DOWN THE CHUTE.
 6. PERVIOUS PAVING MAY BE USED FOR SCUPPER WITH CITY APPROVAL.
 7. THE SLOPE OF THE CHUTE SHALL BE DETERMINED WHEN THE SWALE IS DESIGNED.



- GENERAL NOTES:
1. CONCRETE PADS FOR ALL CURB INLET BASINS SHALL BE A MINIMUM OF 3' X 3' X 8".
 2. ALL STORM MANHOLE LID AND RING ASSEMBLIES SHALL BE EAST JORDAN IRON WORKS OR OLYMPIC FOUNDRY WITH CITY OF LACEY LOGO LIDS WHEN AVAILABLE.
 3. ALL STORM MANHOLE LID AND RING ASSEMBLIES SHALL BE DUCTILE IRON AND MANUFACTURED IN THE USA.
 4. THIS APPLICATION SHALL BE USED FOR INSTALLATIONS ON ARTERIALS AND BOULEVARDS OR WHEN STORM PIPING IS TOO SHALLOW TO MEET THE MINIMUM 2' OF COVER WHERE THE STORM PIPE ENDS UP IN THE ROADWAY STRUCTURE REGARDLESS OF THE TYPE OF PIPE BEING USED.
 5. USE A 2" RECTANGULAR ADJUSTMENT SECTION TURNED LENGTHWISE TO ELIMINATE THE GAP UNDER THE FRAME.

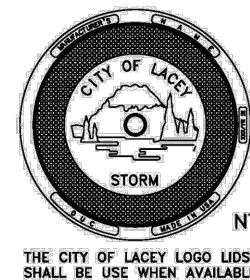


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THE CITY OF LACEY LOGO LIDS SHALL BE USE WHEN AVAILABLE

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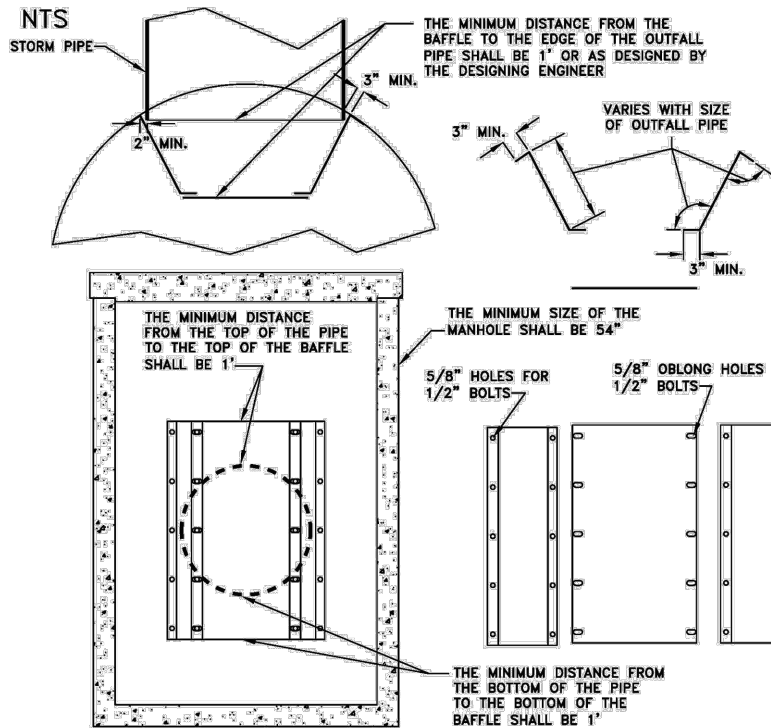
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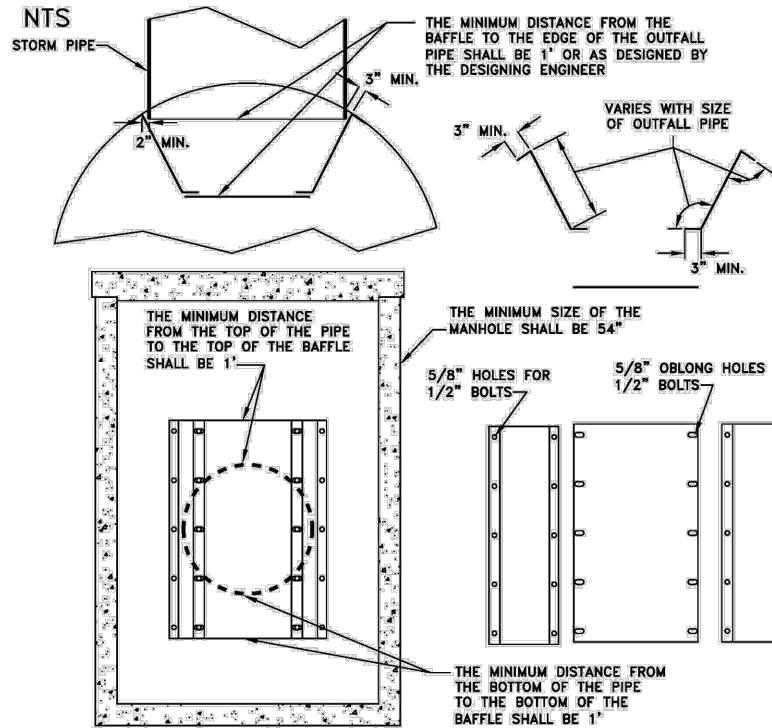
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OPTIONAL STORM MANHOLE OUTLET BAFFLE

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OPTIONAL STORM BAFFLE FOR STORM MANHOLES


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- GENERAL NOTES:
1. THE BAFFLE SYSTEM SHALL BE USED WHEN SILT TRAP TEES CANNOT BE INSTALLED DUE TO SIZE OF STRUCTURES OR WHEN APPROVED BY THE CITY.
 2. ONLY 2 BAFFLES ARE REQUIRED AT THE END OF EACH NEW RUN OR MAIN LINE SYSTEM. THE MINIMUM SIZE OF THE STRUCTURES FOR THE BAFFLES SHALL BE 54". LARGER MANHOLES SHALL BE DETERMINED BY THE SIZE OF THE PIPE(S).
 3. THERE SHALL BE A MIN. OF 3 PIECES AND SHALL BE MANUFACTURED TO FIT THROUGH A 24" MANHOLE FRAME.
 4. ALL MATERIALS SHALL BE STAINLESS STEEL. THE PANEL THICKNESS SHALL BE 1/8".
 5. SEALANT SHALL BE APPLIED TO ALL JOINTS TO PREVENT GAPS IN BAFFLE.
 6. THE CITY OF LACEY SHALL DETERMINE IF OTHER STRUCTURES ARE REQUIRED.
 7. THE DESIGN AND RESTRICTION CALCULATION SHALL BE DONE BY THE DESIGNING ENGINEER.
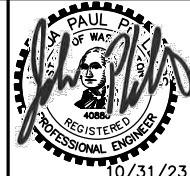
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NOTES

1. See **Standard Specifications Section 7-08.3(3)** for Pipe Zone Backfill.
2. See **Standard Specifications Section 9-03.12(3)** for Gravel Backfill for Pipe Zone Bedding.
3. See **Standard Specifications Section 2-09.4** for Measurement of Trench Width.
4. For sanitary sewer installation, concrete pipe shall be bedded to spring line.



THERMOPLASTIC PIPE

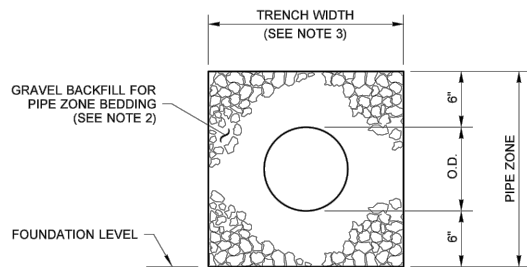
TYPICAL PIPE TRENCH PER WSDOT STANDARD PLAN B-55.20-02

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CARPENTER ROAD/BRITTON PARKWAY
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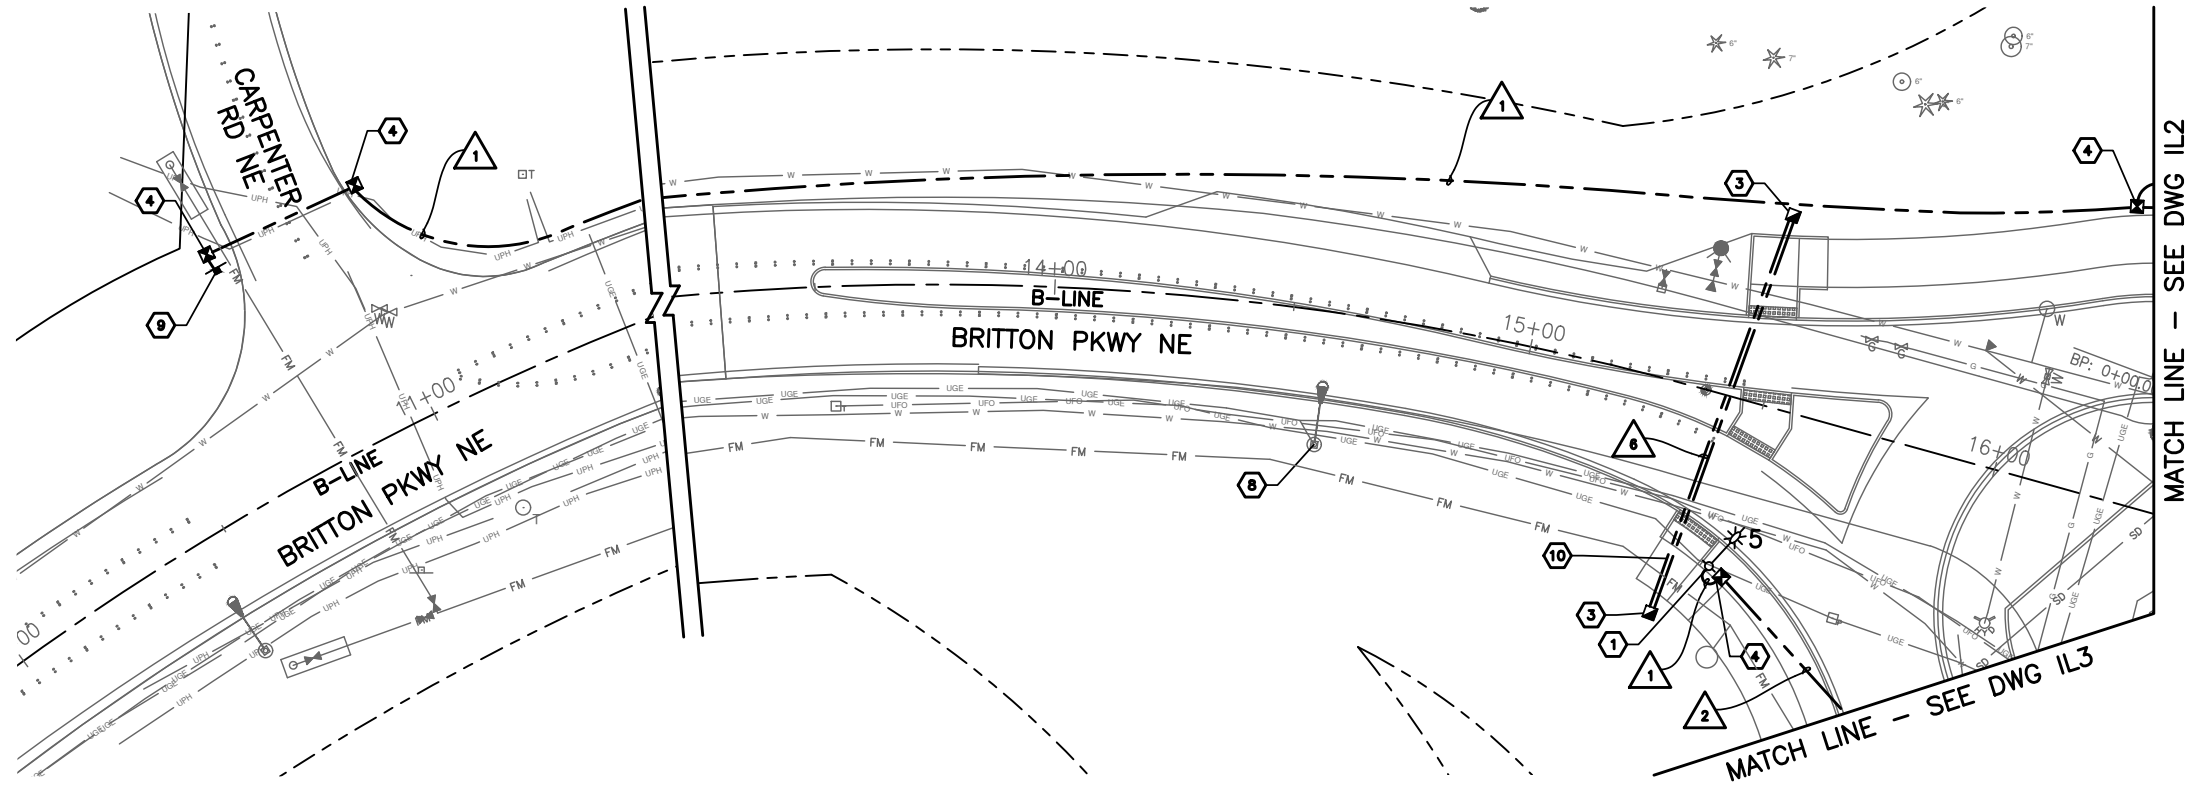
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CONSTRUCTION NOTES:

- 1 INSTALL FOUNDATION AND 40' LIGHT STANDARD WITH 6-FOOT MASTARM AND 180W LED LUMINAIRE
- 2 INSTALL TYPE 8 JUNCTION BOX
- 3 TYPE 2 JUNCTION BOX
- 4 INSTALL TYPE 1 JUNCTION BOX
- 5 INSTALL FOUNDATION AND RELOCATE EXISTING SERVICE CABINET TO STA B 17+49.6, 62.5 RT. CONTACT UTILITY COMPANY FOR POWER SUPPLY EXTENSION.
- 6 INTERCEPT EXISTING CONDUITS AND CONNECT EXISTING CONDUITS.
- 7 REMOVE EXISTING LIGHT POLE AND POLE FOUNDATION
- 8 EXISTING LIGHT POLE TO REMAIN
- 9 REMOVE EXISTING STOP SIGN. INSTALL STOP SIGN WITH LED LIGHTS (36"x36")
- 10 TWO PARALLEL 4" CONDUITS

LEGEND

- EXISTING JUNCTION BOX
- JUNCTION BOX (TYPE 1, 2, 8)
- EXISTING STREET LIGHT ASSEMBLY
- PROPOSED STREET LIGHT ASSEMBLY
- ELECTRICAL CONDUIT
- ELECTRICAL SERVICE

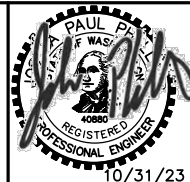EXISTING SERVICE
STA B 14+49.6 62.5RT


| BREAKER SCHEDULE | | | | |
|--------------------|-------------------|---------------------|-----------------|-------|
| SERVICE & CIRCUITS | MAIN BREAKER AMPS | BRANCH BREAKER AMPS | CONTRACTOR AMPS | VOLTS |
| SERVICE | EXISTING | | | 240 |
| SIGNAL | | NA | NA | |
| CONTROL & GFR | | EX | NA | 120 |
| EX CIRCUIT | | EX | NA | 240 |
| EX CIRCUIT | | EX | NA | 240 |
| CIRCUIT C | | 20 | 30 | 240 |
| SIGN | | 20 | 20 | 120 |

WIRING SCHEDULE

| RUN NO. | CONDUIT SIZE | WIRE/CABLE | | | | REMARKS |
|---------|--------------|------------|--------|--------|------------------|-------------------------------|
| | | #2 AWG | #6 AWG | #8 AWG | BARE GND. #8 AWG | |
| 1 | 2" | - | - | 2 | 1 | ILLUMINATION |
| 2 | 4" | - | - | 4 | 1 | ROADWAY CROSSING ILLUMINATION |
| 6 | 2-4" | - | - | - | - | 2 SPARE CONDUITS |

LUMINAIRE SCHEDULE

| LUMINAIRE NUMBER | POLE STATION | POLE OFFSET | POLE HEIGHT | CIRCUIT NUMBER | REMARKS |
|------------------|--------------|-------------|-------------|----------------|---------|
| 5 | B 15+47.9 | 35.4' RT | 40 | 1-C | NEW |

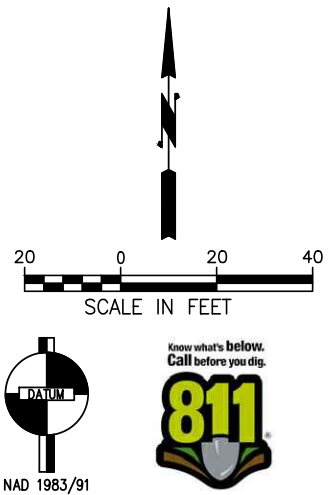

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CARPENTER ROAD/BRITTON PARKWAY
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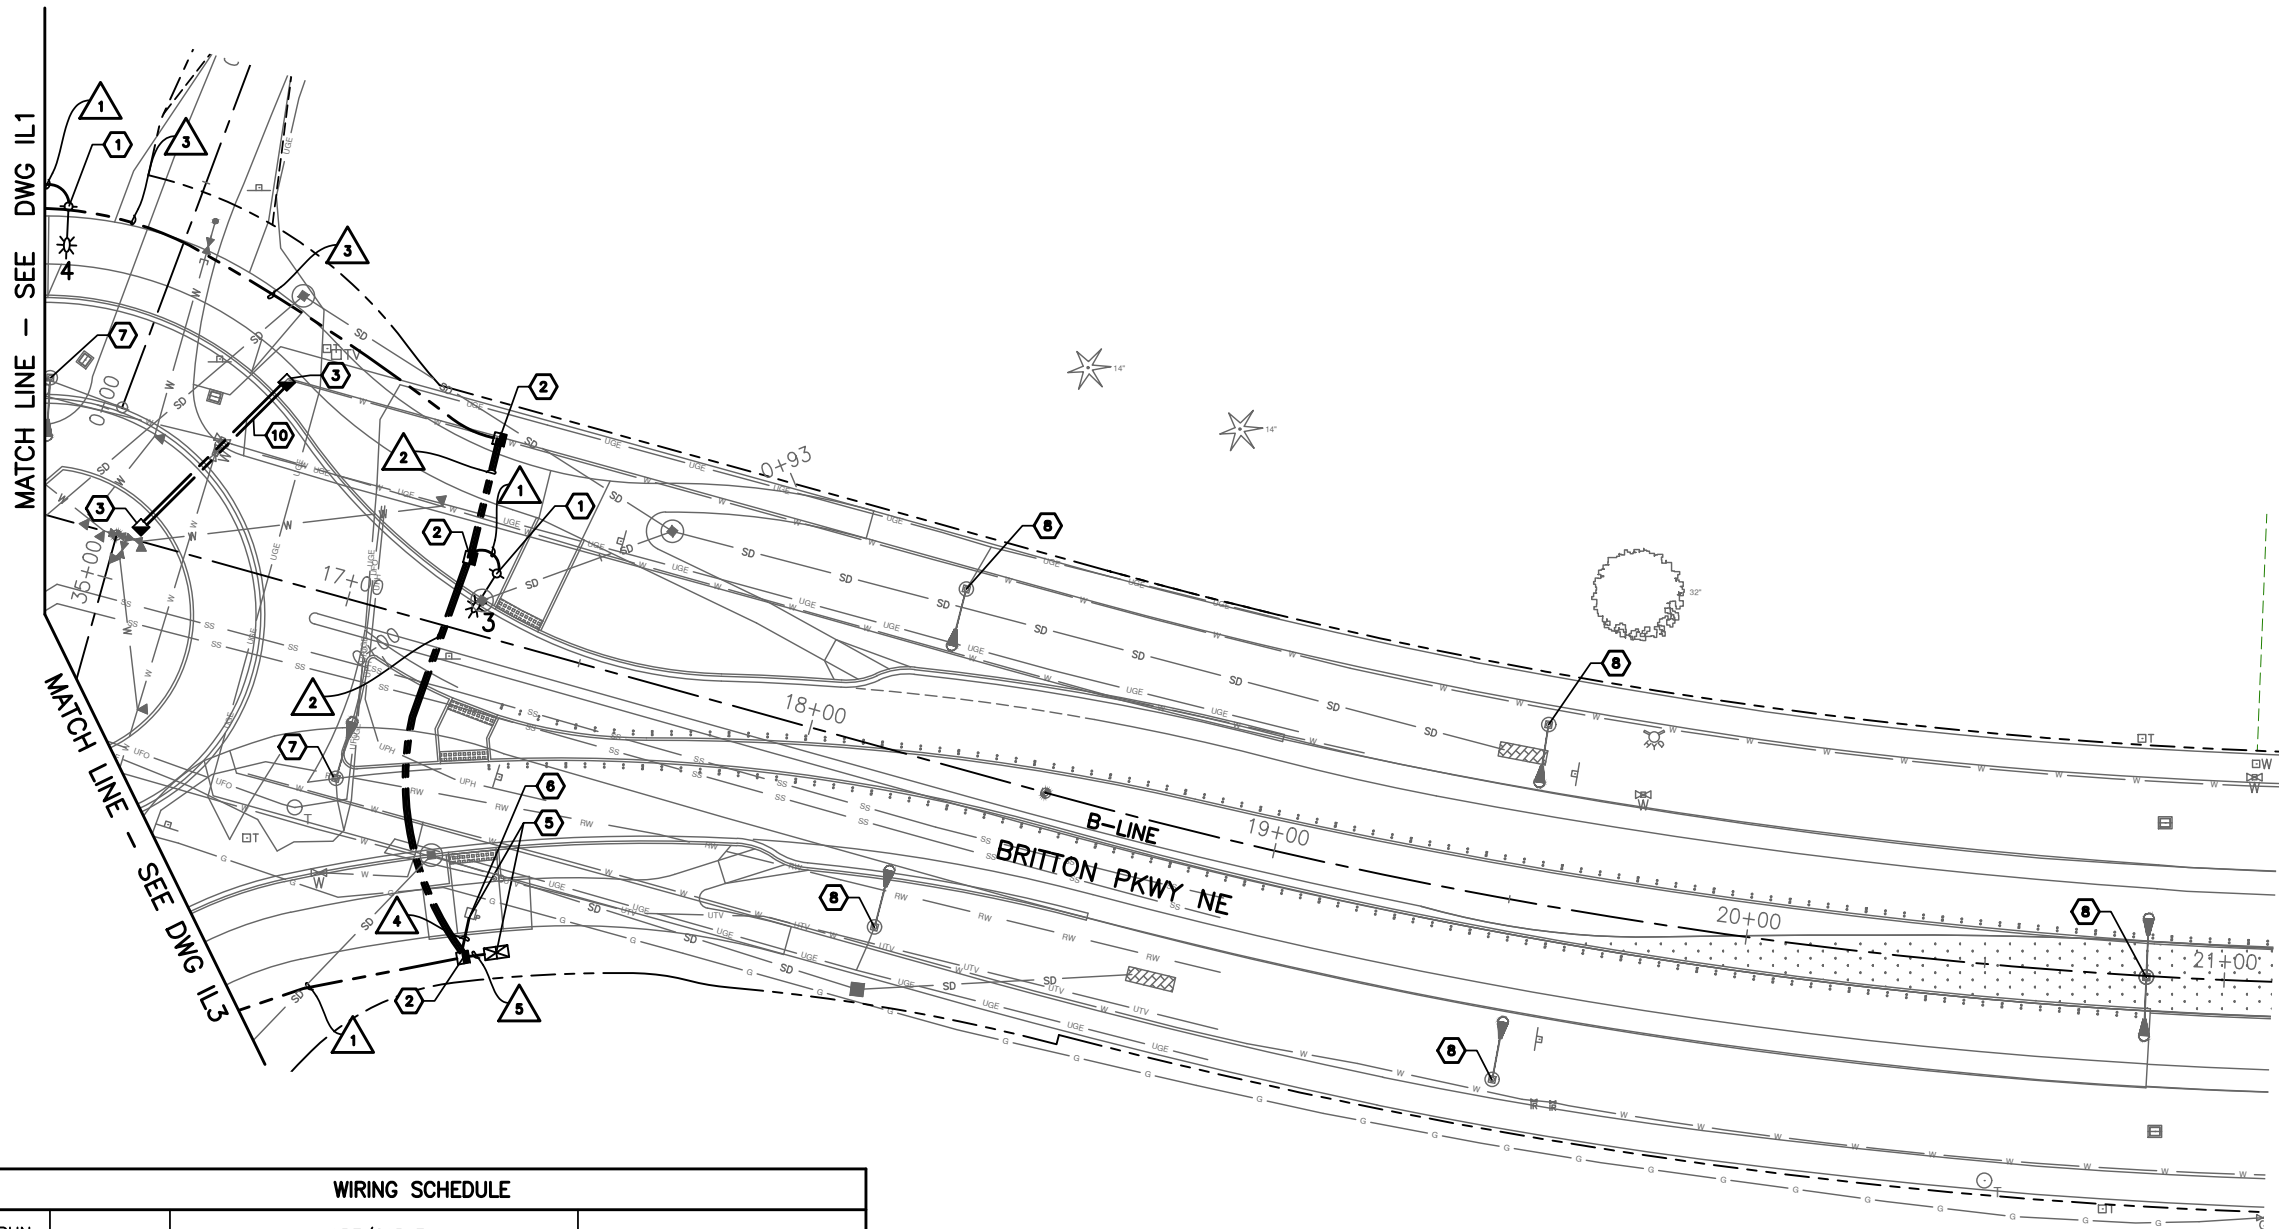
ILLUMINATION PLAN

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CONSTRUCTION NOTES:

- 1 INSTALL FOUNDATION AND 40' LIGHT STANDARD WITH 6-FOOT MASTARM AND 180W LED LUMINAIRE
- 2 INSTALL TYPE 8 JUNCTION BOX
- 3 TYPE 2 JUNCTION BOX
- 4 INSTALL TYPE 1 JUNCTION BOX
- 5 INSTALL FOUNDATION AND RELOCATE EXISTING SERVICE CABINET TO STA B 17+49.6, 62.5 RT. CONTACT UTILITY COMPANY FOR POWER SUPPLY EXTENSION.
- 6 INTERCEPT EXISTING CONDUITS AND CONNECT EXISTING CONDUITS.
- 7 REMOVE EXISTING LIGHT POLE AND POLE FOUNDATION
- 8 EXISTING LIGHT POLE TO REMAIN
- 9 REMOVE EXISTING STOP SIGN. INSTALL STOP SIGN WITH LED LIGHTS (36"x36")
- 10 TWO PARALLEL 4" CONDUITS


LEGEND

- EXISTING JUNCTION BOX
- JUNCTION BOX (TYPE 1, 2, 8)
- EXISTING STREET LIGHT ASSEMBLY
- PROPOSED STREET LIGHT ASSEMBLY
- ELECTRICAL CONDUIT
- ELECTRICAL SERVICE

| WIRING SCHEDULE | | | | | | |
|-----------------|--------------|------------|--------|--------|------------------|---------------------------------------|
| RUN NO. | CONDUIT SIZE | WIRE/CABLE | | | | REMARKS |
| | | #2 AWG | #6 AWG | #8 AWG | BARE GND. #8 AWG | |
| 1 | 2" | - | - | 2 | 1 | ILLUMINATION |
| 2 | 3-4" | - | - | 4 | 1 | ROADWAY CROSSING ILLUMINATION |
| 3 | 2" | - | - | 4 | 1 | ILLUMINATION AND SIGN |
| 4 | FIELD DECIDE | - | - | - | 1 | MATCH EXISTING CONDUIT/CONDUCTOR SIZE |
| 5 | 4" | - | - | - | 1 | MATCH EXISTING AND NEW CONDUCTOR SIZE |

SEE SHEET IL1 FOR WIRING AND LUMINAIRE SCHEDULE

| LUMINAIRE SCHEDULE | | | | | |
|--------------------|--------------|-------------|-------------|----------------|---------|
| LUMINAIRE NUMBER | POLE STATION | POLE OFFSET | POLE HEIGHT | CIRCUIT NUMBER | REMARKS |
| 3 | B 17+28.6 | 13.2' LT | 40' | 1-C | NEW |
| 4 | B 16+22.2 | 63.2' LT | 40' | 1-C | NEW |

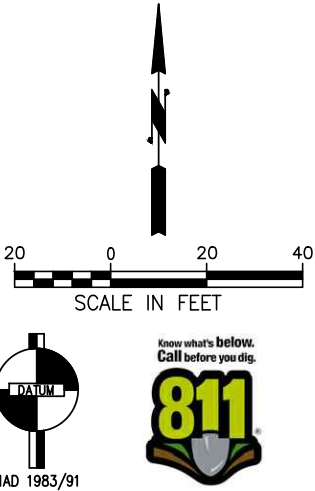

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CARPENTER ROAD/BRITTON PARKWAY
ROUNDBOUT


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CONSTRUCTION NOTES:

- 1 INSTALL FOUNDATION AND 40' LIGHT STANDARD WITH 6-FOOT MASTARM AND 180W LED LUMINAIRE
- 2 INSTALL TYPE 8 JUNCTION BOX
- 3 TYPE 2 JUNCTION BOX
- 4 INSTALL TYPE 1 JUNCTION BOX
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- 8 EXISTING LIGHT POLE TO REMAIN
- 9 REMOVE EXISTING STOP SIGN. INSTALL STOP SIGN WITH LED LIGHTS (36"x36")
- 10 TWO PARALLEL 4" CONDUITS

LEGEND

- | | |
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| | EXISTING JUNCTION BOX |
| | JUNCTION BOX (TYPE 1, 2, 8) |
| | EXISTING STREET LIGHT ASSEMBLY |
| | PROPOSED STREET LIGHT ASSEMBLY |
| | ELECTRICAL CONDUIT |
| | ELECTRICAL SERVICE |

SEE SHEET IL1 FOR WIRING AND LUMINAIRE SCHEDULE
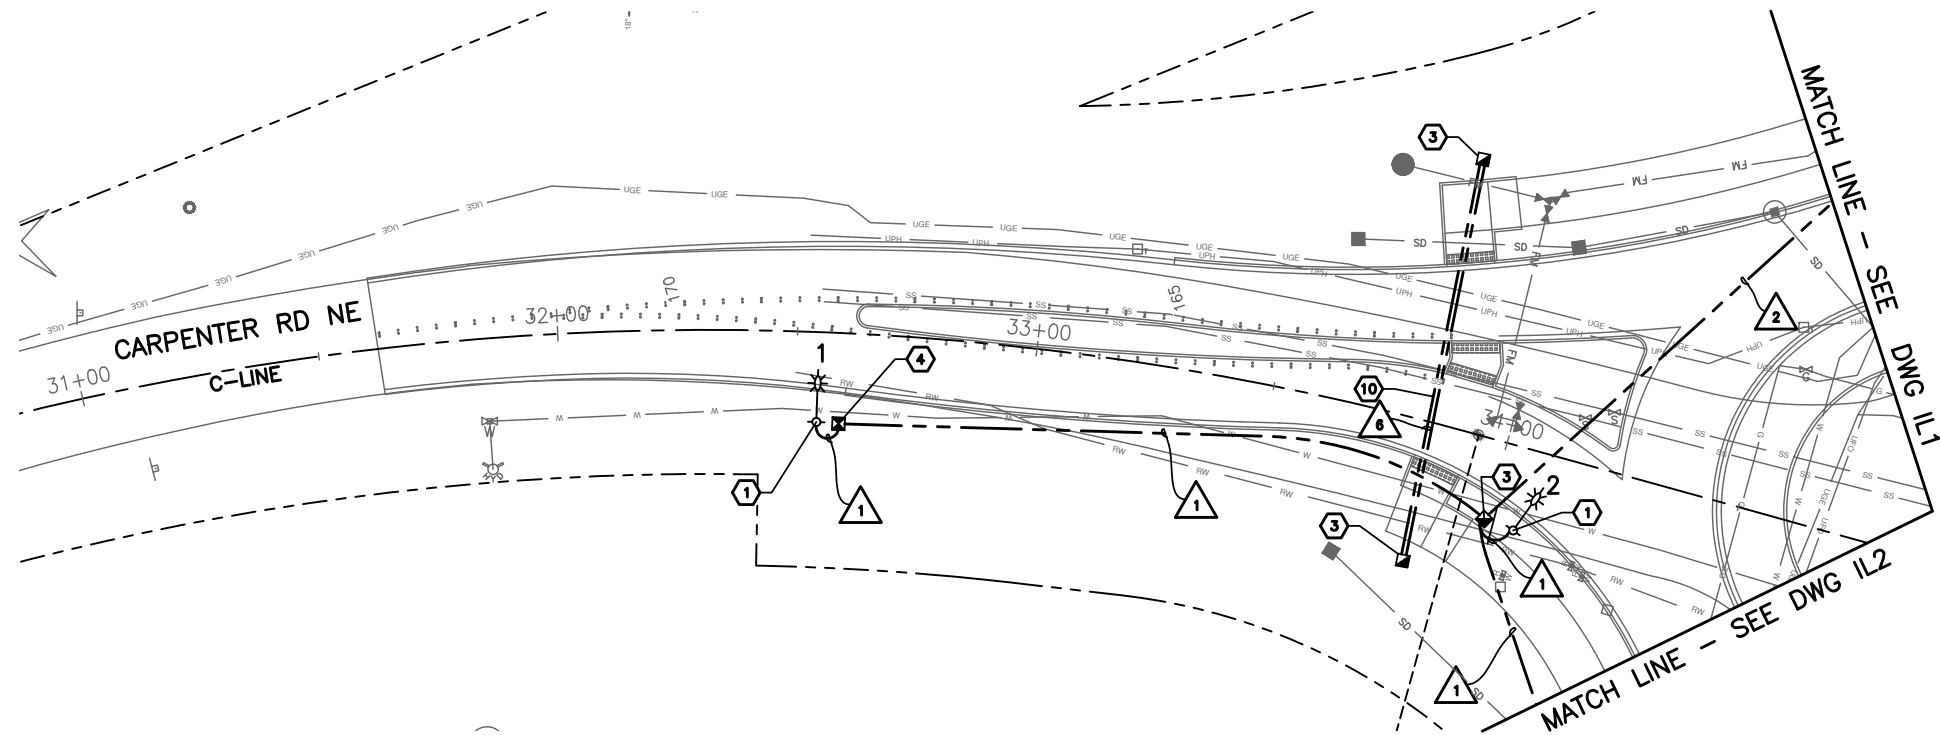
| WIRING SCHEDULE | | | | | | |
|-----------------|--------------|------------|--------|--------|------------------|-------------------------------|
| RUN NO. | CONDUIT SIZE | WIRE/CABLE | | | | REMARKS |
| | | #2 AWG | #6 AWG | #8 AWG | BARE GND. #8 AWG | |
| 1 | 2" | - | - | 2 | 1 | ILLUMINATION |
| 2 | 4" | - | - | 4 | 1 | ROADWAY CROSSING ILLUMINATION |
| 6 | 2-4" | - | - | - | - | 2 SPARE CONDUITS |

| LUMINAIRE SCHEDULE | | | | | |
|--------------------|--------------|-------------|-------------|----------------|---------|
| LUMINAIRE NUMBER | POLE STATION | POLE OFFSET | POLE HEIGHT | CIRCUIT NUMBER | REMARKS |
| 1 | C 32+54.5 | 18.8' RT | 40' | 1-C | NEW |
| 2 | C 34+06.1 | 17.3' RT | 40' | 1-C | NEW |




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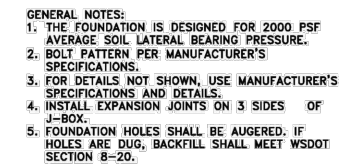
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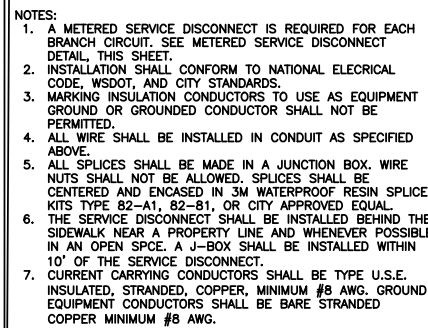


CARPENTER ROAD/BRITTON PARKWAY
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ILLUMINATION PLAN


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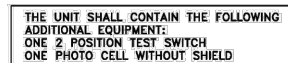
LUMINAIRE FOUNDATION
FOR 30' & 40' POLES
NTS



TYPICAL STREET LIGHT
INSTALLATION
NTS

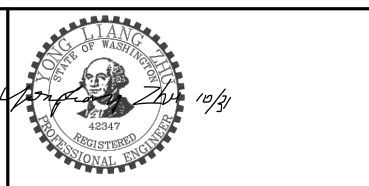


J-BOX LOCATION WITH
PLANTER STRIP
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METERED SERVICE DISCONNECT FOR
STREET LIGHTING AND TRAFFIC SIGNALS
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1. STANDARD VOLTAGE IS 120/240V; 200 AMP.
2. CALTRANS TYPE 3B SERVICE OR U.L. APPROVED EQUAL.
3. TYPE 3R RAIN PROOF ENCLOSURE.
4. NATURAL ALUMINUM CONSTRUCTION.
5. INTERIORS WILL ACCEPT PLUG-IN BREAKERS (BRYANT, GE, WESTINGHOUSE, CROUSE-HINDS).
6. 2-30 AMP LIGHTING CONTACTORS.

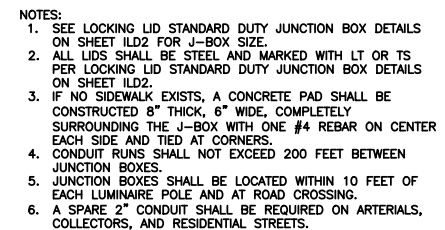1. THE SERVICE DISCONNECT SHALL BE INSTALLED BEHIND THE SIDEWALK NEAR A PROPERTY LINE AND WHENEVER POSSIBLE IN AN OPEN SPACE.
2. INSTALLATION SHALL BE CONFORM TO THE NATIONAL ELECTRICAL CODE, WSDOT AND THE CITY OF LACEY STANDARDS.
3. THE CLEARANCE ZONE AROUND THE SERVICE CABINET SHALL BE 5'.
4. THE CABINET FOUNDATION (TOP TIER) SHALL BE PER THE MANUFACTURER'S REQUIREMENTS. DO NOT POUR THE FOUNDATION UNTIL THAT INFORMATION IS RECEIVED.




SIGNAL CABINET/ELECTRICAL
SERVICE FOUNDATION
NTS

- GENERAL NOTES:
1. PAD AND PEDESTAL MOUNTS SHALL BE COMMERCIAL CONCRETE UNLESS NOTED OTHERWISE ON PLANS.
 2. WHERE PAD OF PEDESTAL MOUNTS ARE LOCATED IN SIDEWALK, CONSTRUCTION MUST BE FLUSH WITH SIDEWALK GRADE, OMITTING CHAMFER WHERE TOP AND SIDEWALK ABUT.
 3. PAD MOUNT DESIGN IS TYPICAL; CONTRACTOR SHALL CONSULT CABINET ON BASE WITH RESPECT TO FINISH PLACEMENT. CONTRACTOR SHALL SUBMIT FOR APPROVAL A PROPOSED DESIGN WITH PLAN, ELEVATION AND ANY RELEVANT SECTION VIEW.
 4. CABINET SHALL BE ATTACHED WITH AASHTO M 164 CHEMICALLY BONDED ANCHOR TO EXISTING PAD. ANCHOR INSTALLATIONS SHALL BE PER MANUFACTURER'S RECOMMENDATIONS IN DRY CONDITIONS.
 5. PLACE A SILICONE SEAL BETWEEN THE CABINET FOUNDATION AND THE CABINET FOR THE PAD MOUNT DESIGN.
 6. CABINET AND SERVICE TO BE CENTERED ON BASE.
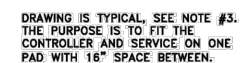
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CARPENTER ROAD/BRITTON PARKWAY ROUNDBOUT



ILLUMINATION DETAILS
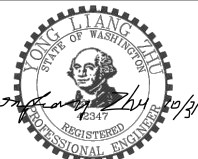
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WATERLINE PROFILE – BRITTON PKWY NE

GENERAL NOTES

1. CALL 48 HOURS BEFORE YOU DIG 1-800-424-5555 OR 811.
2. THE CONTRACTOR SHALL FIELD VERIFY UTILITY LOCATIONS PRIOR TO CONSTRUCTION. EXISTING UTILITIES ARE SHOWN BASED ON SURFACE LOCATE MARKS AND LIMITED POTHOLING MEASUREMENTS.
3. THE CONTRACTOR SHALL COORDINATE WATER SYSTEM OUTAGE WITH CITY OF LACEY STAFF. THE CITY WILL BE GIVEN 72 HOURS NOTICE PRIOR TO SCHEDULING A SHUTDOWN. EXISTING VALVES SHALL BE OPERATED BY CITY EMPLOYEES ONLY.
4. THE CONTRACTOR SHALL COORDINATE WATER SYSTEM OUTAGE WITH CITY OF LACEY STAFF. EXISTING VALVES SHALL BE OPERATED BY CITY EMPLOYEES ONLY.
5. SEE DRAWING AL1 AND AL2 FOR ALIGNMENT AND CONTROL INFORMATION.
6. SEE DRAWINGS SP1 TO SP6 FOR PAVEMENT REMOVAL AND DRAWINGS PV1 TO PV6 FOR PAVEMENT REPLACEMENT.
7. SEPARATION BETWEEN WATER AND NON-POTABLE LINES SHALL BE MAINTAINED PER DOE STANDARDS. INVERT OF THE WATER MAIN TO BE 18" ABOVE THE CROWN OF THE NON-POTABLE LINE.
8. SEE DRAWING UP1 FOR SEWER FORCE MAIN PROFILE.


CONSTRUCTION NOTES:

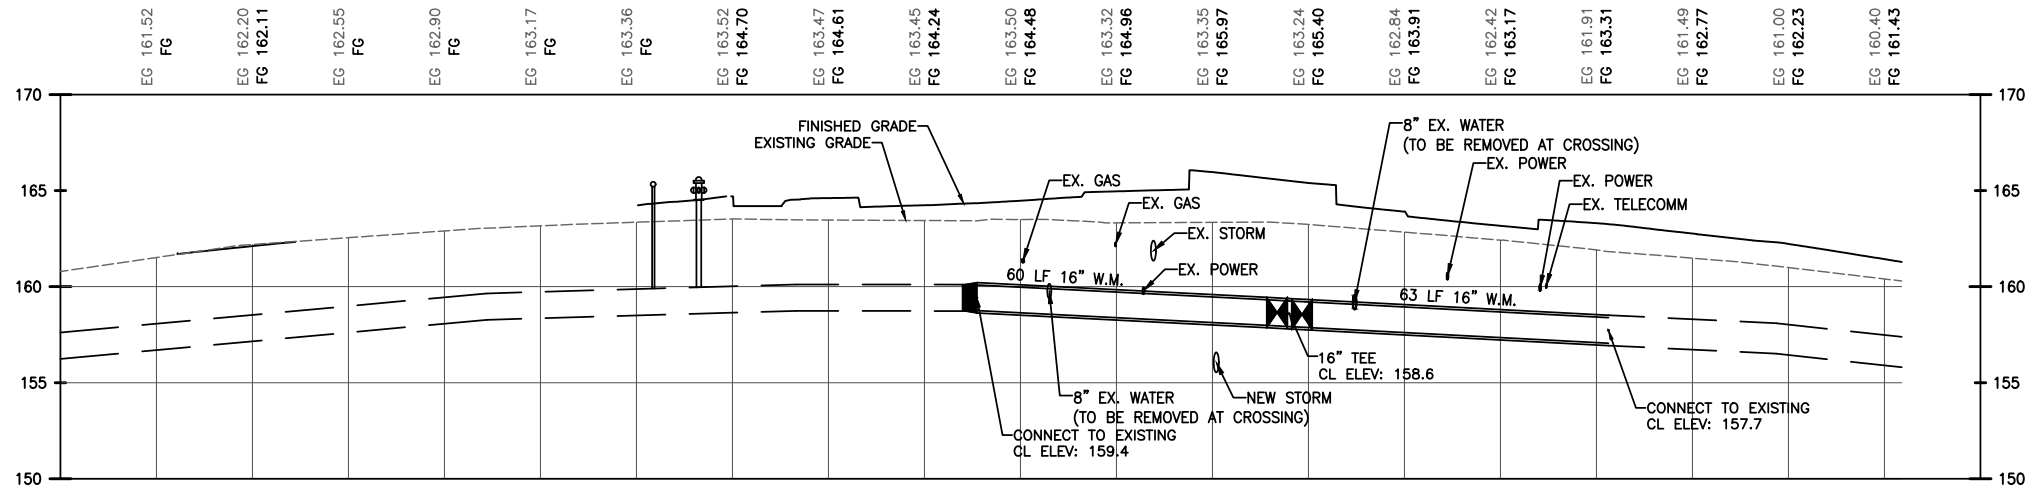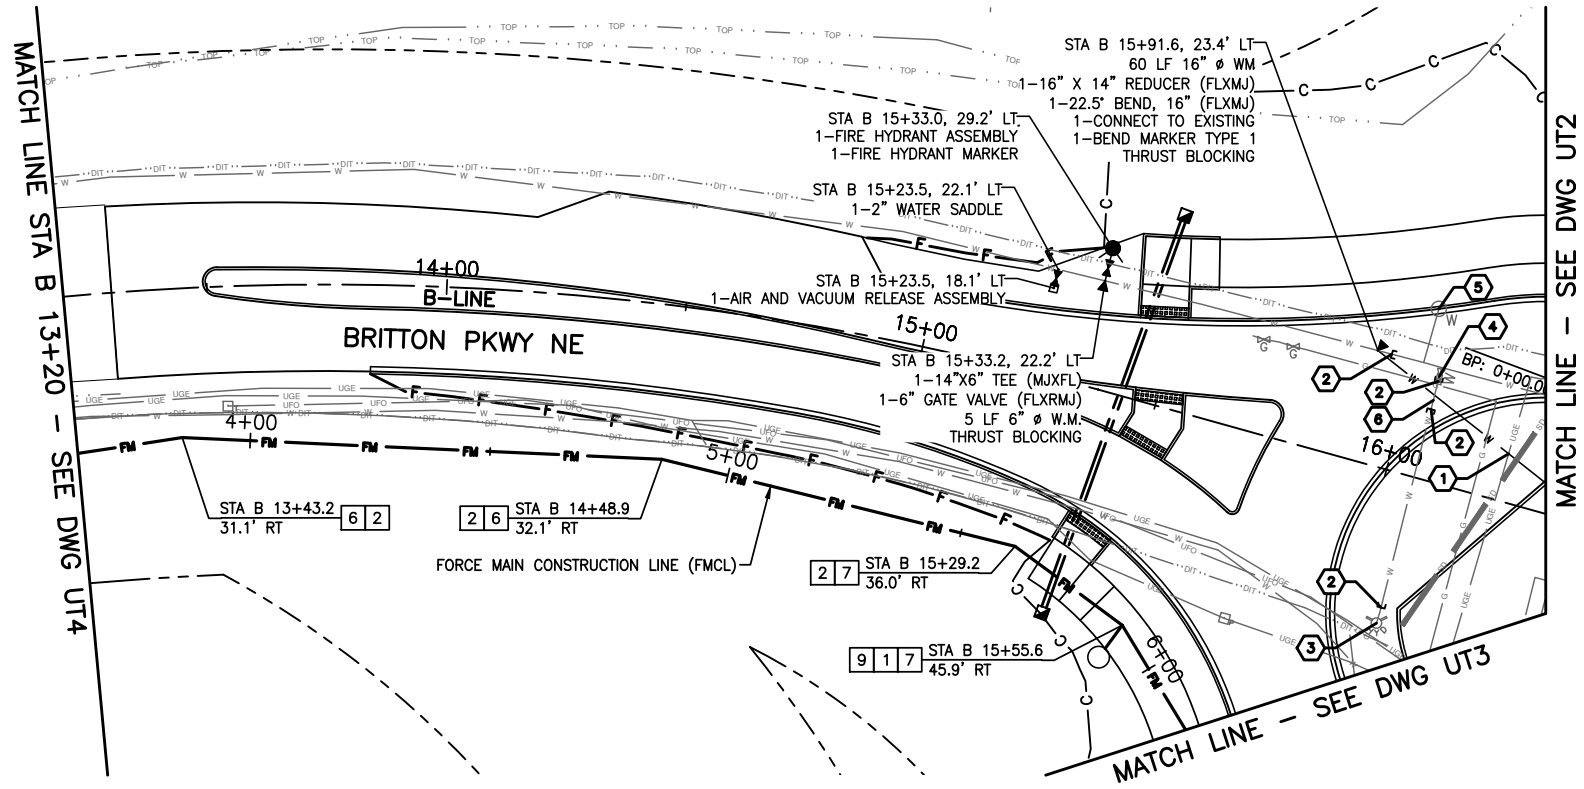1. CONTRACTOR TO COORDINATE RELOCATION OF EXISTING POWER CONDUIT
2. CUT EXISTING WATER MAIN. CAP OR PLUG END OF PIPE AND ABANDON.
3. REMOVE EXISTING FIRE HYDRANT
4. CLOSE VALVE AND REMOVE EXISTING VALVE BOX
5. REMOVE EXISTING WATER MANHOLE AND AIR RELEASE VALVE. CUT AND PLUG 2" WATER SERVICE TO MANHOLE.
6. REMOVE EXISTING WATER MAIN SEGMENT BETWEEN CUTS.
1. BEND MARKER TYPE I PER DETAIL ON SHEET UD2
2. BEND MARKER TYPE II PER DETAIL ON SHEET UD2
3. 4" PLUG VALVE & VALVE BOX, FL X FL WITH RJ ADAPTERS
4. CONCRETE THRUST BLOCKING PER DETAIL ON SHEET UD2
5. FUTURE EXTENSION ASSEMBLY PER DETAIL ON SHEET UD1
6. 11.25' BEND, RJ
7. 22.5' BEND, RJ
8. 45' BEND, RJ
9. SEWER AIR RELEASE ASSEMBLY PER DETAIL ON SHEET UD1. PLACE AT HIGH POINT IN FORCE MAIN.
10. LOW POINT DRAIN PER DETAIL ON SHEET UD3



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CARPENTER ROAD/BRITTON PARKWAY
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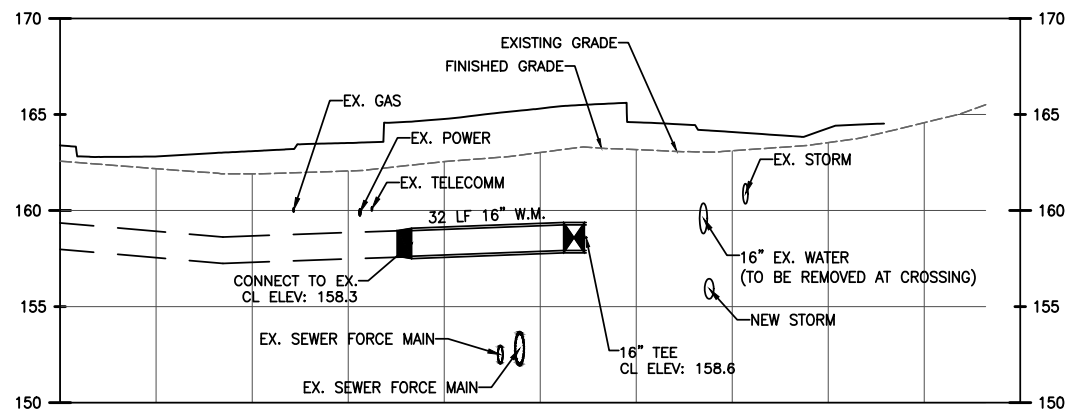
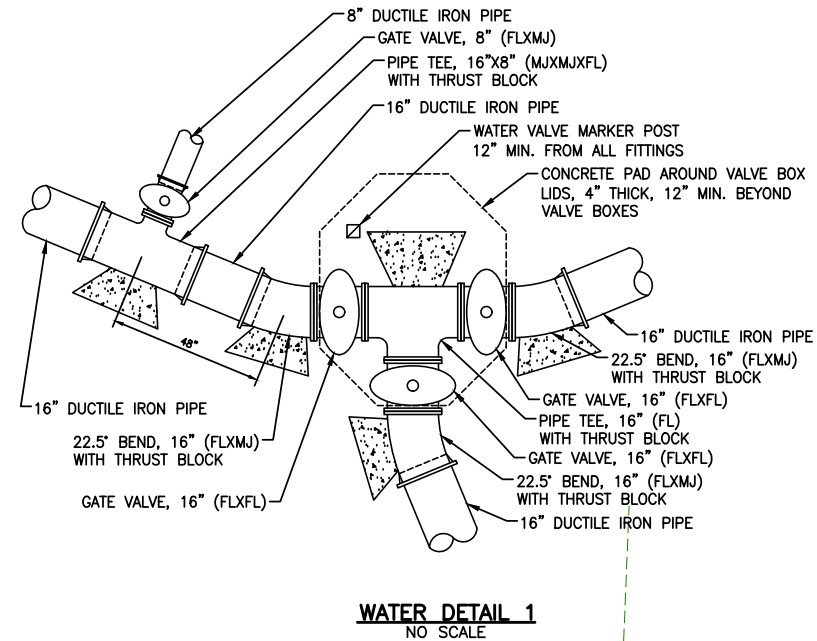
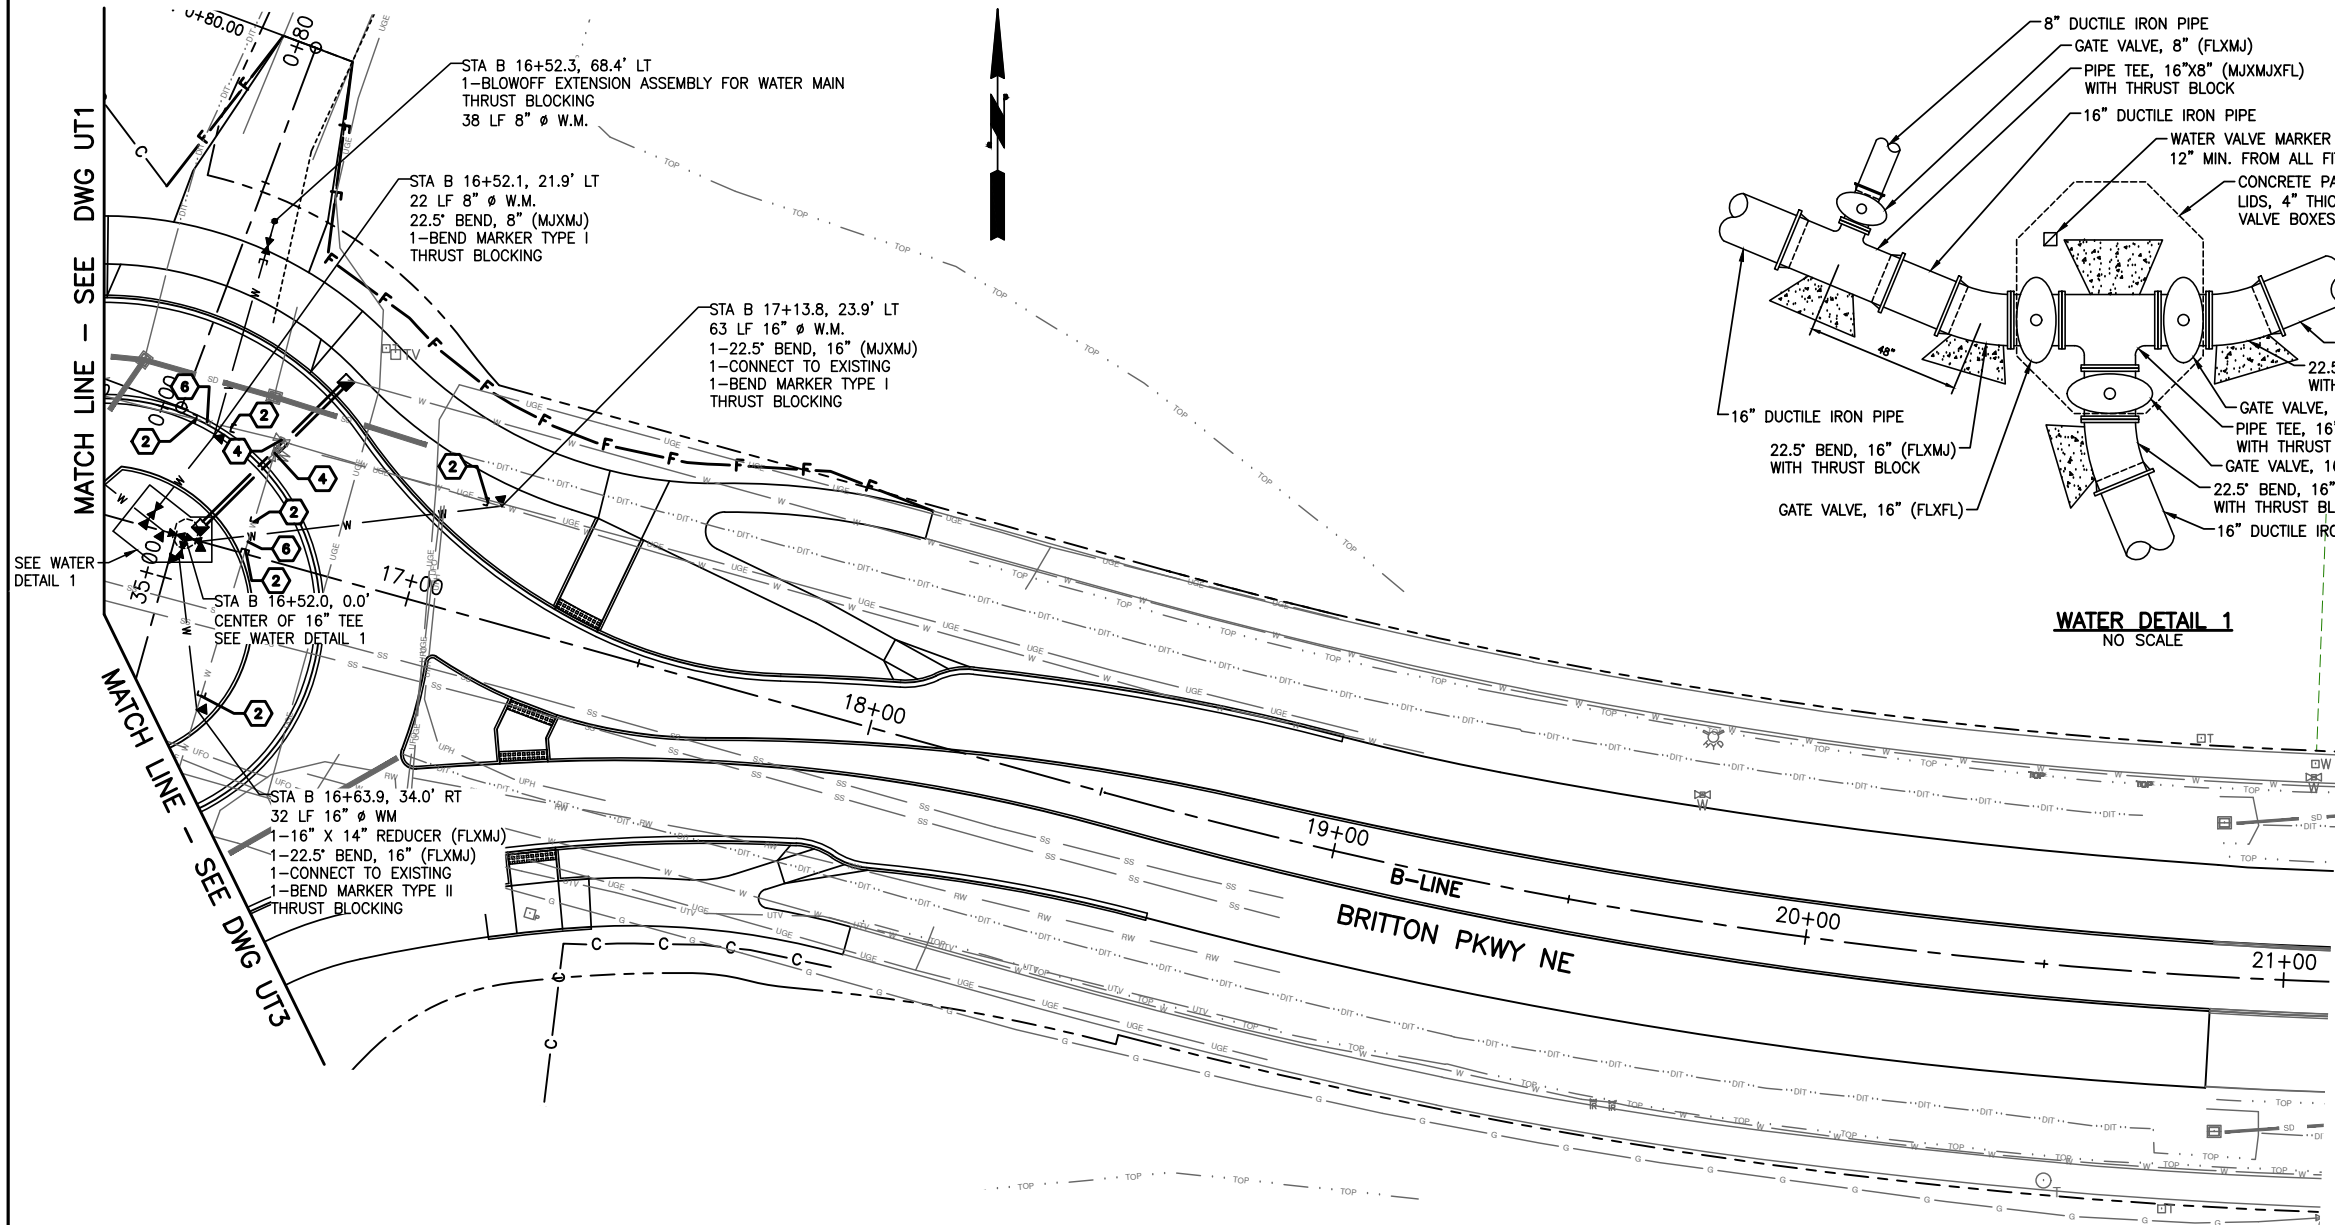
UTILITY PLAN

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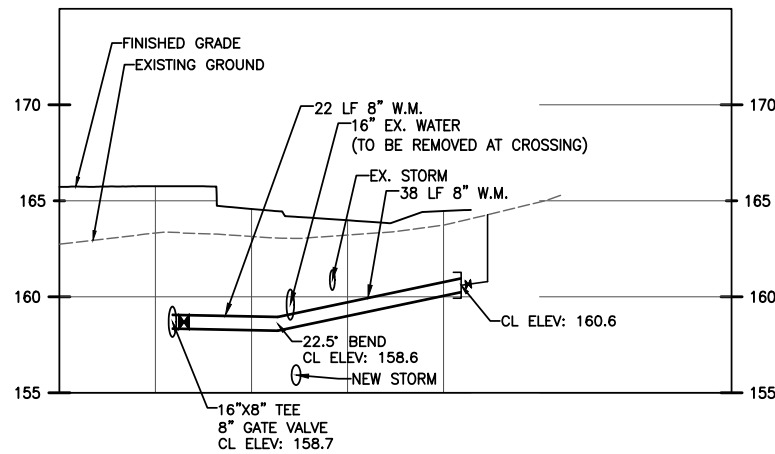
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WATERLINE PROFILE - CARPENTER ROAD

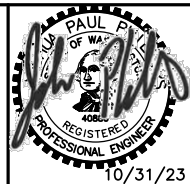

WATERLINE PROFILE - BRITTON LANE




GENERAL NOTES

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3. THE CONTRACTOR SHALL COORDINATE WATER SYSTEM OUTAGE WITH CITY OF LACEY STAFF. THE CITY WILL BE GIVEN 72 HOURS NOTICE PRIOR TO SCHEDULING A SHUTDOWN. EXISTING VALVES SHALL BE OPERATED BY CITY EMPLOYEES ONLY.
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8. SEE DRAWING UP1 FOR SEWER FORCE MAIN PROFILE.

CONSTRUCTION NOTES:

- 1 CONTRACTOR TO COORDINATE RELOCATION OF EXISTING POWER CONDUIT
- 2 CUT EXISTING WATER MAIN. CAP OR PLUG END OF PIPE AND ABANDON.
- 3 REMOVE EXISTING FIRE HYDRANT
- 4 CLOSE VALVE AND REMOVE EXISTING VALVE BOX
- 5 REMOVE EXISTING WATER MANHOLE AND AIR RELEASE VALVE. CUT AND PLUG 2" WATER SERVICE TO MANHOLE.
- 6 REMOVE EXISTING WATER MAIN SEGMENT BETWEEN CUTS.
- 1 BEND MARKER TYPE I PER DETAIL ON SHEET UD2
- 2 BEND MARKER TYPE II PER DETAIL ON SHEET UD2
- 3 4" PLUG VALVE & VALVE BOX, FL X FL WITH RJ ADAPTERS
- 4 CONCRETE THRUST BLOCKING PER DETAIL ON SHEET UD2
- 5 FUTURE EXTENSION ASSEMBLY PER DETAIL ON SHEET UD1
- 6 11.25' BEND, RJ
- 7 22.5' BEND, RJ
- 8 45' BEND, RJ
- 9 SEWER AIR RELEASE ASSEMBLY PER DETAIL ON SHEET UD1. PLACE AT HIGH POINT IN FORCE MAIN.
- 10 LOW POINT DRAIN PER DETAIL ON SHEET UD3

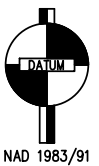

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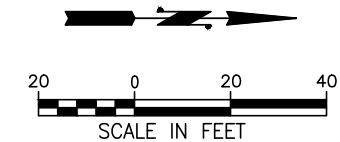
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UTILITY PLAN

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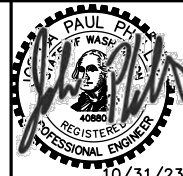
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- 1** CONTRACTOR TO COORDINATE RELOCATION OF EXISTING POWER CONDUIT
- 2** CUT EXISTING WATER MAIN. CAP OR PLUG END OF PIPE AND ABANDON.
- 3** REMOVE EXISTING FIRE HYDRANT
- 4** CLOSE VALVE AND REMOVE EXISTING VALVE BOX
- 5** REMOVE EXISTING WATER MANHOLE AND AIR RELEASE VALVE. CUT AND PLUG 2" WATER SERVICE TO MANHOLE.
- 6** REMOVE EXISTING WATER MAIN SEGMENT BETWEEN CUTS.
- 1** BEND MARKER TYPE I PER DETAIL ON SHEET UD2
- 2** BEND MARKER TYPE II PER DETAIL ON SHEET UD2
- 3** 4" PLUG VALVE & VALVE BOX, FL X FL WITH RJ ADAPTERS
- 4** CONCRETE THRUST BLOCKING PER DETAIL ON SHEET UD2
- 5** FUTURE EXTENSION ASSEMBLY PER DETAIL ON SHEET UD1
- 6** 11.25' BEND, RJ
- 7** 22.5' BEND, RJ
- 8** 45' BEND, RJ
- 9** SEWER AIR RELEASE ASSEMBLY PER DETAIL ON SHEET UD1. PLACE AT HIGH POINT IN FORCE MAIN.
- 10** LOW POINT DRAIN PER DETAIL ON SHEET UD3



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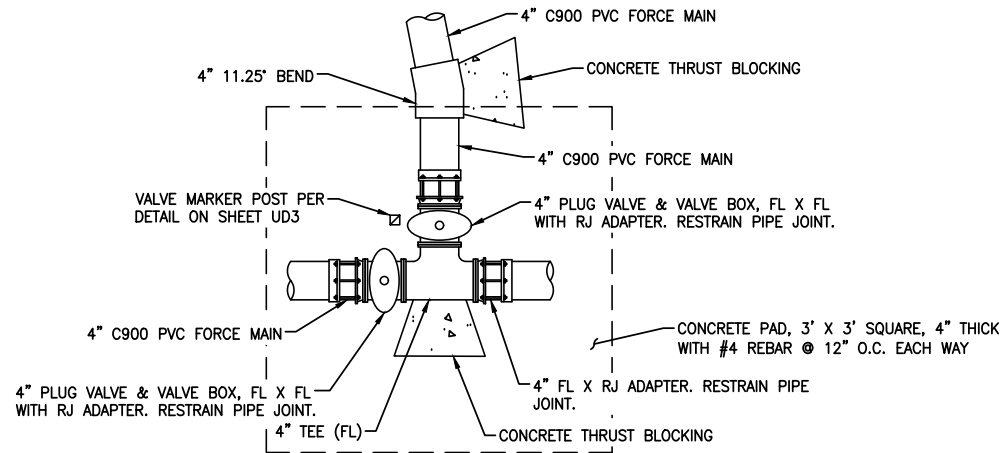


CITY OF **LACEY**


UTILITY PLAN

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FORCE MAIN DETAIL 1



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5. SEE DRAWING AL1 AND AL2 FOR ALIGNMENT AND CONTROL INFORMATION.
6. SEE DRAWINGS SP1 TO SP6 FOR PAVEMENT REMOVAL AND DRAWINGS PV1 TO PV6 FOR PAVEMENT REPLACEMENT.
7. SEPARATION BETWEEN WATER AND NON-POTABLE LINES SHALL BE MAINTAINED PER DOE STANDARDS. INVERT OF THE WATER MAIN TO BE 18" ABOVE THE CROWN OF THE NON-POTABLE LINE.
8. SEE DRAWING UP1 FOR SEWER FORCE MAIN PROFILE.

CONSTRUCTION NOTES:

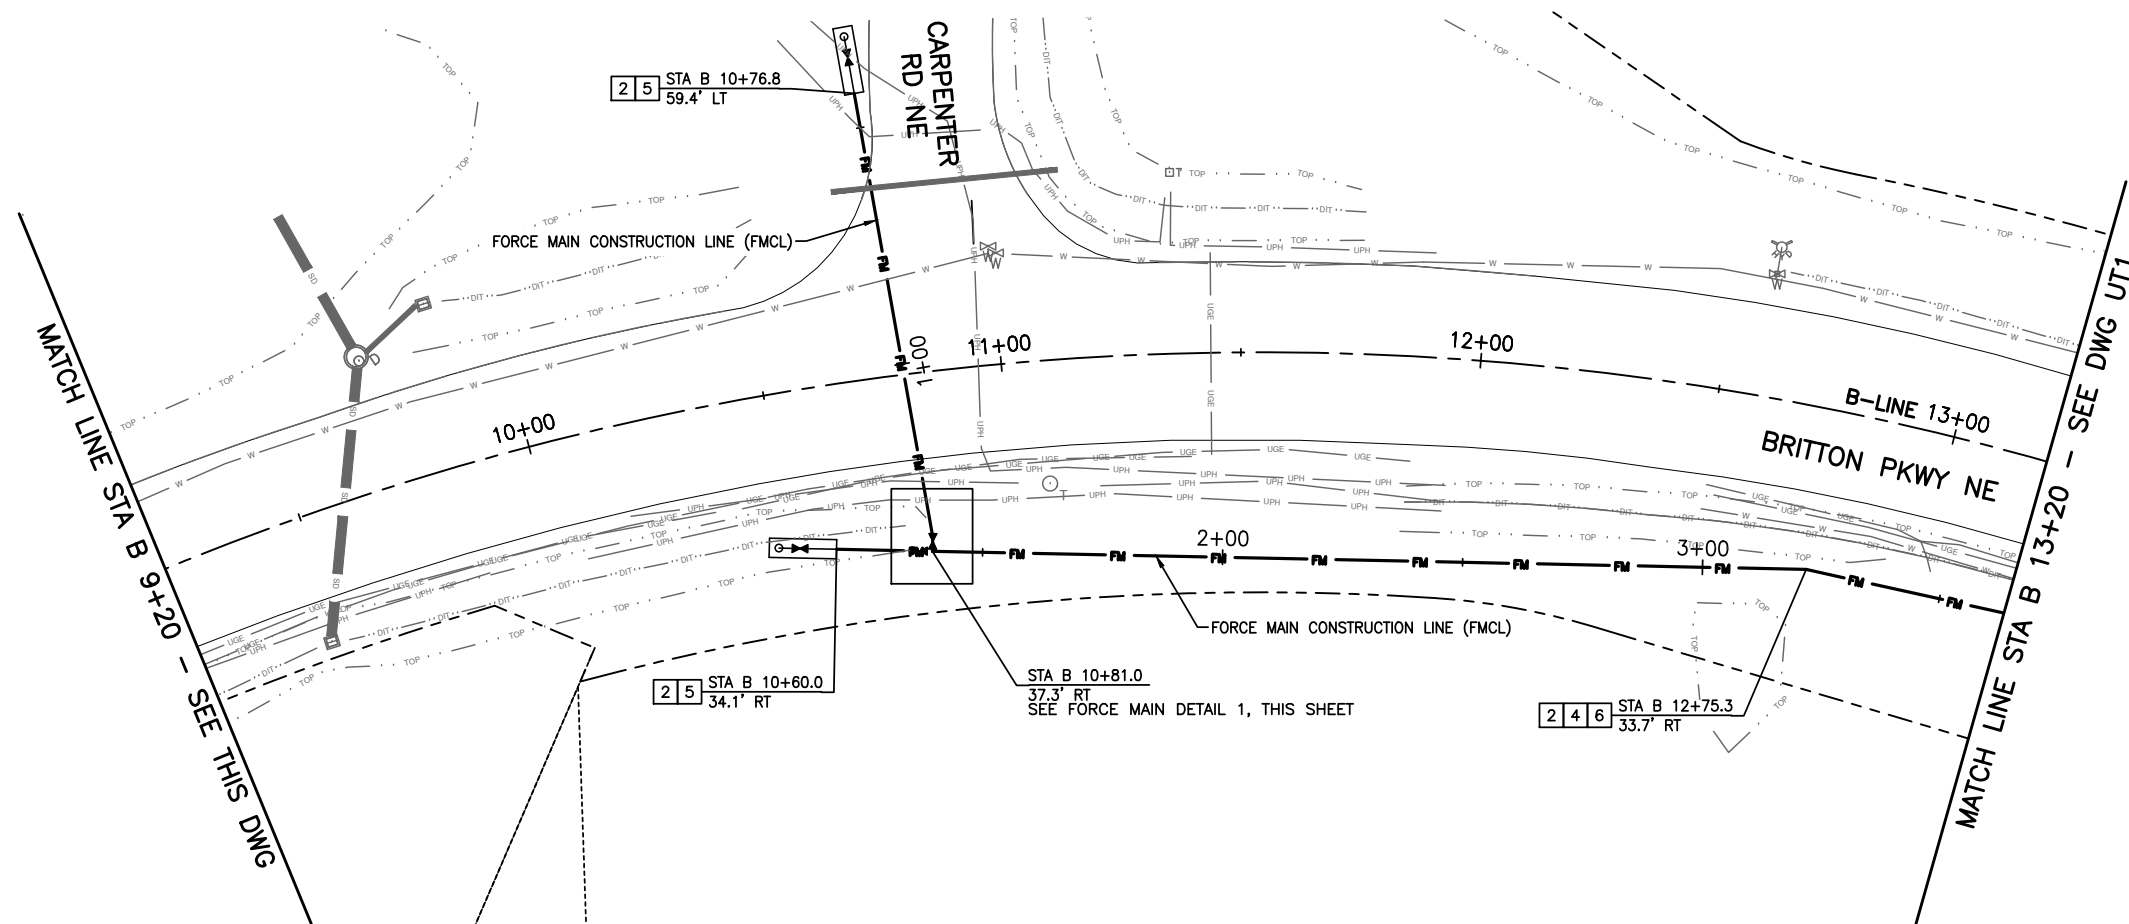1. CONTRACTOR TO COORDINATE RELOCATION OF EXISTING POWER CONDUIT
2. CUT EXISTING WATER MAIN. CAP OR PLUG END OF PIPE AND ABANDON.
3. REMOVE EXISTING FIRE HYDRANT
4. CLOSE VALVE AND REMOVE EXISTING VALVE BOX
5. REMOVE EXISTING WATER MANHOLE AND AIR RELEASE VALVE. CUT AND PLUG 2" WATER SERVICE TO MANHOLE.
6. REMOVE EXISTING WATER MAIN SEGMENT BETWEEN CUTS.
1. BEND MARKER TYPE I PER DETAIL ON SHEET UD2
2. BEND MARKER TYPE II PER DETAIL ON SHEET UD2
3. 4" PLUG VALVE & VALVE BOX, FL X FL WITH RJ ADAPTERS
4. CONCRETE THRUST BLOCKING PER DETAIL ON SHEET UD2
5. FUTURE EXTENSION ASSEMBLY PER DETAIL ON SHEET UD1
6. 11.25" BEND, RJ
7. 22.5" BEND, RJ
8. 45" BEND, RJ
9. SEWER AIR RELEASE ASSEMBLY PER DETAIL ON SHEET UD1. PLACE AT HIGH POINT IN FORCE MAIN.
10. LOW POINT DRAIN PER DETAIL ON SHEET UD3



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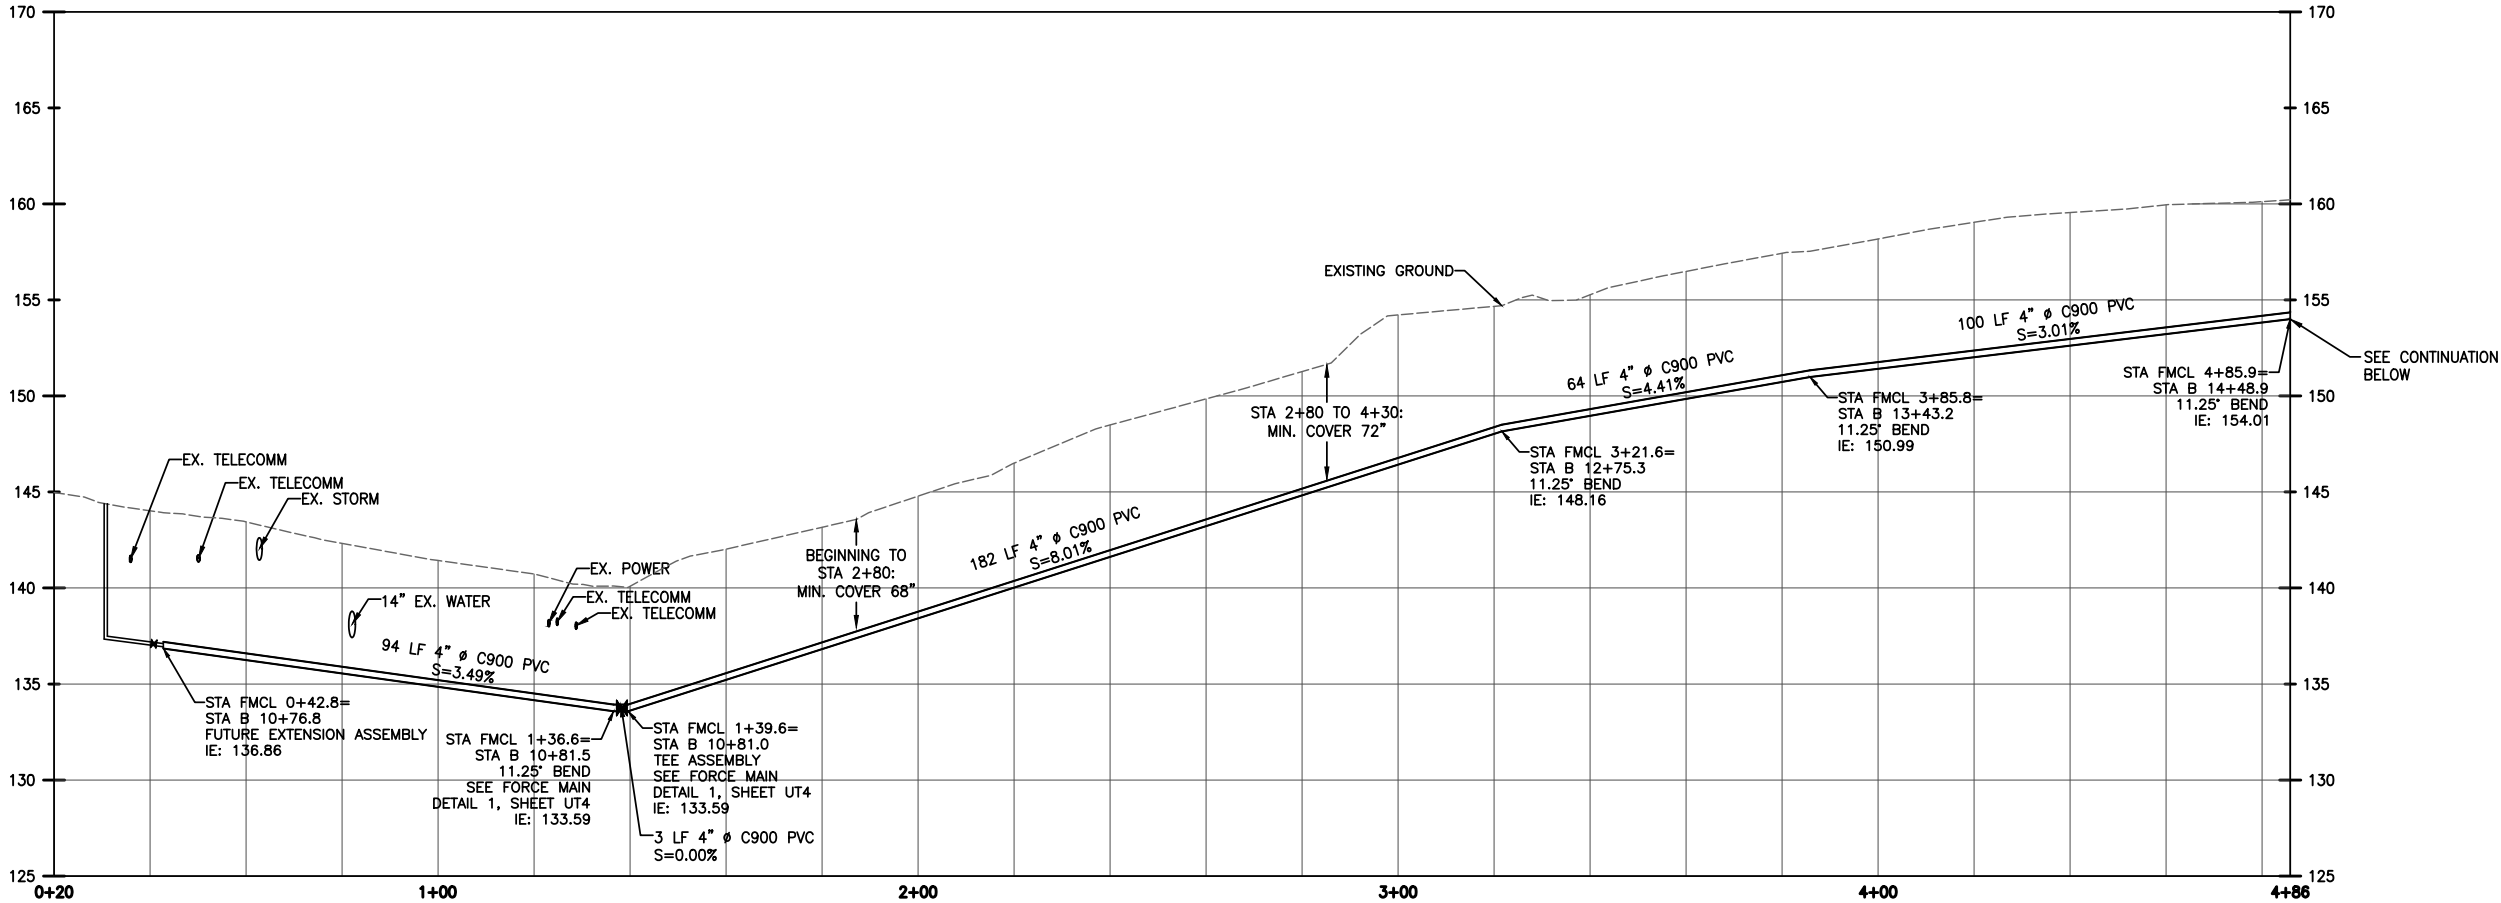
CARPENTER ROAD/BRITTON PARKWAY
ROUNDAOUT

UTILITY PLAN


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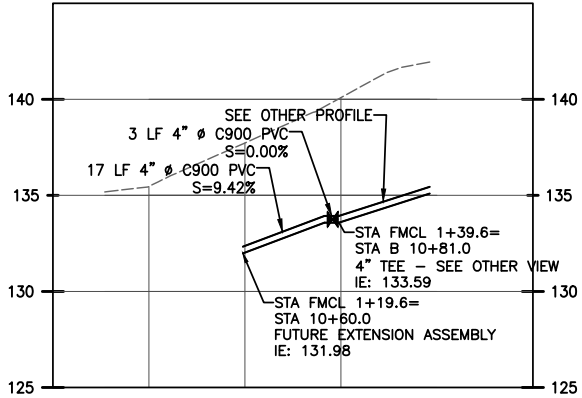
SHT 37 OF 64



PROFILE ALONG FORCE MAIN CONSTRUCTION LINE



PROFILE ALONG FORCE MAIN CONSTRUCTION LINE

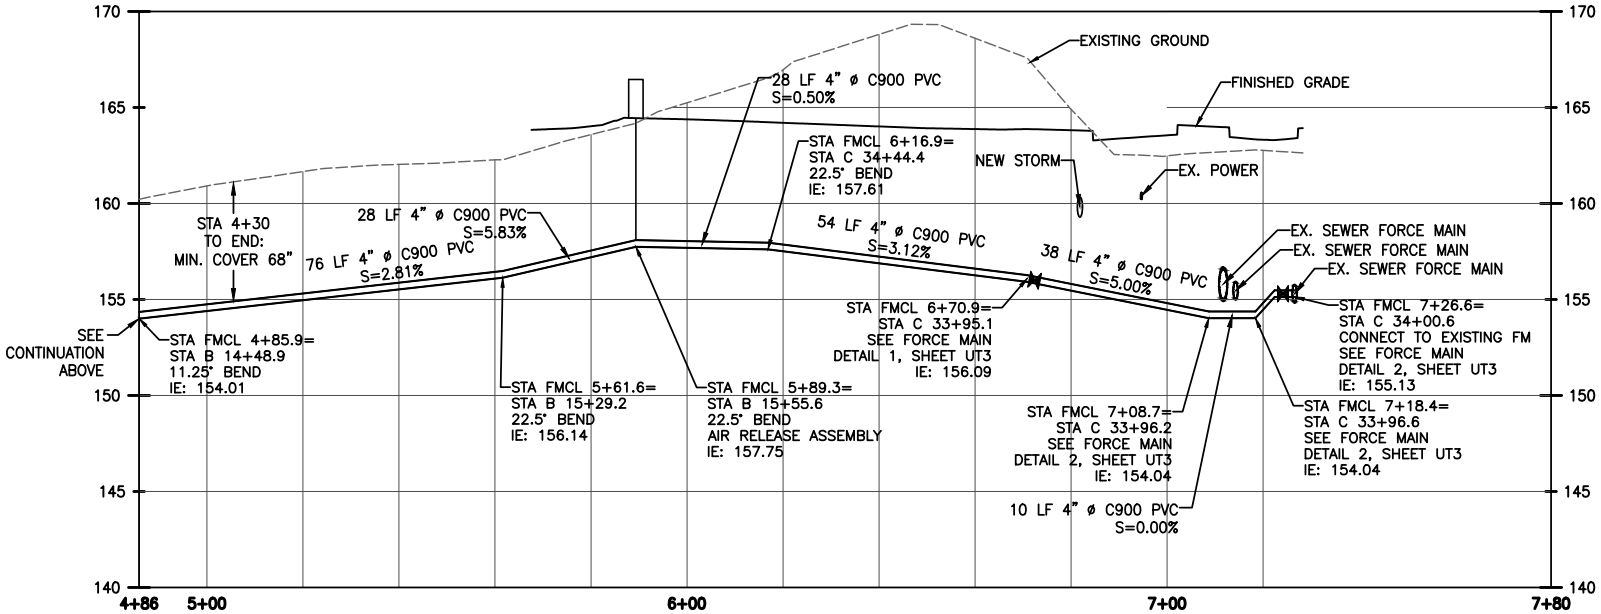


PROFILE TO FUTURE EXTENSION ASSEMBLY



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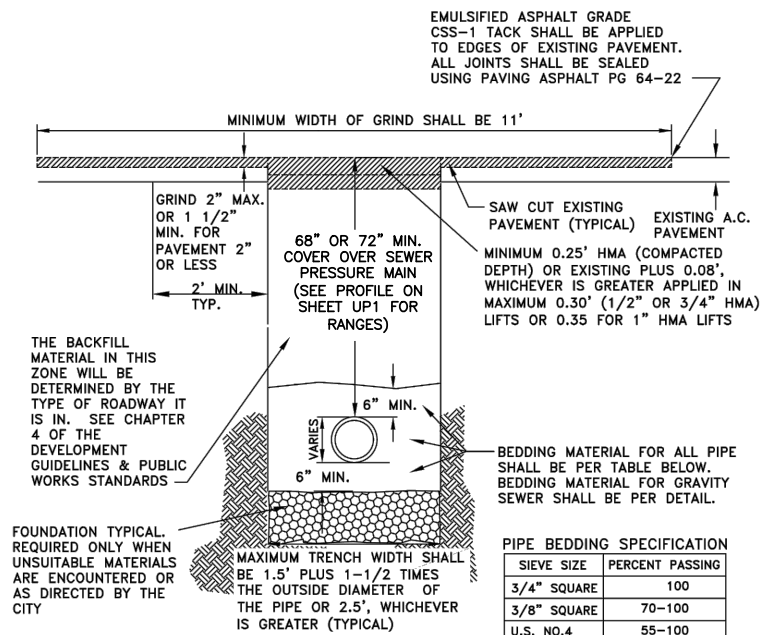
UTILITY PROFILE

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UP1

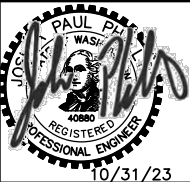
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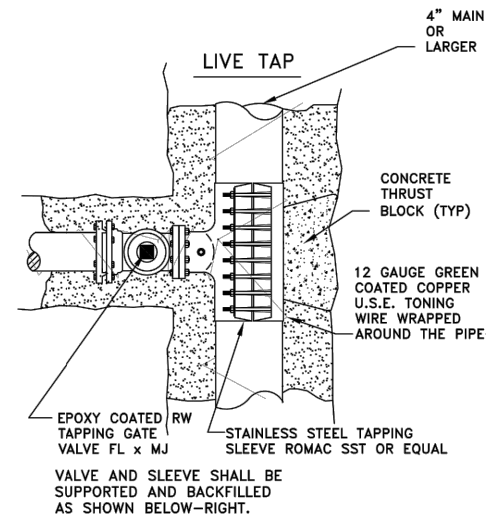
| PIPE BEDDING SPECIFICATION | |
|----------------------------|-----------------|
| SIEVE SIZE | PERCENT PASSING |
| 3/4" SQUARE | 100 |
| 3/8" SQUARE | 70-100 |
| U.S. NO. 4 | 55-100 |
| U.S. NO. 10 | 35-95 |
| U.S. NO. 20 | 20-80 |
| U.S. NO. 40 | 10-55 |
| U.S. NO. 100 | 0-10 |
| U.S. NO. 200 | 0-03 |

TYPICAL TRENCH SECTION FOR FORCE MAIN
NO SCALE




- GENERAL NOTES:
1. FOR VALVE BOX REQUIREMENT SEE DETAIL.
 2. THIS IS A FUTURE SEWER PRESSURE/FORCE MAIN EXTENSION DETAIL AND THE TEST REQUIREMENTS SHALL BE PER SECTION 7A.070 TESTING UNDER FORCE MAINS.
 3. SEE SECTION 7D.030 FORCE MAIN FOR PIPING REQUIREMENTS.
 4. IN UNUSUAL CIRCUMSTANCES THE PIPE WITH THE BELL END (MIN. LENGTH 17") MAY BE REDUCED TO A SHORTER LENGTH BUT NOT LESS THAN 10'. ALL OTHER CHANGES SHALL BE UNDER THE DIRECTION OF THE CITY ENGINEER.

FUTURE EXTENSION ASSEMBLY FOR FORCE MAIN
NO SCALE

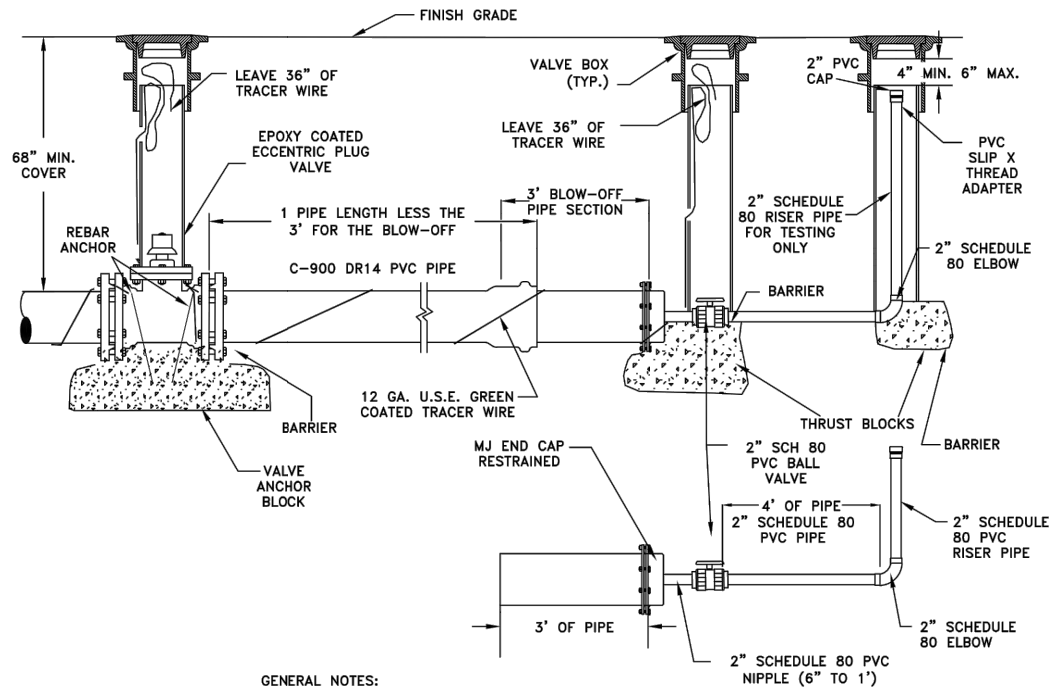


GENERAL NOTES:


1. 11 MIL. PLASTIC OR CONSTRUCTION FABRIC SHALL BE WRAPPED AROUND PIPE AND FITTINGS BEFORE THRUST BLOCK IS POURED AND BACKFILLED.
2. CONTROLLED DENSITY FILL SHALL CONSIST OF 1750# SAND, 1750# PEA GRAVEL, 230# WATER, 141# CEMENT, 6 OZ. WATER REDUCING AGENT PER 100# CEMENT.
3. THE MINIMUM DISTANCE FOR ANY TAP OR CUT-IN SHALL BE 2' FROM A BELL END OR FITTING.
4. SUPPORT VALVE AND SLEEVE CONTINUOUSLY THROUGH INSTALLATION.
5. CONNECT TO EXISTING TRACER WIRE PER DETAIL.
6. CUT-IN TEE SHALL BE EPOXY COATED 10 MILS THICK OR COATED WITH PROTECTO 401 OR APPROVED EQUAL.

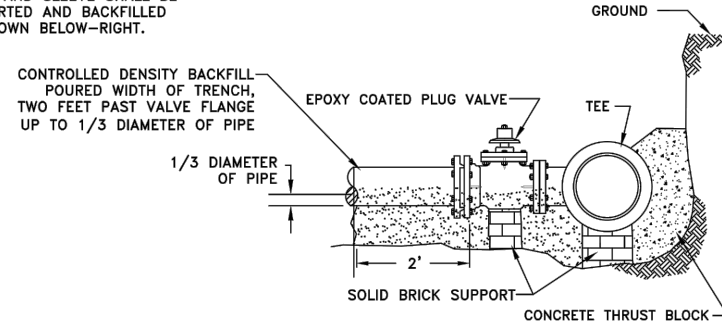

CONNECTION TO EXISTING FORCE MAIN
NO SCALE

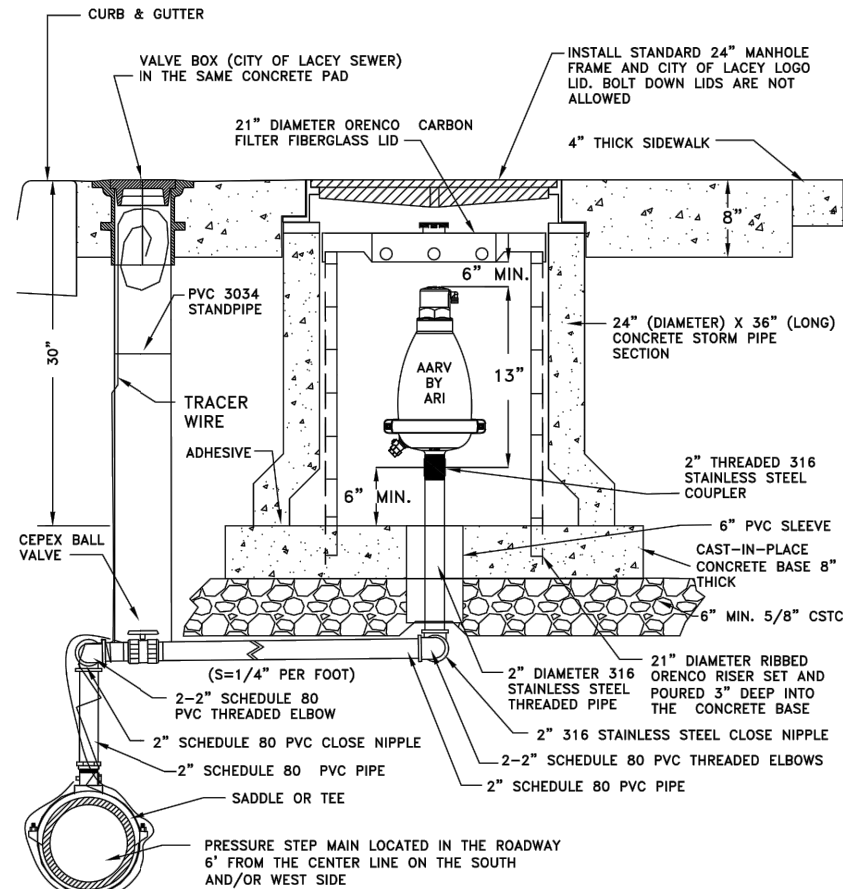

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- GENERAL NOTES:
1. CONCRETE THRUST BLOCKING TO BE POURED AGAINST UNDISTURBED EARTH.
 2. PLASTIC BARRIER SHALL BE PLACED BETWEEN ALL THRUST BLOCKS AND FITTINGS.
 3. ANCHOR REBAR SHALL BE 5/8" MINIMUM DIAMETER

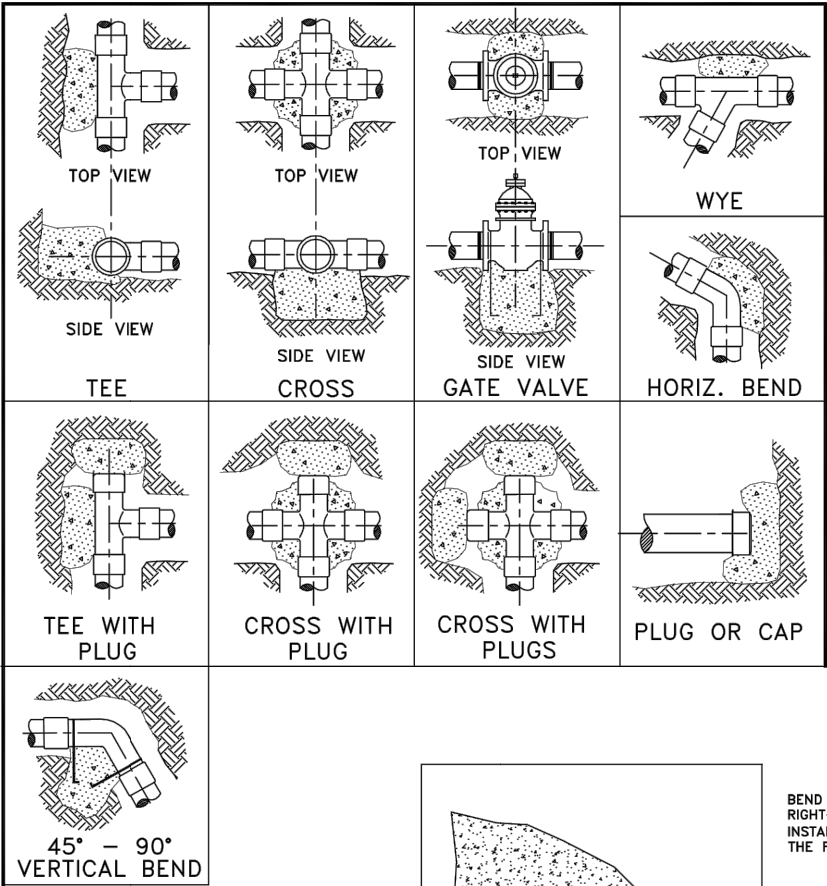
| THRUST LOADS | | | | | |
|--|----------|----------|--------------|--------------|-----------------|
| THRUST AT FITTINGS IN POUNDS AT 200 POUNDS PER SQUARE INCH OF WATER PRESSURE | | | | | |
| PIPE DIAMETER | 90° BEND | 45° BEND | 22-1/2° BEND | 11-1/4° BEND | DEAD END OR TEE |
| 4" | 3,600 | 2,000 | 1,000 | 500 | 2,600 |
| 6" | 8,000 | 4,400 | 2,300 | 1,200 | 5,700 |
| 8" | 14,300 | 7,700 | 4,000 | 2,000 | 10,100 |
| 10" | 22,300 | 12,100 | 6,200 | 3,100 | 15,800 |
| 12" | 32,000 | 17,400 | 8,900 | 4,500 | 22,700 |
| 14" | 43,600 | 23,600 | 12,100 | 6,100 | 30,800 |
| 16" | 57,000 | 30,800 | 15,700 | 7,900 | 40,300 |

- NOTES:
1. BLOCKING SHALL BE COMMERCIAL CONCRETE POURED IN PLACE AGAINST UNDISTURBED EARTH. FITTING SHALL BE ISOLATED FROM CONCRETE THRUST BLOCK WITH PLASTIC OR SIMILAR MATERIAL.
 2. TO DETERMINE THE BEARING AREA OF THE THRUST BLOCK IN SQUARE FEET (S.F.):
EXAMPLE : 12" - 90° BEND IN SAND AND GRAVEL
 $32,000 \text{ LBS} \div 3000 \text{ LB/S.F.} = 10.7 \text{ S.F. OF AREA}$
 3. AREAS MUST BE ADJUSTED FOR OTHER PIPE SIZE, PRESSURES AND SOIL CONDITIONS.
 4. BLOCKING SHALL BE ADEQUATE TO WITHSTAND FULL TEST PRESSURE AS WELL AS TO CONTINUOUSLY WITHSTAND OPERATING PRESSURE UNDER ALL CONDITIONS OF SERVICE.

SAFE SOIL BEARING LOADS

FOR HORIZONTAL THRUSTS WHEN THE DEPTH OF COVER OVER THE PIPE EXCEEDS 2 FEET


| SOIL | POUNDS PER SQUARE FOOT |
|----------------------------------|------------------------|
| MUCK, PEAT | 0 |
| SOFT CLAY | 1,000 |
| SAND | 2,000 |
| SAND & GRAVEL | 3,000 |
| SAND & GRAVEL CEMENTED WITH CLAY | 4,000 |
| HARD SHALE | 10,000 |

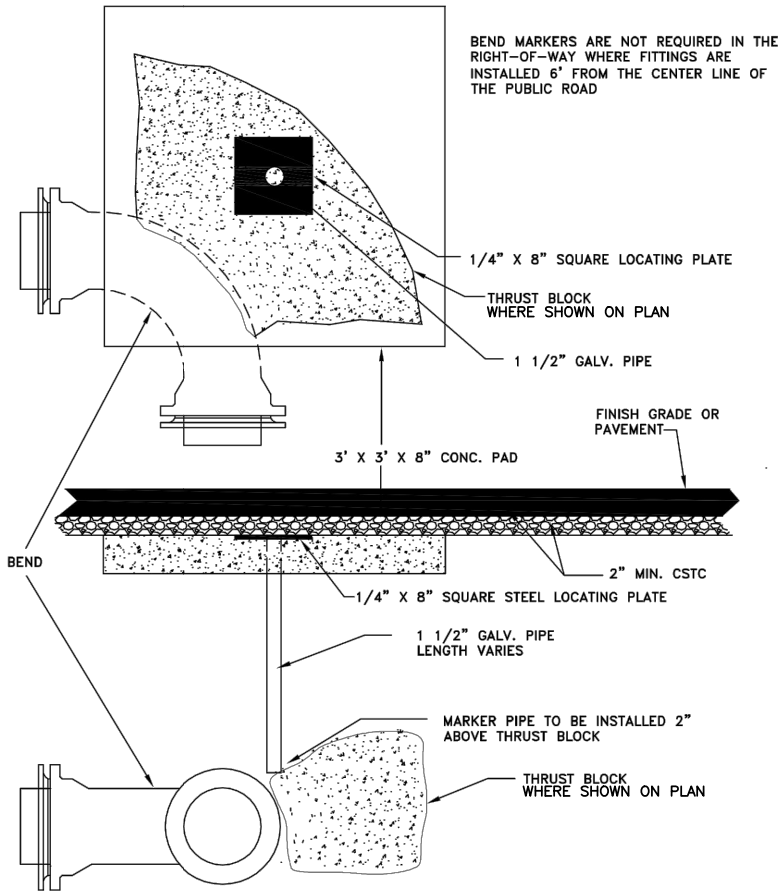

- GENERAL NOTE:
1. TO BE INSTALLED IN EASEMENTS SUCH AS GRAVEL ACCESS ROADS, PAVED PRIVATE ROADS, PARKING LOTS AND PLAY GROUNDS.


BEND MARKER TYPE I
NO SCALE

CONCRETE THRUST BLOCKS
NO SCALE

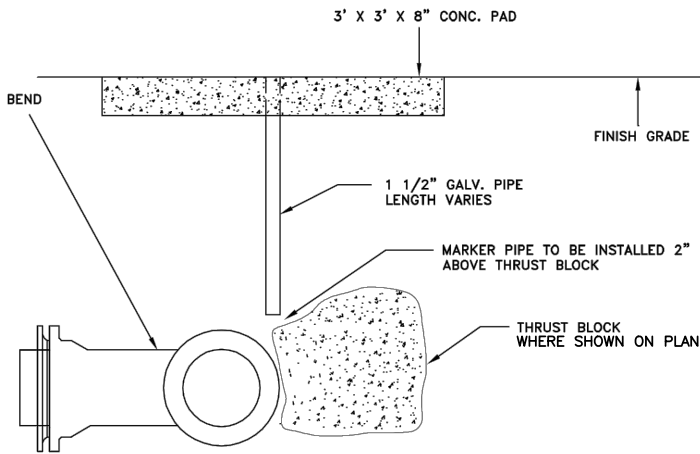

- GENERAL NOTES:
1. TO BE INSTALLED IN EASEMENTS OTHER THAN PLAY GROUNDS, PARKING LOTS, GRAVEL ACCESS OR PRIVATE ROADS.


BEND MARKER TYPE II
NO SCALE

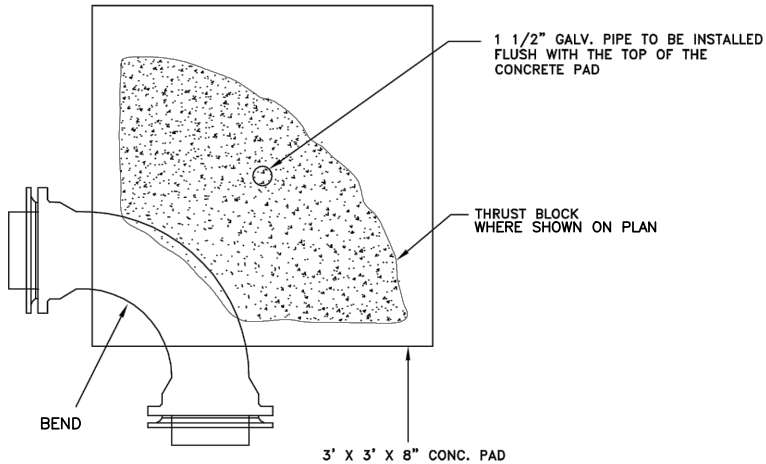

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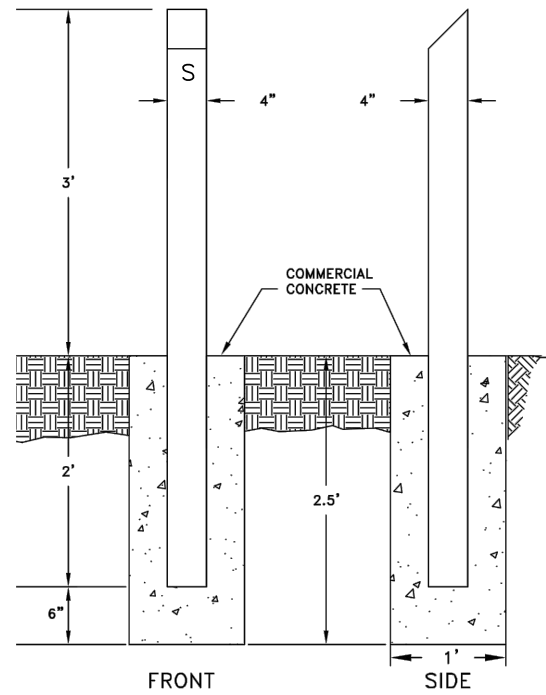
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| CARPENTER ROAD/BRITTON PARKWAY ROUNDAABOUT |
| UTILITY DETAILS |


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SEWER VALVE MARKER
NO SCALE


- GENERAL NOTES:
1. 4" SCHEDULE 40 STEEL OR REINFORCED CONCRETE MARKER POST STAMPED WITH "S" AND DISTANCE TO VALVE.
 2. THE POST TO BE COATED WITH ONE PRIME COAT AND TWO COATS OF OUTDOOR OIL BASE ENAMEL (WHITE).

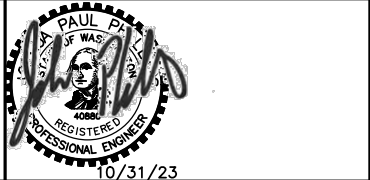

STANDARD VALVE BOX INSTALLATION
NO SCALE


- GENERAL NOTES:
1. ALL VALVES SHALL HAVE A U.S.E. 14 GAUGE BLUE COATED COPPER TRACER WIRE TIED OFF AT VALVE BODY. THE WIRE SHALL BE EXTENDED UP ON THE OUTSIDE RISER PIPE A FOOT ABOVE THE VALVE HUB BEFORE THE WIRE IS PUT INTO THE RISER THROUGH A SLOT CUT INTO THE RISER. LEAVE 36" OF WIRE ABOVE THE TOP OF VALVE BOX.
 2. ALL WELDS TO THE SHAFT SHALL BE FILLET WELD, AROUND THE ENTIRE PLATE PER #2 BELOW.

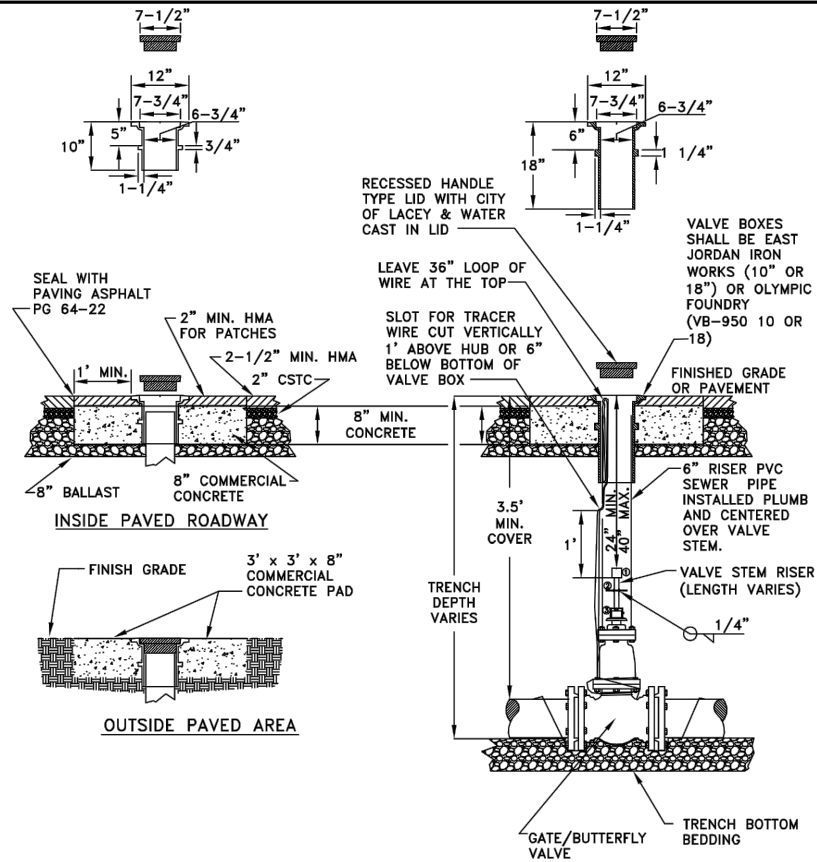- VALVE STEM EXTENSION LEGEND
- ① VALVE OPERATING NUT OR 1-7/8" X 1-7/8" X 2" HIGH GRADE STEEL WELDED TO GUIDE PLATE.
 - ② 3/16" THICK X 5 1/5" DIA STEEL GUIDE PLATE WELDED TO RISER SHAFT.
 - ③ 2"x2"x 3/16" SQUARE STRUCTURAL STEEL TUBING TO FIT OPERATING NUT. LENGTH AS REQUIRED.

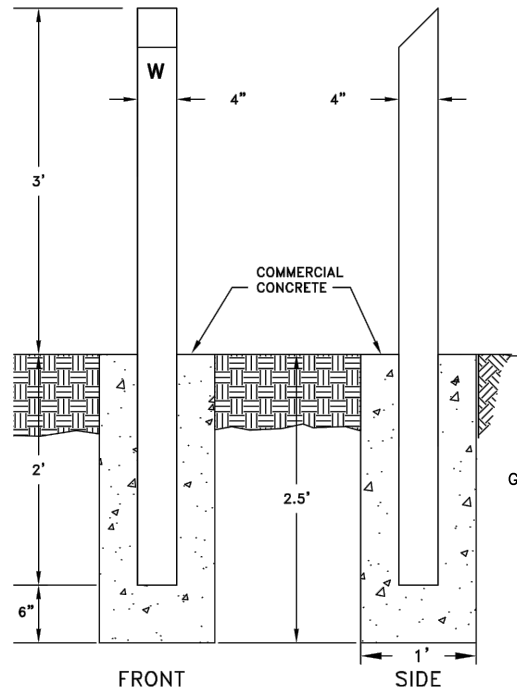

WATER VALVE MARKER
NO SCALE

- GENERAL NOTES:
1. 4" SCHEDULE 40 STEEL OR REINFORCED CONCRETE MARKER POST STAMPED WITH "W" AND DISTANCE TO VALVE.
 2. THE POST TO BE COATED WITH ONE PRIME COAT AND TWO COATS OF OUTDOOR OIL BASE ENAMEL (WHITE).

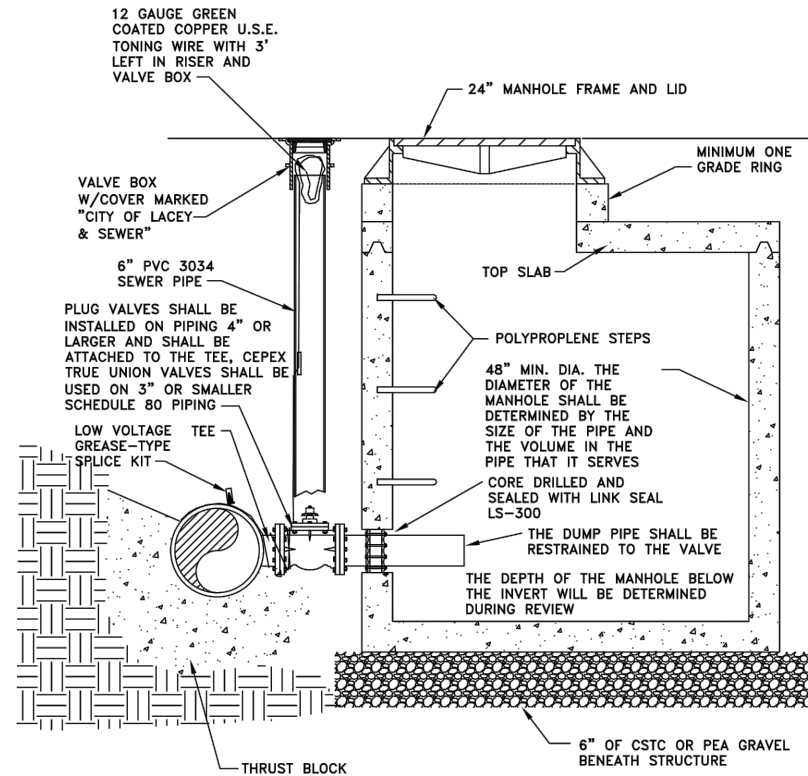


LOW POINT DRAIN FOR FORCE MAIN
NO SCALE

- GENERAL NOTES:
1. INSTALL A CONCRETE PAD WHEN LOW POINT DRAIN MANHOLE IS INSTALLED OUTSIDE OF PAVED AREA.
 2. THE MANHOLE LID SHALL BE A CITY OF LACEY "LOGO" LID. SEE DETAIL 7-3.
 3. LOW POINT DRAIN SHALL BE A 4" DIA. PLUG VALVE.
 4. SEE FORCE MAIN DETAIL 1 ON SHEET UT3 FOR VALVE AND PIPE WYE ARRANGEMENT.
 5. FOR VALVE BOX REQUIREMENTS SEE DETAIL.



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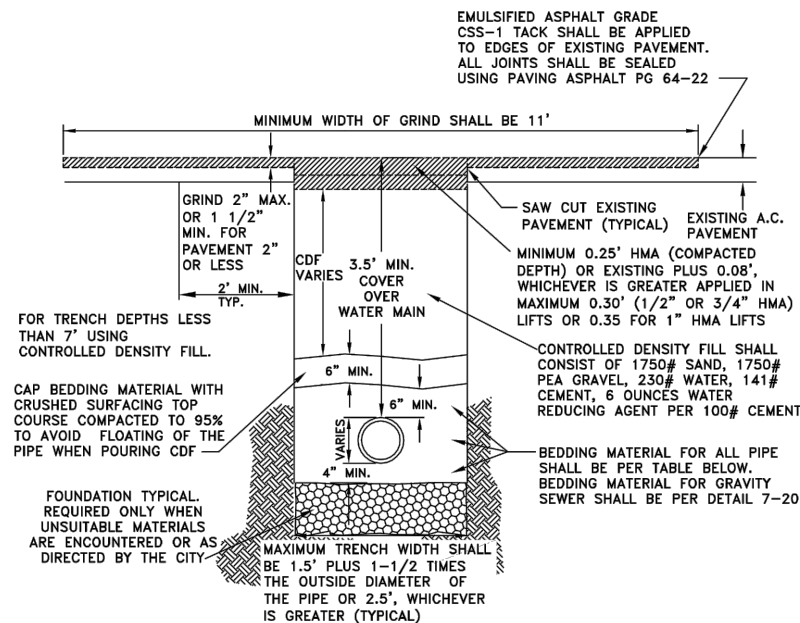
CARPENTER ROAD/BRITTON PARKWAY
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UTILITY DETAILS

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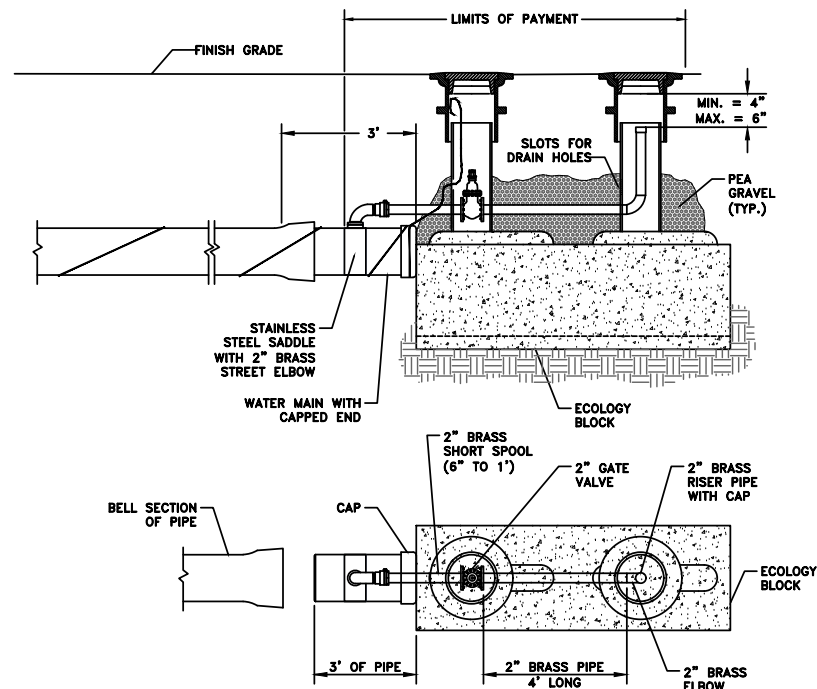
SHT 41 OF 64

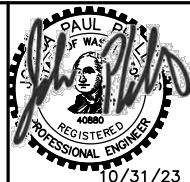

| SIEVE SIZE | PERCENT PASSING |
|--------------|-----------------|
| 3/4" SQUARE | 100 |
| 3/8" SQUARE | 70-100 |
| U.S. NO.4 | 55-100 |
| U.S. NO. 10 | 35-95 |
| U.S. NO. 20 | 20-80 |
| U.S. NO. 40 | 10-55 |
| U.S. NO. 100 | 0-10 |
| U.S. NO. 200 | 0-03 |


- GENERAL NOTES:
1. ALL MATERIALS EXCEPT H.M.A. SHALL BE COMPACTED IN 6-INCH MAXIMUM LIFTS TO 95% DENSITY AS DETERMINED BY ASTM D1557.
 2. ALL MATERIALS, WORKMANSHIP, AND INSTALLATION SHALL BE IN CONFORMANCE WITH THE WSDOT STANDARD SPECIFICATIONS FOR ROAD, BRIDGE AND MUNICIPAL CONSTRUCTION AS AMENDED BY CITY OF LACEY STANDARDS.
 3. KEEP TRENCH BOTTOM COMPACTED WITH UNIFORM GRADE. NO TEMPORARY SUPPORTS, I.E. BLOCKS, WILL BE ALLOWED TO SUPPORT PIPE. TRENCH BOTTOM SHALL BE TO GRADE PRIOR TO PIPE INSTALLATION.
 4. SUE CUT PAVEMENT TO MAX. TRENCH WIDTH. BACKFILL AND PAVE TO TOP OF EXISTING PAVEMENT FOR TRENCH WIDTH. ALLOW 24 HOURS MINIMUM FOR TRENCH PATCH TO CURE. GRIND AND PAVE FINAL PATCH AS SHOWN.

TYPICAL TRENCH FOR WATER MAIN
NO SCALE




- GENERAL NOTES:**
- ALL 2" PIPING AND FITTINGS SHALL BE DOMESTIC BRASS.**

BLOWOFF EXTENSION ASSEMBLY FOR WATER MAIN
NO SCALE

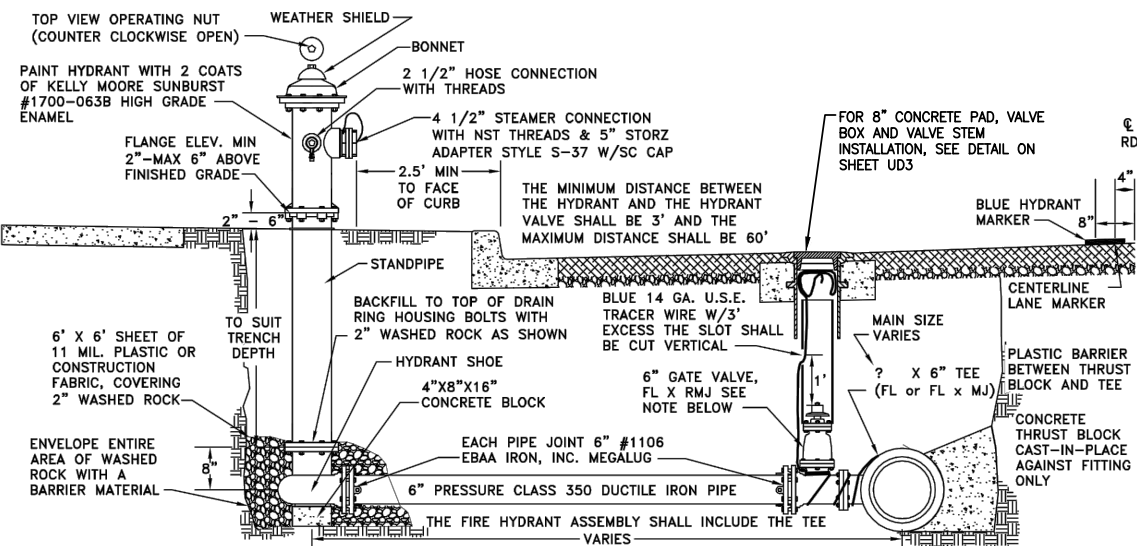

- NOTES:
1. A MINIMUM FIVE FOOT RADIUS OF UNOBSTRUCTED WORKING AREA SHALL BE PROVIDED AROUND ALL HYDRANTS. THE UNOBSTRUCTED AREA SHALL INCLUDE BUT NOT BE LIMITED TO TREES, SHRUBS, PLANTS, VAULTS, FDC, AND METERS.
 2. HYDRANTS SHALL BE WATEROUS PACER, M&H RELIANT STYLE 929, AMERICAN AVK, KENNEDY K-81, MUELLER CENTURION, OR CLOW MEDALLION.
 3. GATE VALVES SHALL BE RESILIENT WEDGE NRS WITH O-RING SEALS. VALVE ENDS SHALL BE MECHANICAL JOINT BY ANSI FLANGES. VALVES SHALL CONFORM TO AWWA 509-80. VALVES SHALL BE MUELLER, M&H, KENNEDY, CLOW R/W OR WATEROUS SERIES 500.
 4. REMOVE FACTORY CHAINS HOLDING CAPS.
 5. WHEN DISTANCE BETWEEN HYDRANT AND VALVE EXCEED 20 FEET, FIELDLOK GASKETS SHALL BE ALLOWED.
 6. INSTALLATION OF THE TYPE 2E TWO WAY BLUE REFLECTIVE HYDRANT MARKER SHALL BE THE RESPONSIBILITY OF THE CONTRACTOR.
 7. THE TYPE 2E TWO WAY BLUE REFLECTIVE HYDRANT MARKER SHALL BE ALIGNED WITH THE OUTSIDE EDGE OF THE LANE MARKER OR 8" FROM THE CENTER OF THE RPM TO THE CENTER LINE OF THE ROADWAY. SEE STRIPING DETAIL ON SHEET CHD2 FOR LOCATION.

FIRE HYDRANT ASSEMBLY
NO SCALE

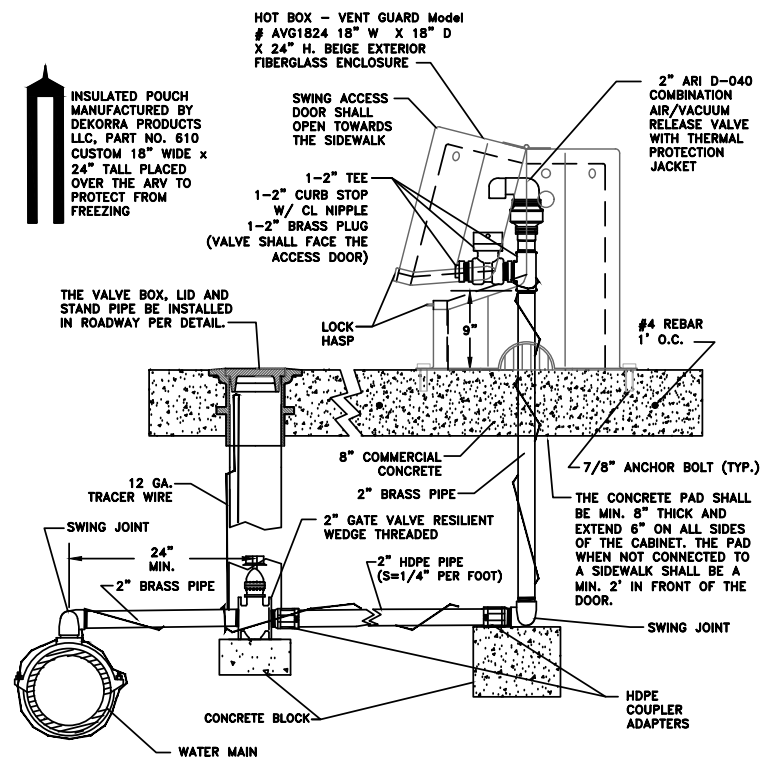


- GENERAL NOTES:
1. VALVE ASSEMBLY SHALL BE SET AT THE HIGH POINT OF THE LINE.
 2. ALL AIR/VACUUM RELEASE VALVES SHALL BE INSTALLED BEHIND THE EDGE OF PAVEMENT NEAR THE PROPERTY CORNER.
 3. AIR RELEASE VALVES SHALL BE 2" ARI D-040 W/THERMO PROTECTION ENCASMENT.
 4. ALL FITTINGS AND PIPING SHALL BE DOMESTIC BRASS.
 5. CABINET SHALL OPEN AWAY FROM THE ROADWAY.
 6. INSTALL THE INSULATED POUCH 602-DT OVER THE ARV UNIT TO PROTECT IT FROM FREEZING.

AIR AND VACUUM RELEASE ASSEMBLY
NO SCALE

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CARPENTER ROAD/BRITTON PARKWAY ROUNDBABOUT



UTILITY DETAILS
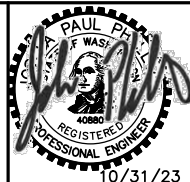
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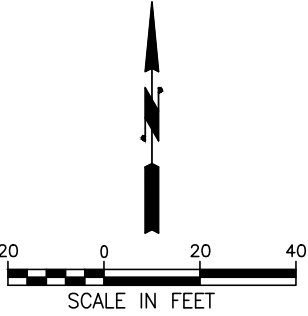


GENERAL NOTES:

1. DIMENSIONS ARE TO FACE OF CURB, EDGE OF PAVEMENT, OR CENTER OF STRIPE.
2. PAVEMENT MARKING STATIONS ARE TO CENTER OF MARKING.
3. BREAK STRIPING AT CROSSWALKS.
4. PAVEMENT MARKING LAYOUT SHALL BE VERIFIED BY THE ENGINEER AT LEAST 72 HOURS BEFORE STRIPING BEGINS.
5. THE BID ITEM FOR ENTRY LINE SHALL BE CROSSWALK LINE.
6. ALL ROUNDABOUT CHANNELIZATION SHALL BE TYPE B PRE-FORMED FUSED THERMOPLASTIC.

CONSTRUCTION NOTES:

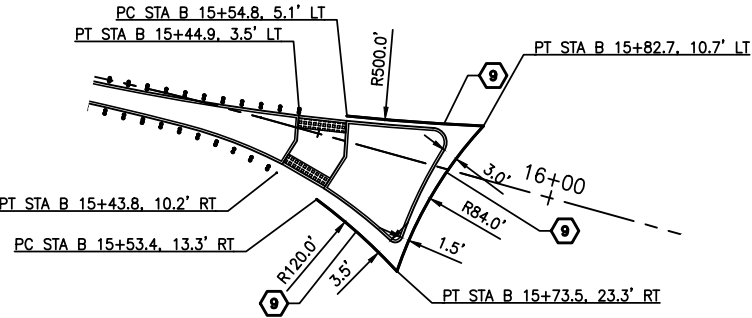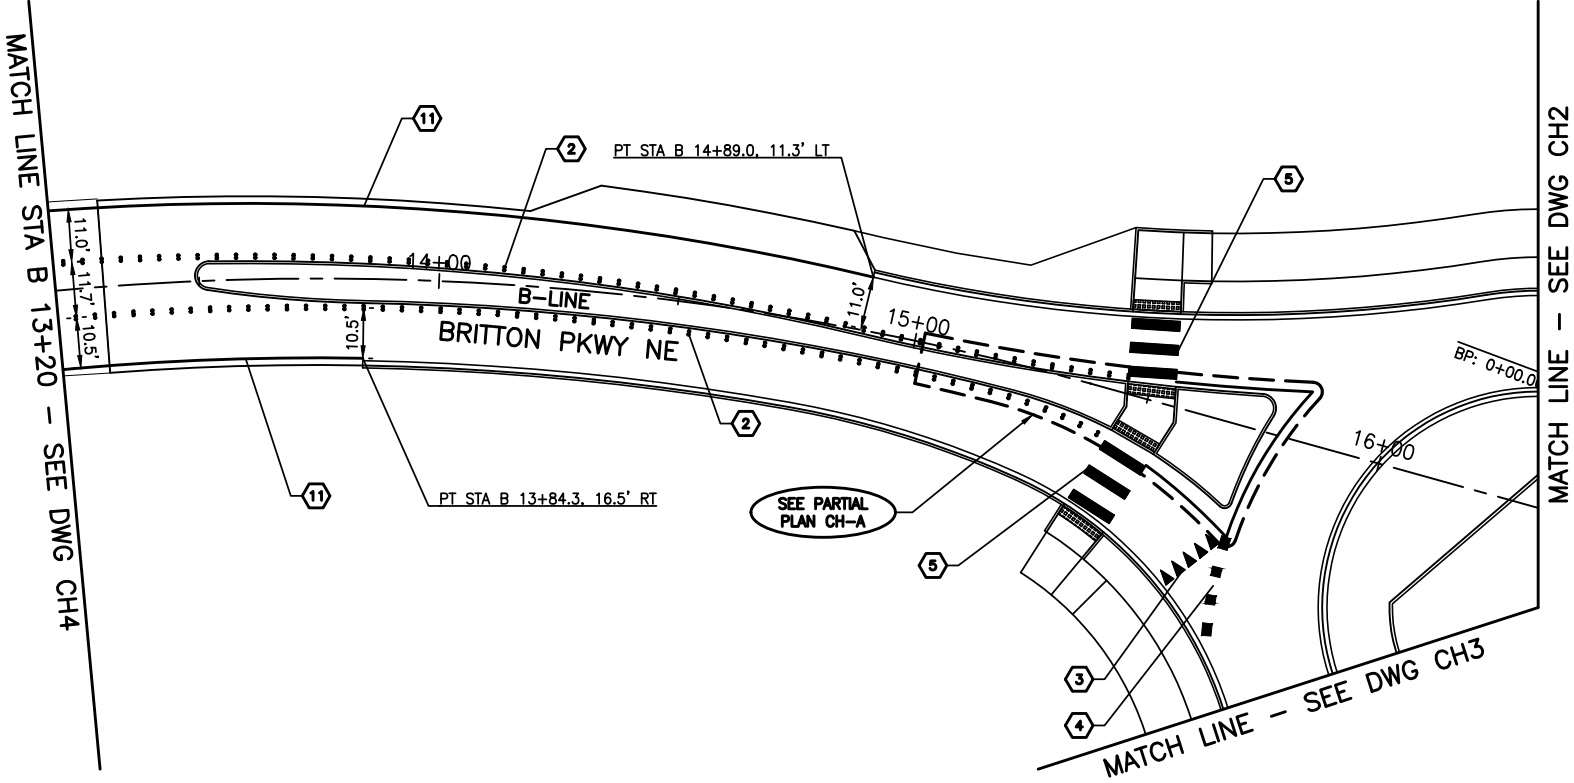- ① RPM GORE STRIPE
- ② RPM DOUBLE YELLOW CENTER STRIPE
- ③ PLASTIC YIELD LINE SYMBOLS
- ④ PLASTIC ENTRY LINE
- ⑤ PLASTIC CROSSWALK LINES
- ⑥ PLASTIC BIKE LANE/GORE LINE
- ⑦ BIKE LANE ARROW AND BSF SYMBOL
- ⑧ PLASTIC LEFT TRAFFIC ARROW
- ⑨ WHITE WIDE LANE LINE
- ⑩ PLASTIC BIKE LANE SKIP LINE
- ⑪ WHITE EDGE LINE
- ⑫ 8' LETTERS (ONLY)



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CARPENTER ROAD/BRITTON PARKWAY
ROUNDABOUT

CHANNELIZATION PLAN




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- GENERAL NOTES:**
- 1. DIMENSIONS ARE TO FACE OF CURB, EDGE OF PAVEMENT, OR CENTER OF STRIPE.
 - 2. PAVEMENT MARKING STATIONS ARE TO CENTER OF MARKING.
 - 3. BREAK STRIPING AT CROSSWALKS.
 - 4. PAVEMENT MARKING LAYOUT SHALL BE VERIFIED BY THE ENGINEER AT LEAST 72 HOURS BEFORE STRIPING BEGINS.
 - 5. THE BID ITEM FOR ENTRY LINE SHALL BE CROSSWALK LINE.
 - 6. ALL ROUNDABOUT CHANNELIZATION SHALL BE TYPE B PRE-FORMED FUSED THERMOPLASTIC.

- CONSTRUCTION NOTES:**
- ① RPM GORE STRIPE
 - ② RPM DOUBLE YELLOW CENTER STRIPE
 - ③ PLASTIC YIELD LINE SYMBOLS
 - ④ PLASTIC ENTRY LINE
 - ⑤ PLASTIC CROSSWALK LINES
 - ⑥ PLASTIC BIKE LANE/GORE LINE
 - ⑦ BIKE LANE ARROW AND BSF SYMBOL
 - ⑧ PLASTIC LEFT TRAFFIC ARROW
 - ⑨ WHITE WIDE LANE LINE
 - ⑩ PLASTIC BIKE LANE SKIP LINE
 - ⑪ WHITE EDGE LINE
 - ⑫ 8' LETTERS (ONLY)



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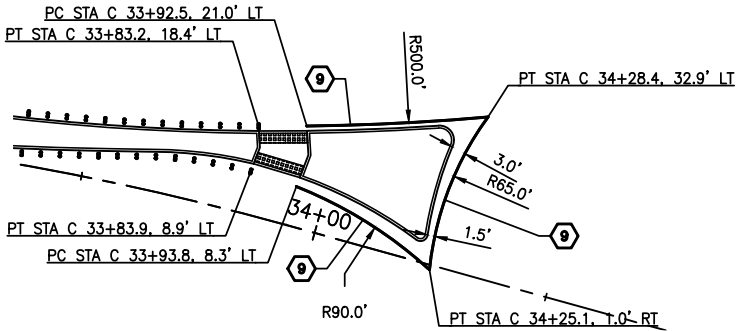
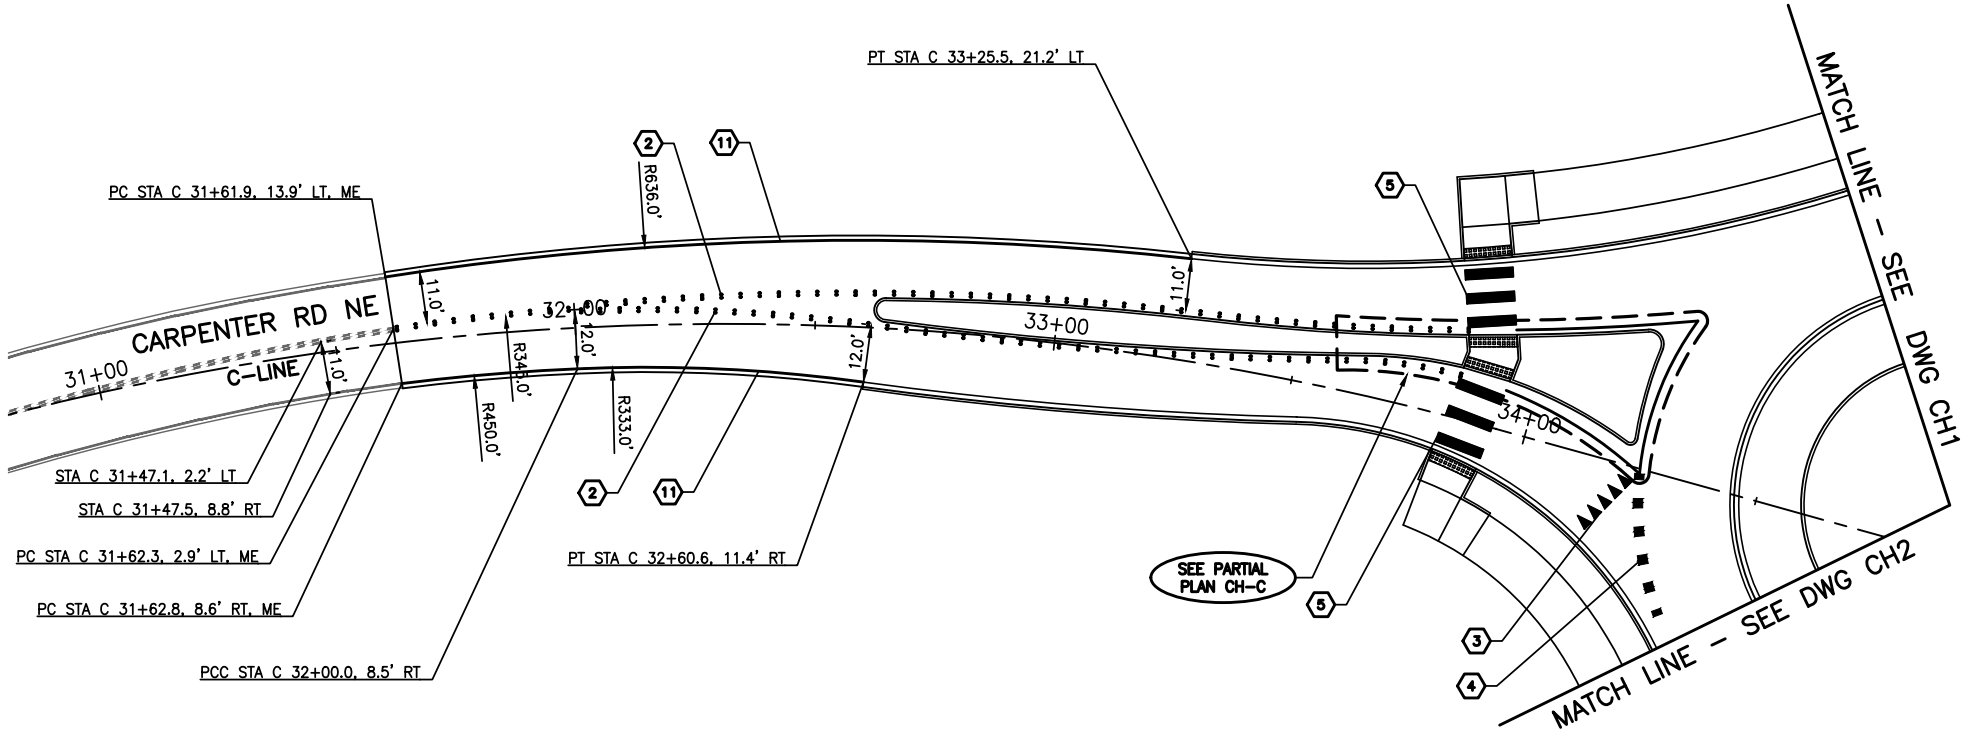
CARPENTER ROAD/BRITTON PARKWAY
ROUNDABOUT

CHANNELIZATION PLAN

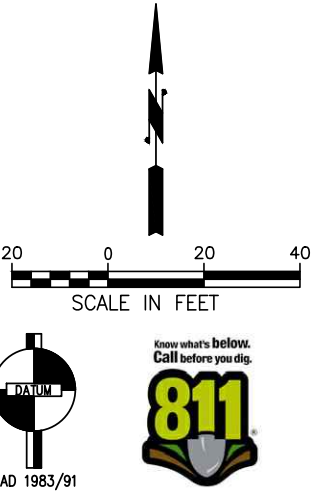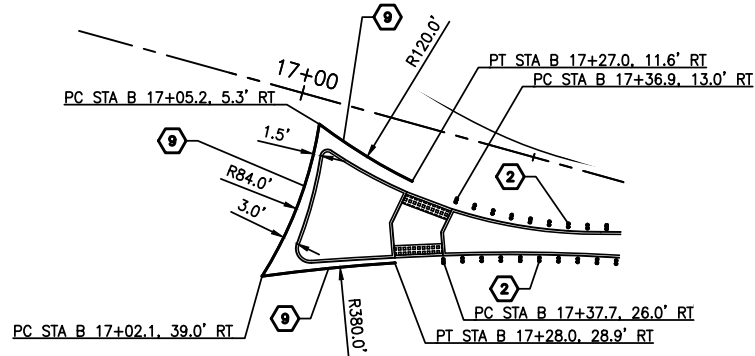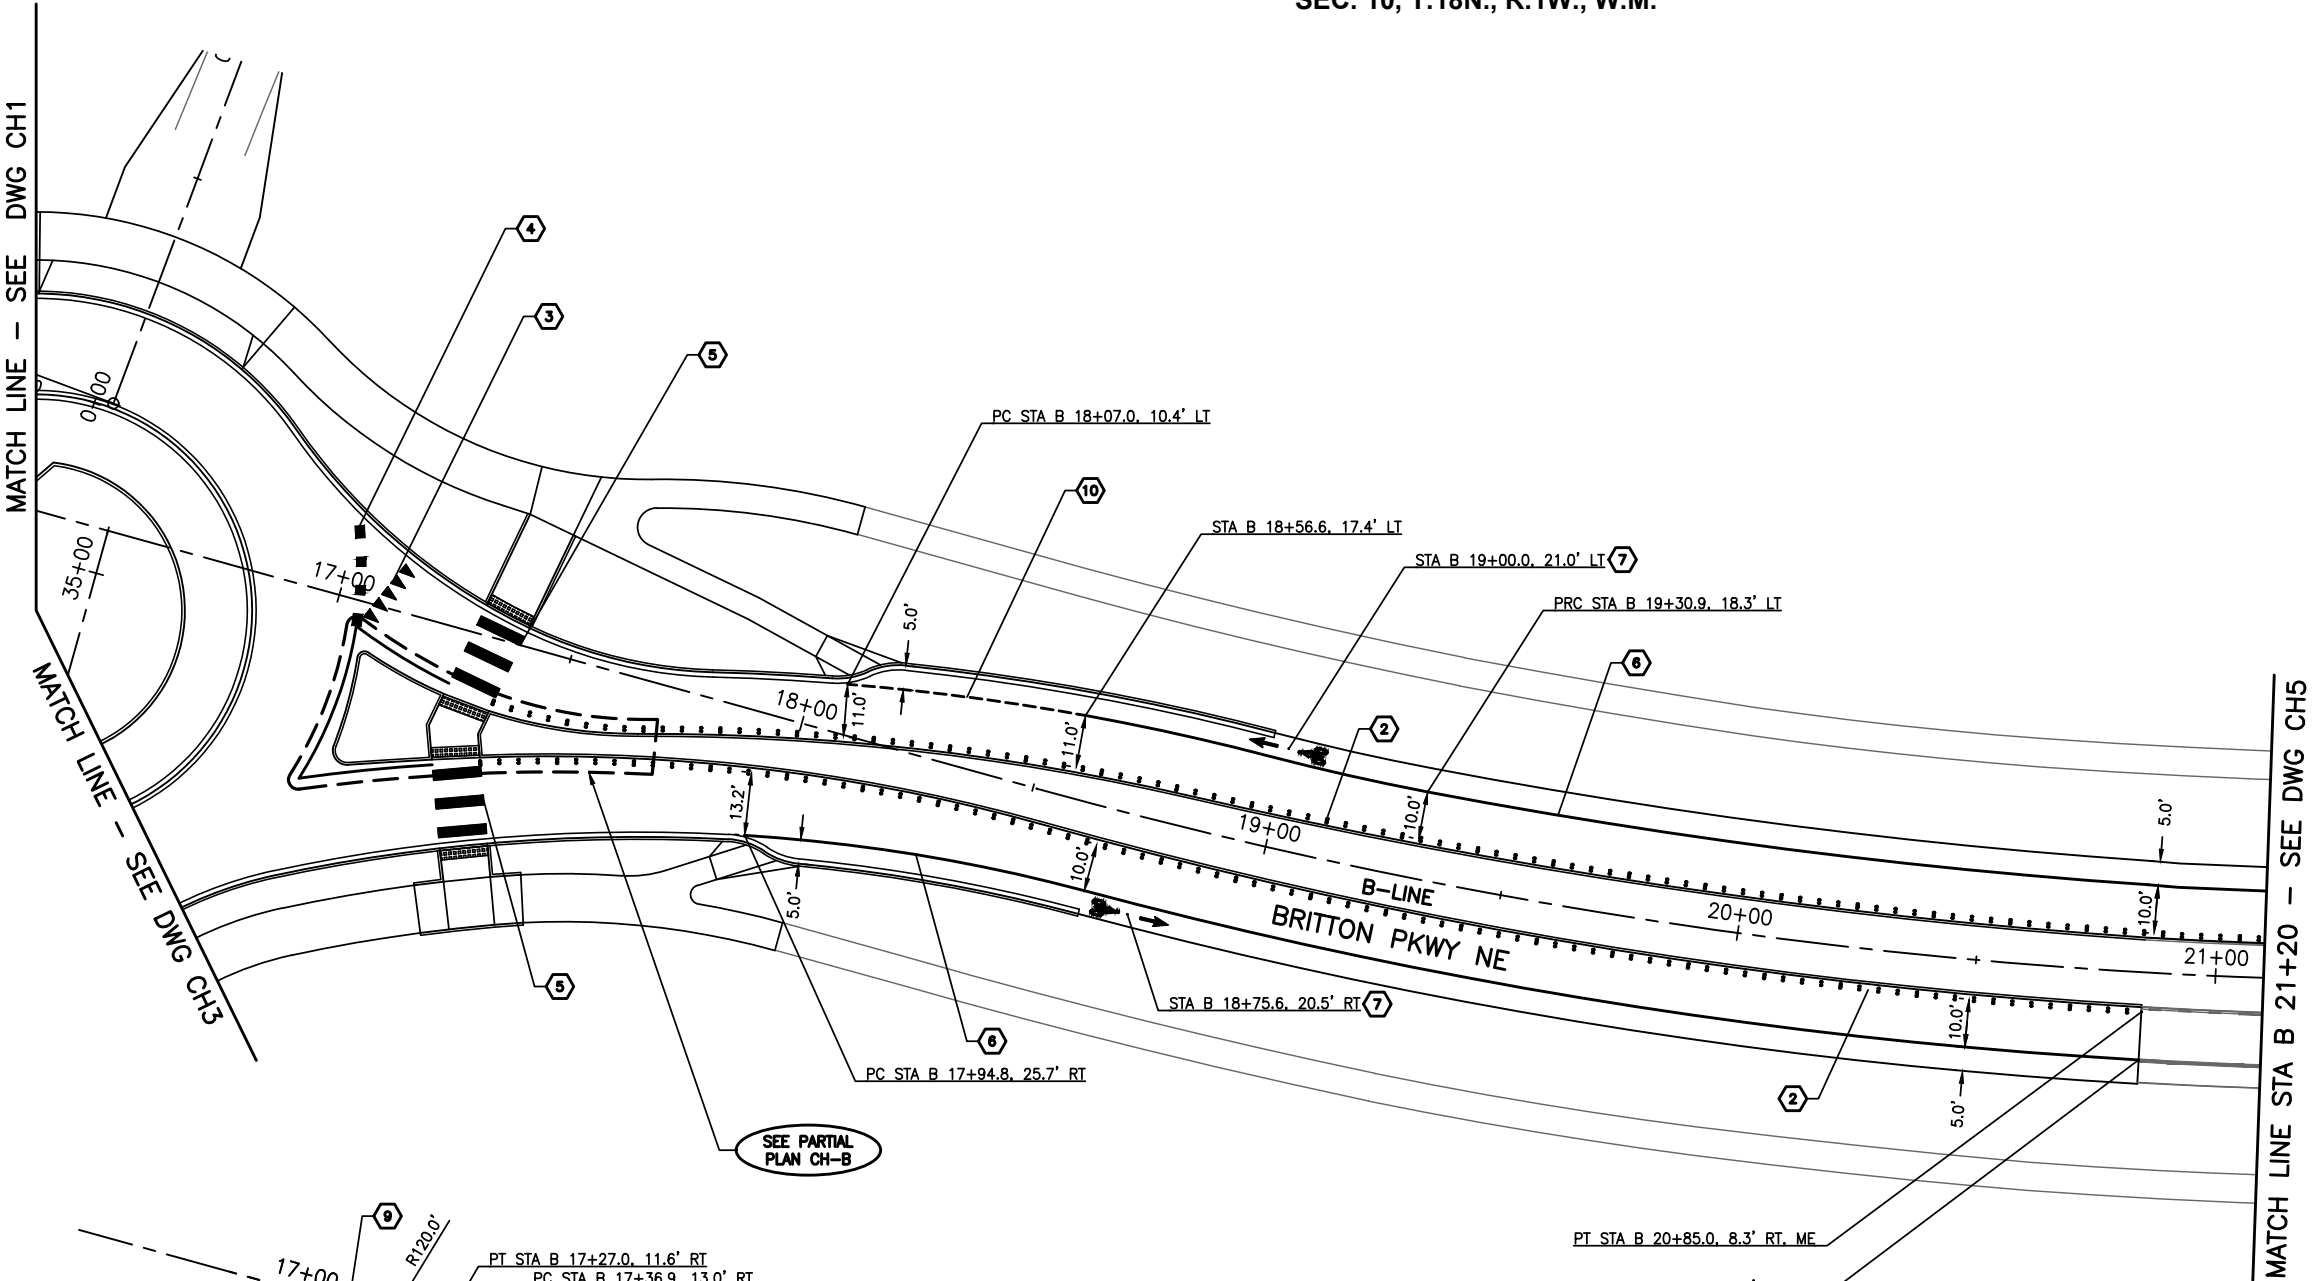DRAWING NUMBER

CH2

SHT 44 OF 64




PARTIAL PLAN CH-C

GENERAL NOTES:

1. DIMENSIONS ARE TO FACE OF CURB, EDGE OF PAVEMENT, OR CENTER OF STRIPE.
2. PAVEMENT MARKING STATIONS ARE TO CENTER OF MARKING.
3. BREAK STRIPING AT CROSSWALKS.
4. PAVEMENT MARKING LAYOUT SHALL BE VERIFIED BY THE ENGINEER AT LEAST 72 HOURS BEFORE STRIPING BEGINS.
5. THE BID ITEM FOR ENTRY LINE SHALL BE CROSSWALK LINE.
6. ALL ROUNDABOUT CHANNELIZATION SHALL BE TYPE B PRE-FORMED FUSED THERMOPLASTIC.

CONSTRUCTION NOTES:

- ① RPM GORE STRIPE
- ② RPM DOUBLE YELLOW CENTER STRIPE
- ③ PLASTIC YIELD LINE SYMBOLS
- ④ PLASTIC ENTRY LINE
- ⑤ PLASTIC CROSSWALK LINES
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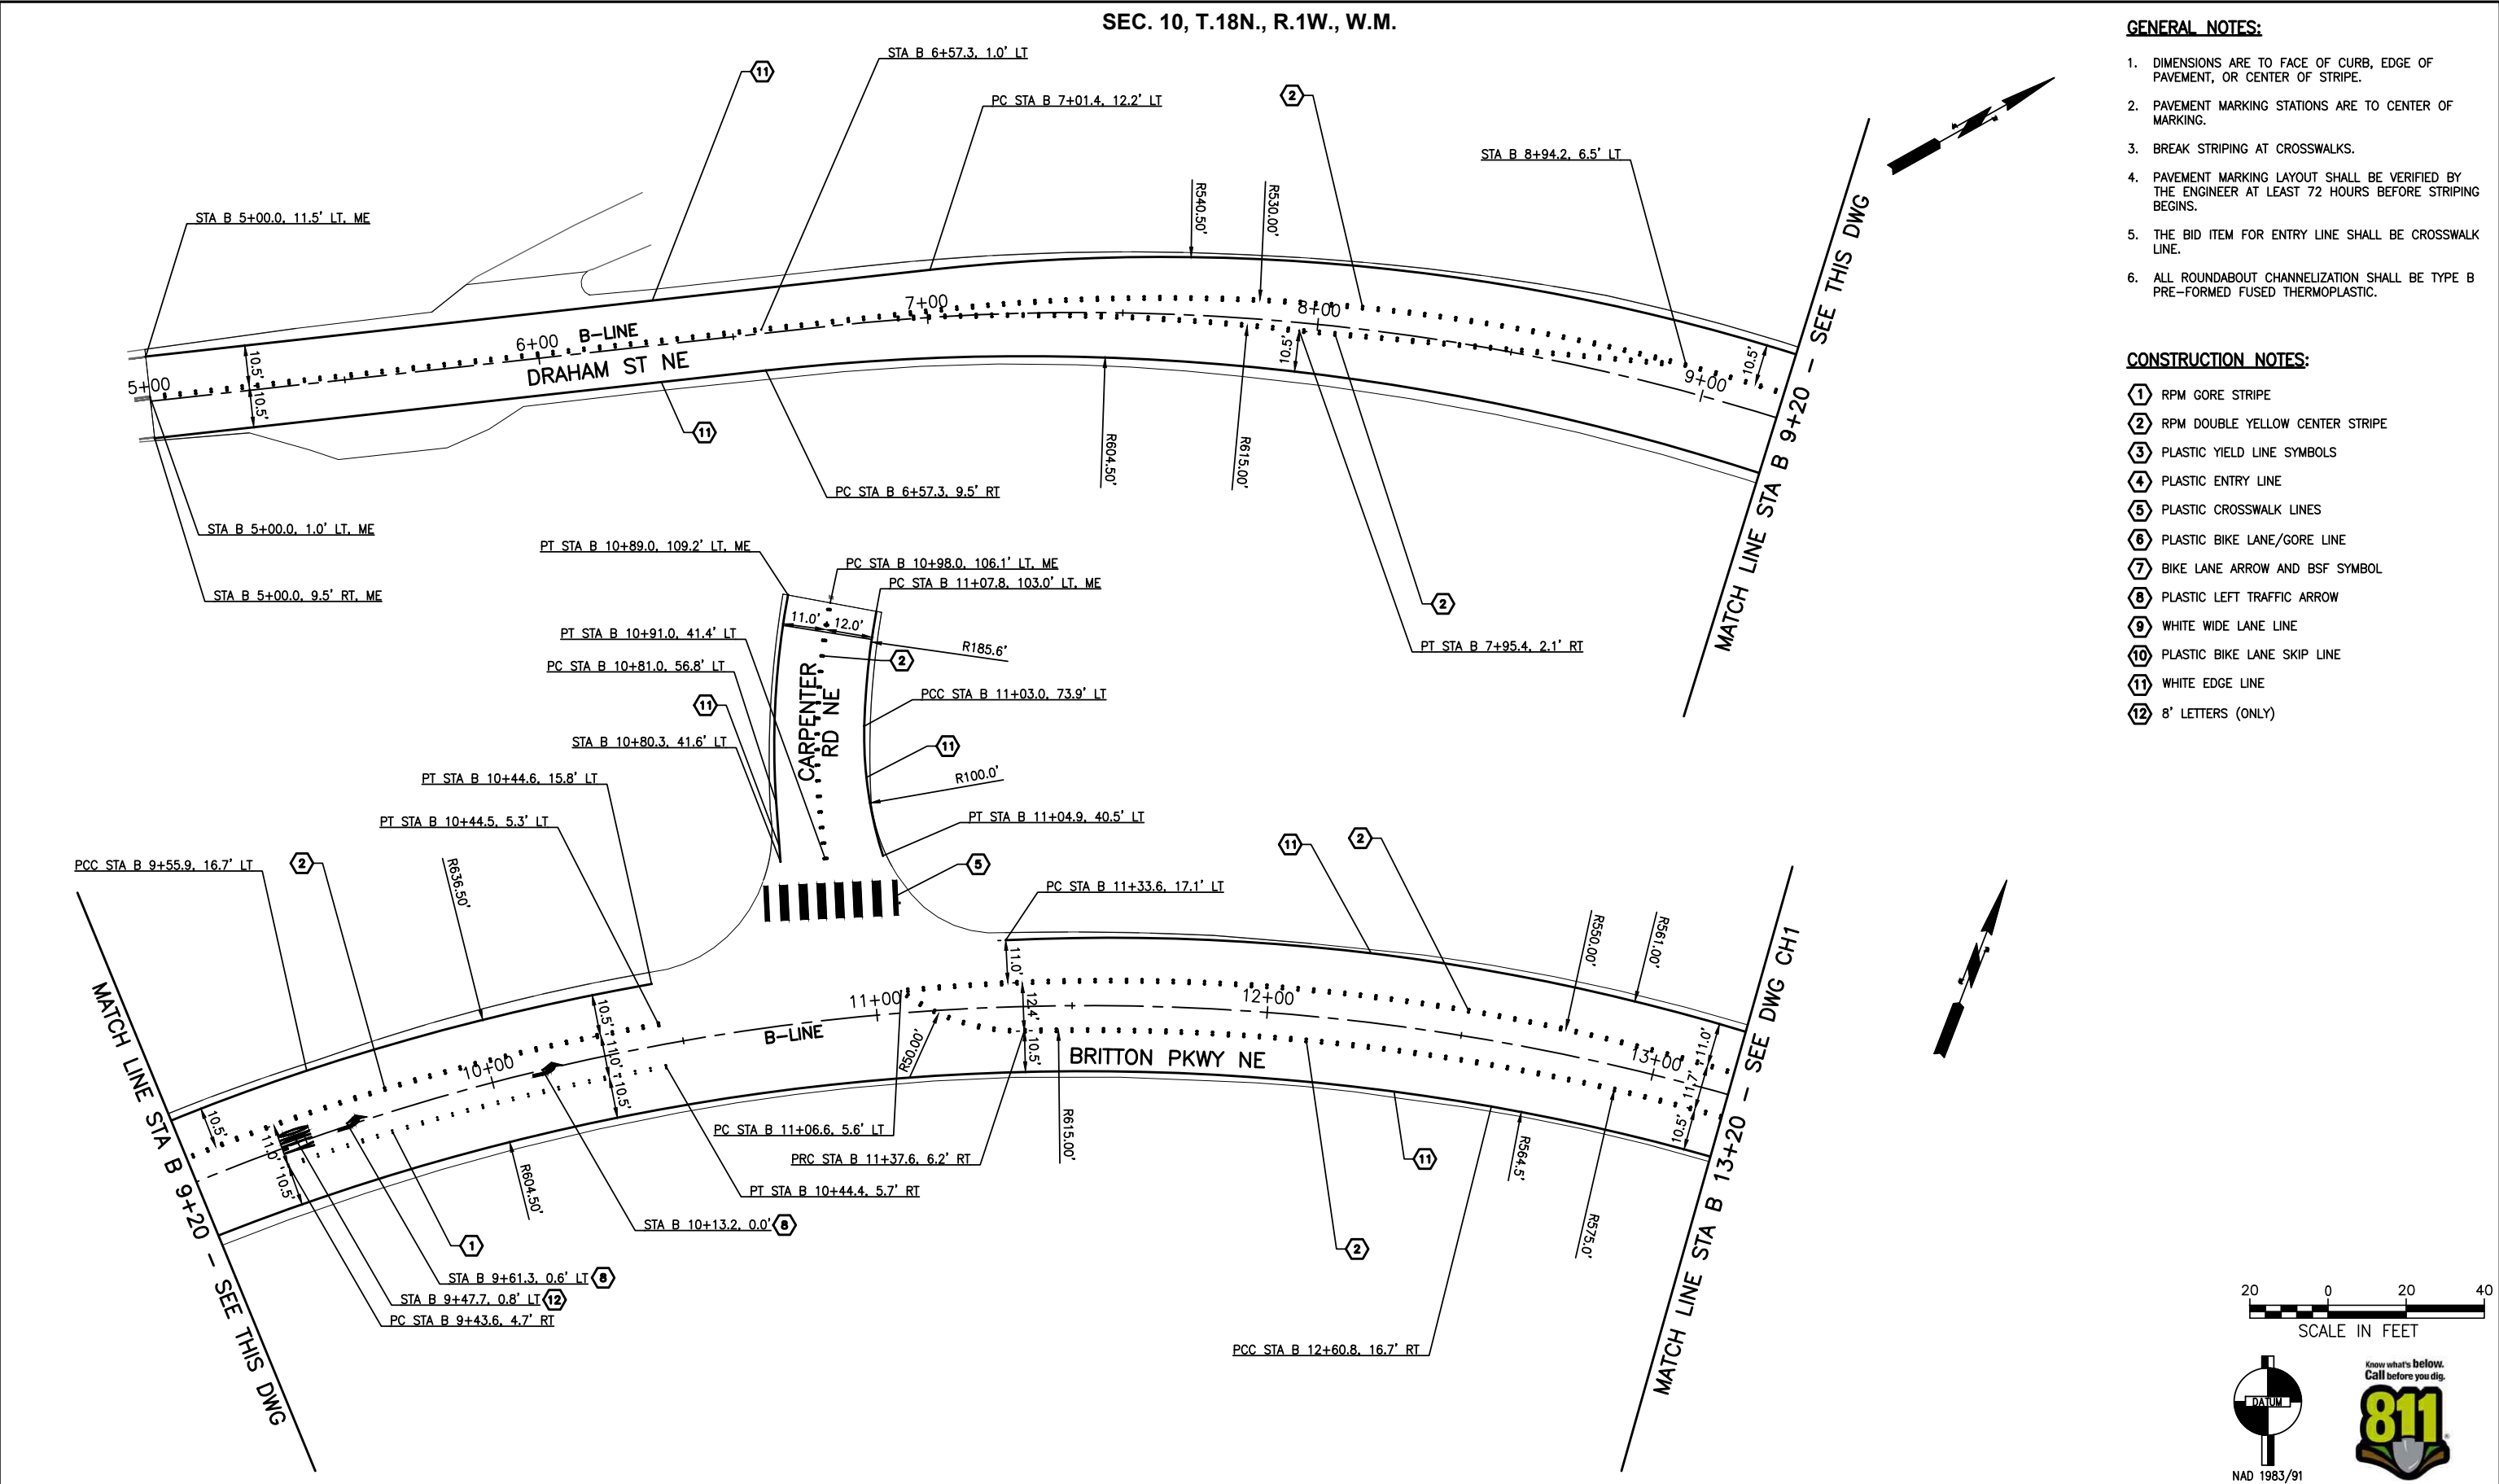
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| CARPENTER ROAD/BRITTON PARKWAY ROUNDABOUT |
| CHANNELIZATION PLAN |
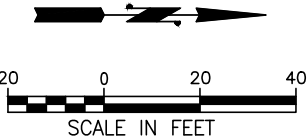
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CARPENTER ROAD/BRITTON PARKWAY
ROUNDABOUT


CHANNELIZATION PLAN

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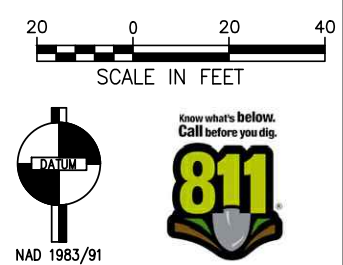
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- GENERAL NOTES:**
1. DIMENSIONS ARE TO FACE OF CURB, EDGE OF PAVEMENT, OR CENTER OF STRIPE.
 2. PAVEMENT MARKING STATIONS ARE TO CENTER OF MARKING.
 3. BREAK STRIPING AT CROSSWALKS.
 4. PAVEMENT MARKING LAYOUT SHALL BE VERIFIED BY THE ENGINEER AT LEAST 72 HOURS BEFORE STRIPING BEGINS.
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 6. ALL ROUNDABOUT CHANNELIZATION SHALL BE TYPE B PRE-FORMED FUSED THERMOPLASTIC.

- CONSTRUCTION NOTES:**
- ① RPM GORE STRIPE
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 - ③ PLASTIC YIELD LINE SYMBOLS
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CARPENTER ROAD/BRITTON PARKWAY
ROUNDABOUT
CHANNELIZATION PLAN

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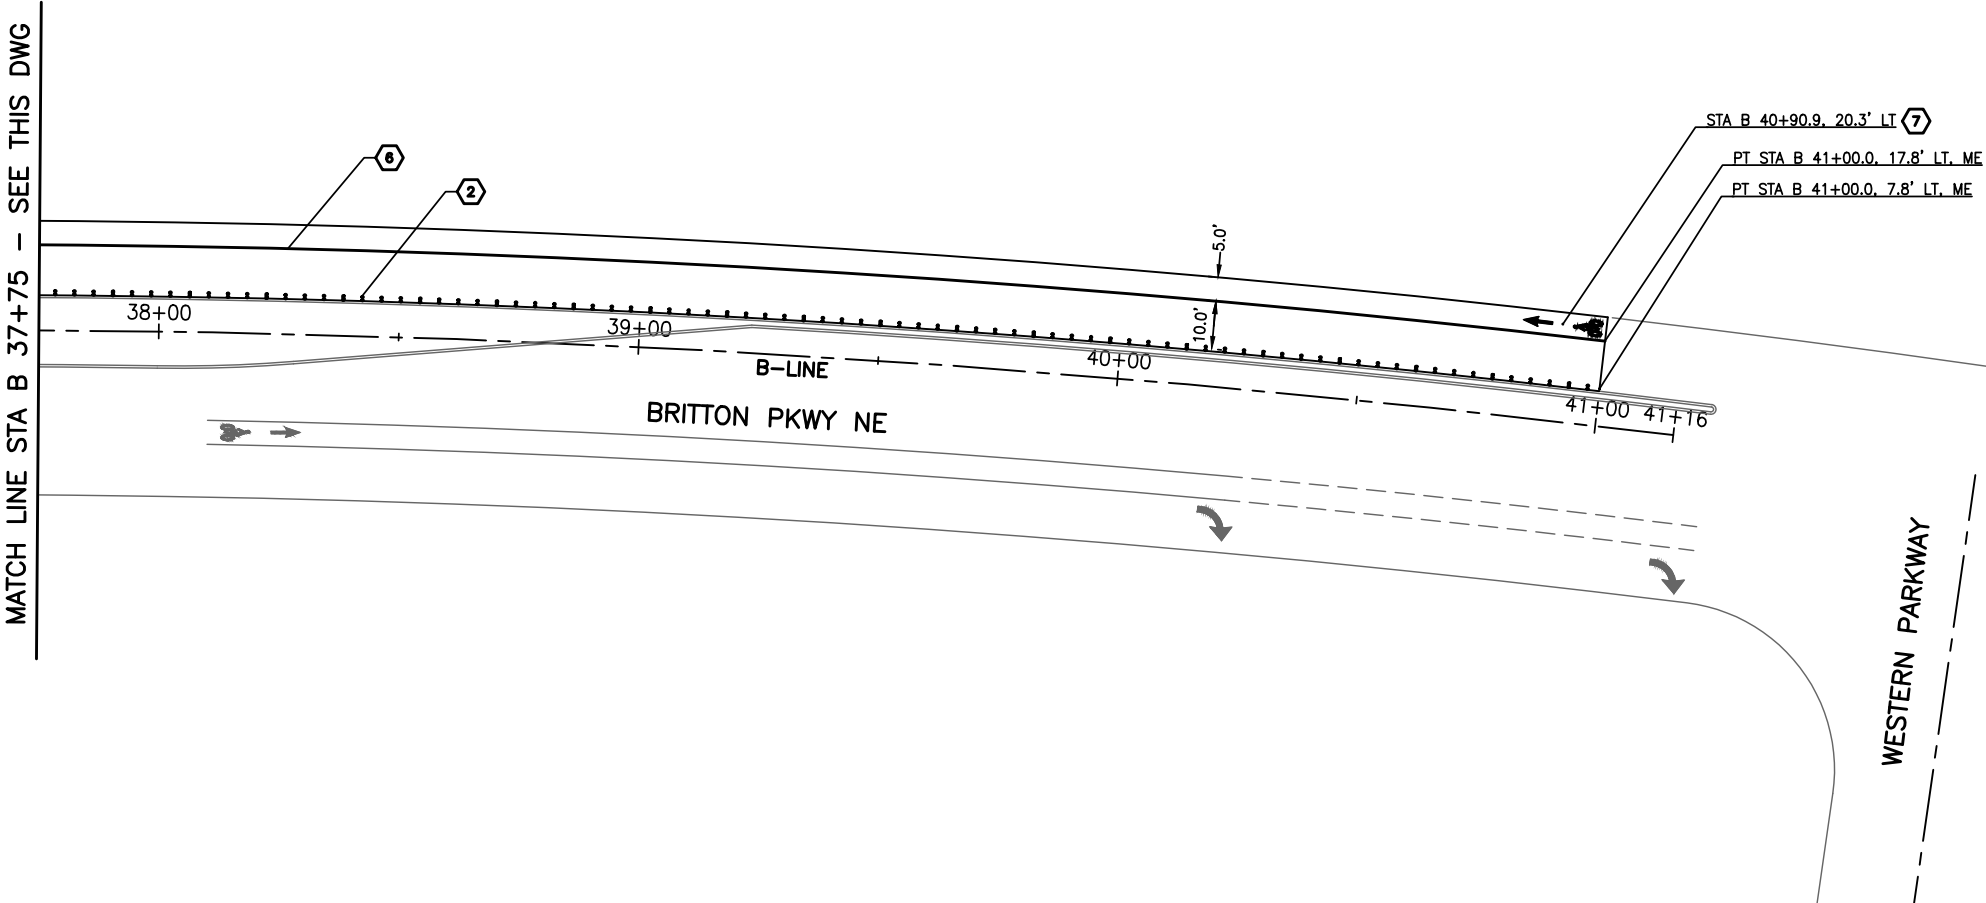
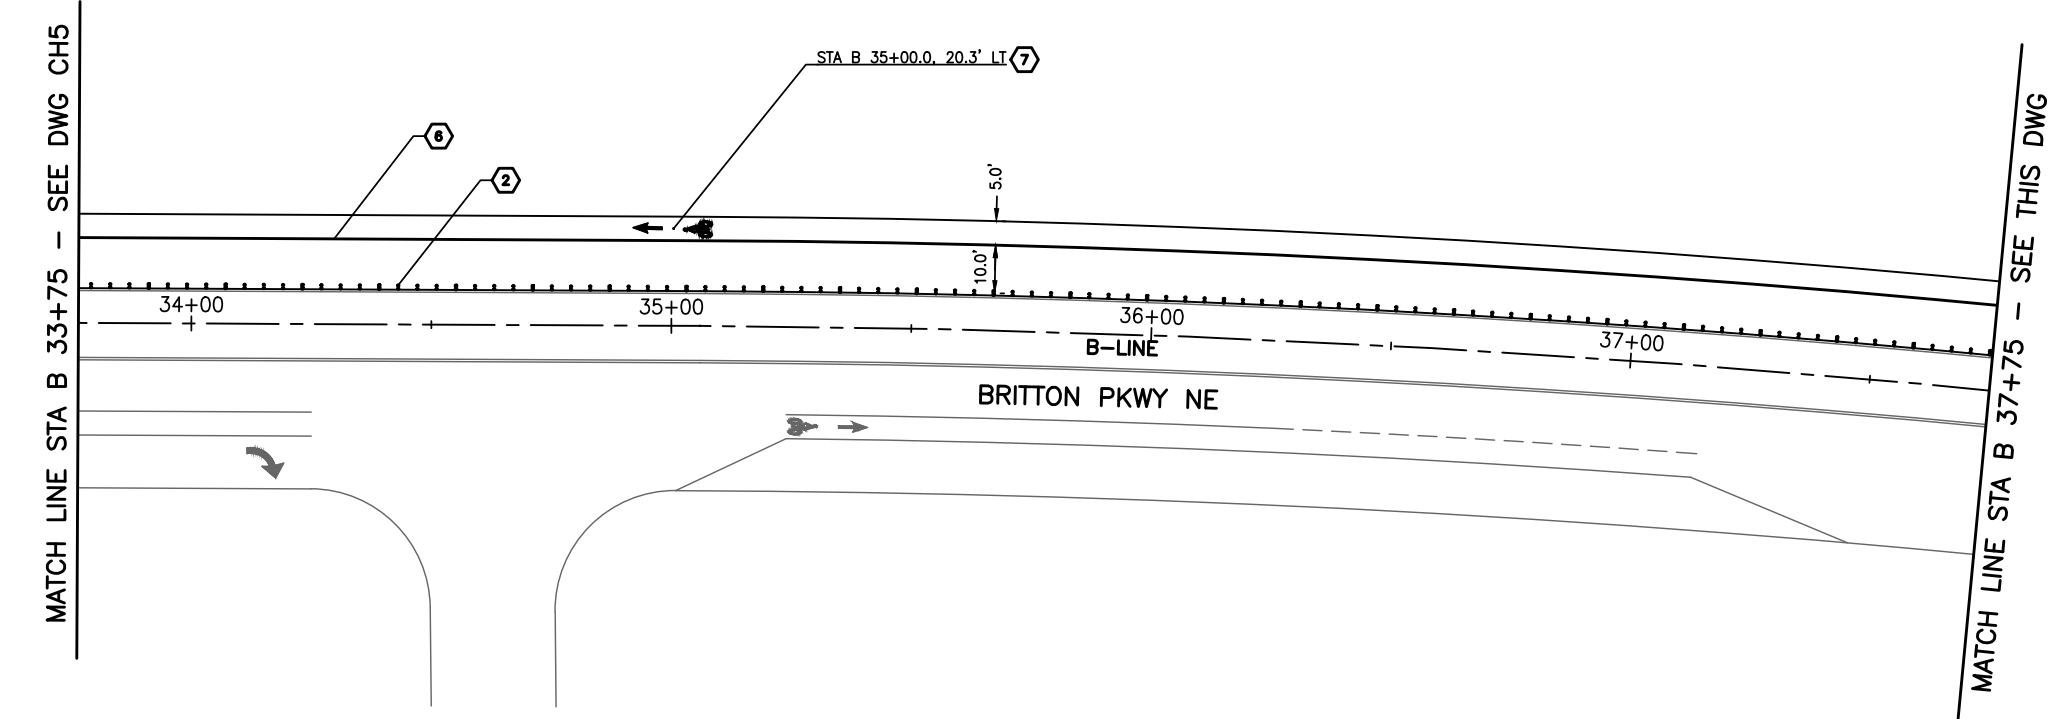
SEC. 10, T.18N., R.1W., W.M.

GENERAL NOTES:

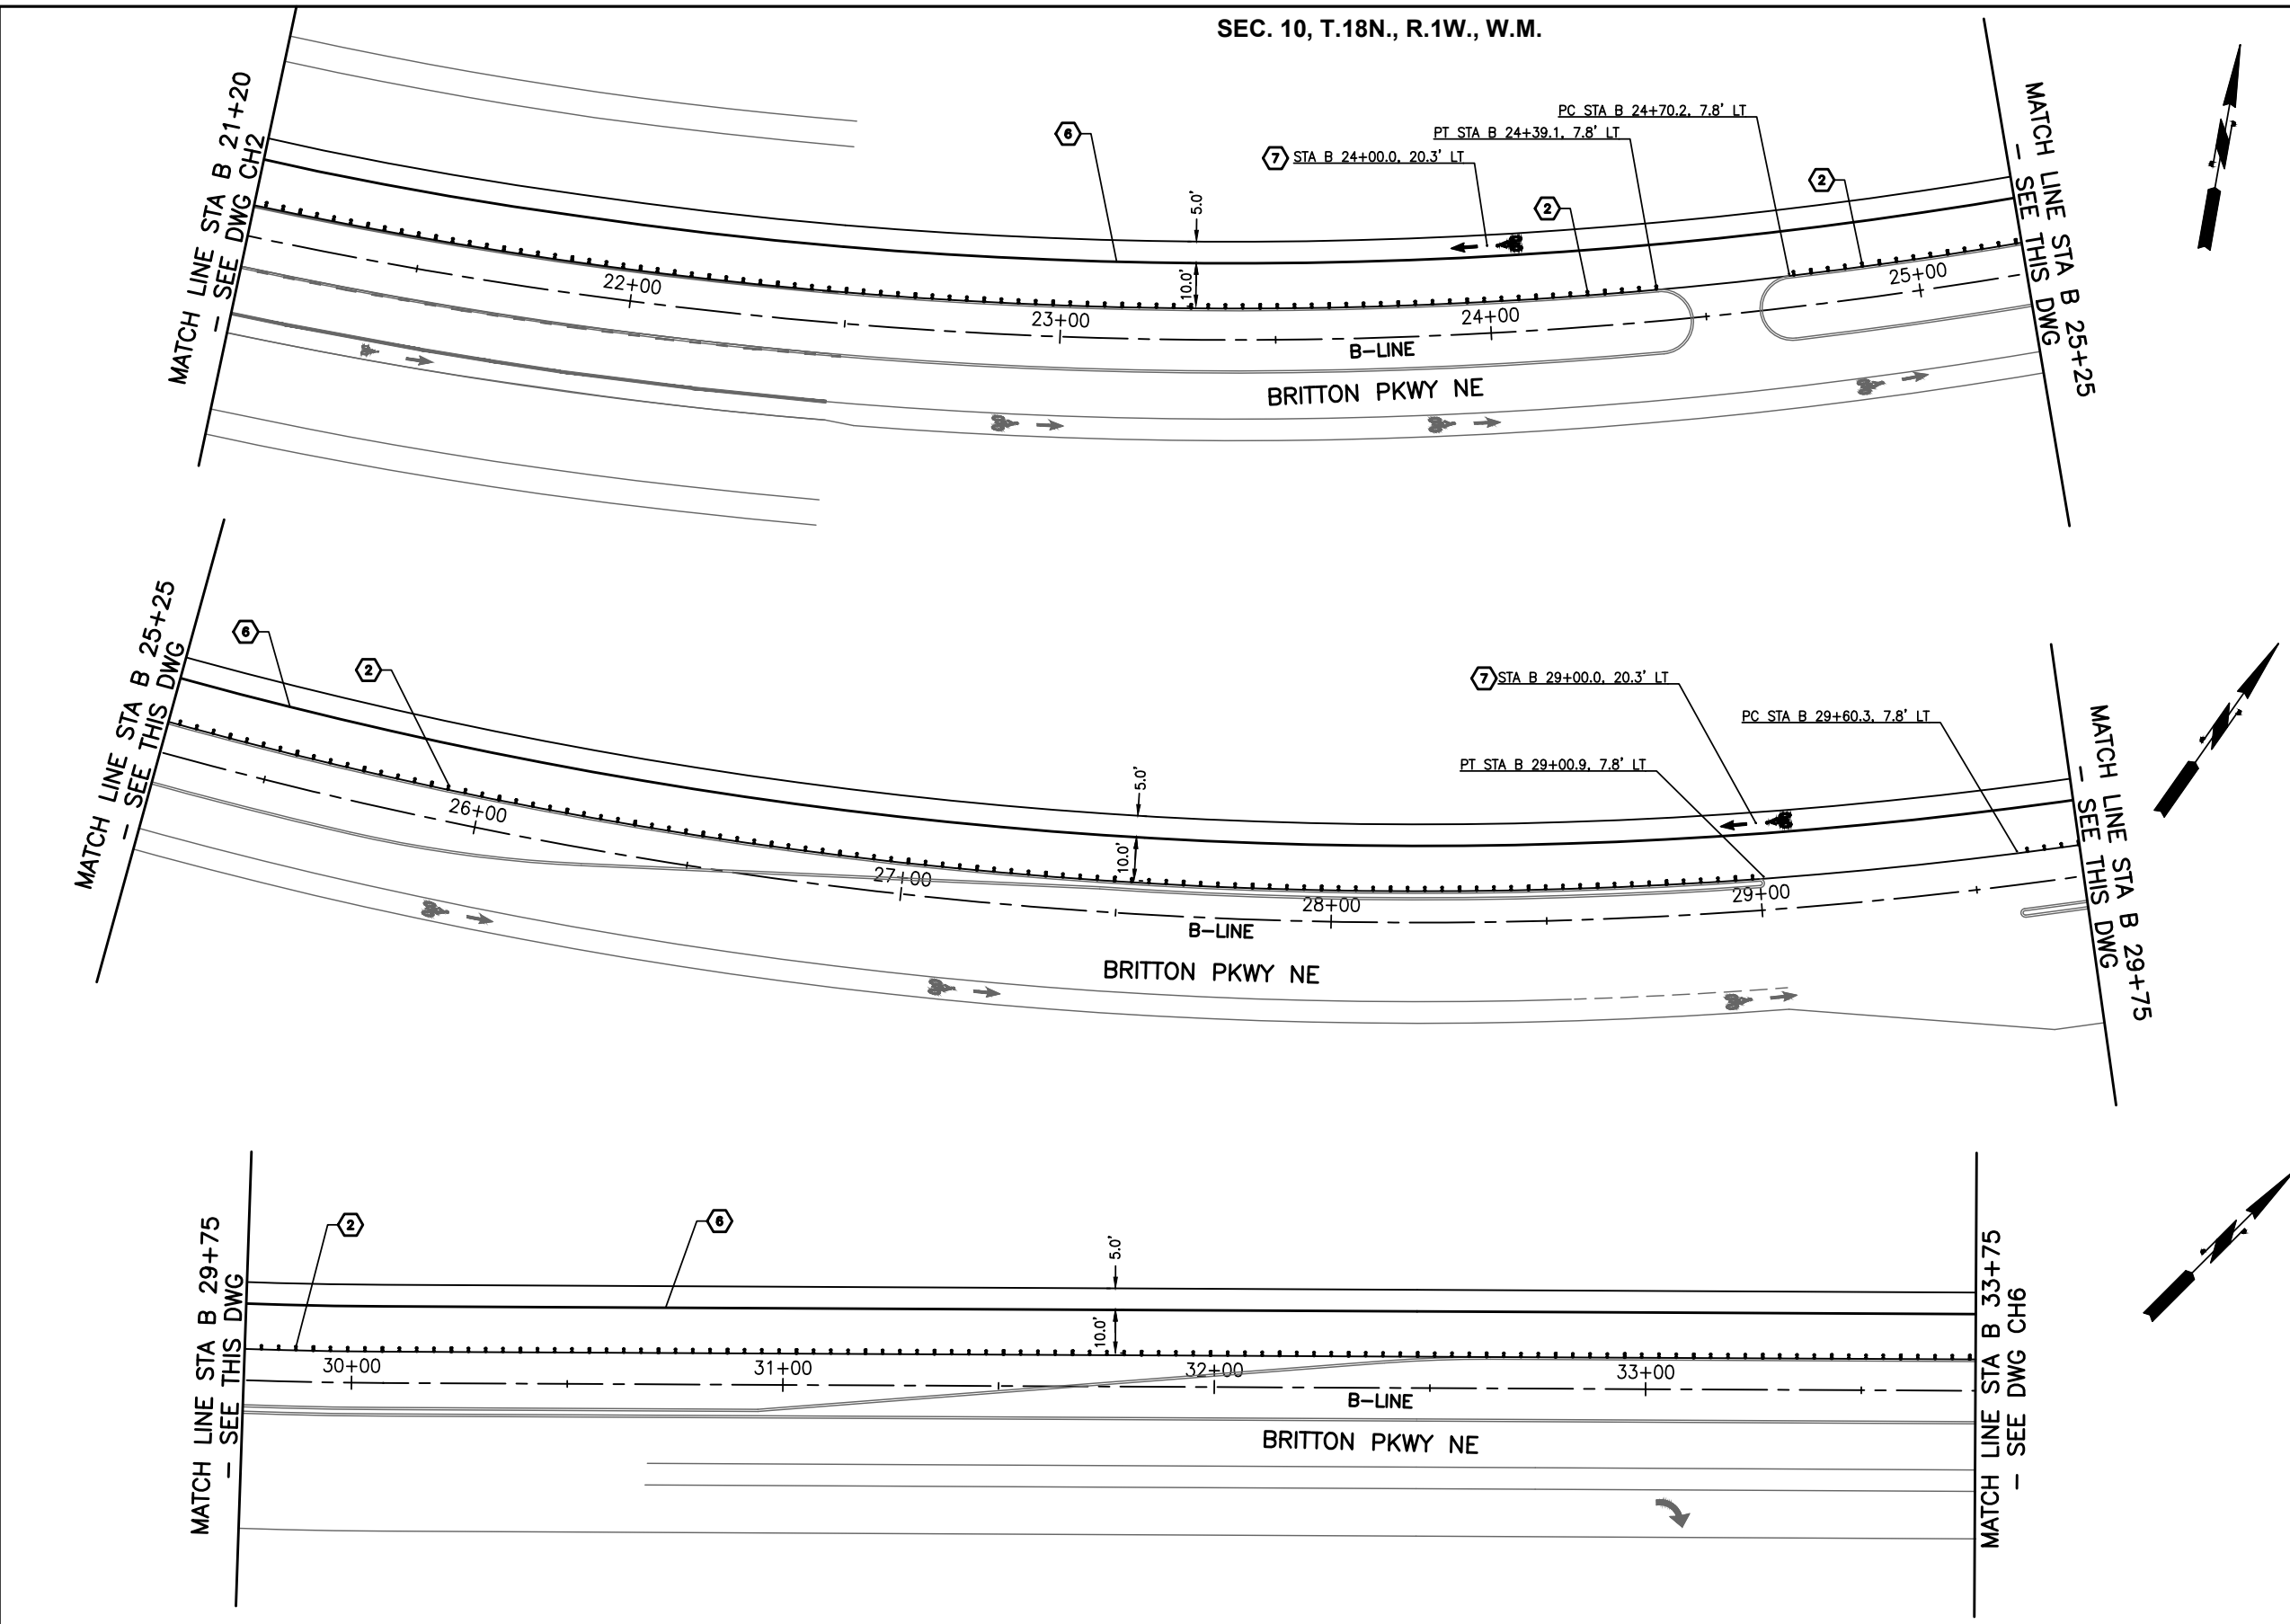1. DIMENSIONS ARE TO FACE OF CURB, EDGE OF PAVEMENT, OR CENTER OF STRIPE.
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- ⑫ 8' LETTERS (ONLY)

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CARPENTER ROAD/BRITTON PARKWAY ROUNDAABOUT


CHANNELIZATION PLAN

DRAWING NUMBER

CH6

HT 48 OF 64

1. THESE DETAILS CAN VARY ACCORDING TO THE CONTRACT PLANS.
2. PLACE ARROWS IN THE CENTER OF THE LANE.
3. THE BID ITEM FOR ENTRY LINE SHALL BE CROSSWALK LINE.
4. ALL ROUNDABOUT CHANNELIZATION SHALL BE TYPE B PRE-FORMED FUSED THERMOPLASTIC.

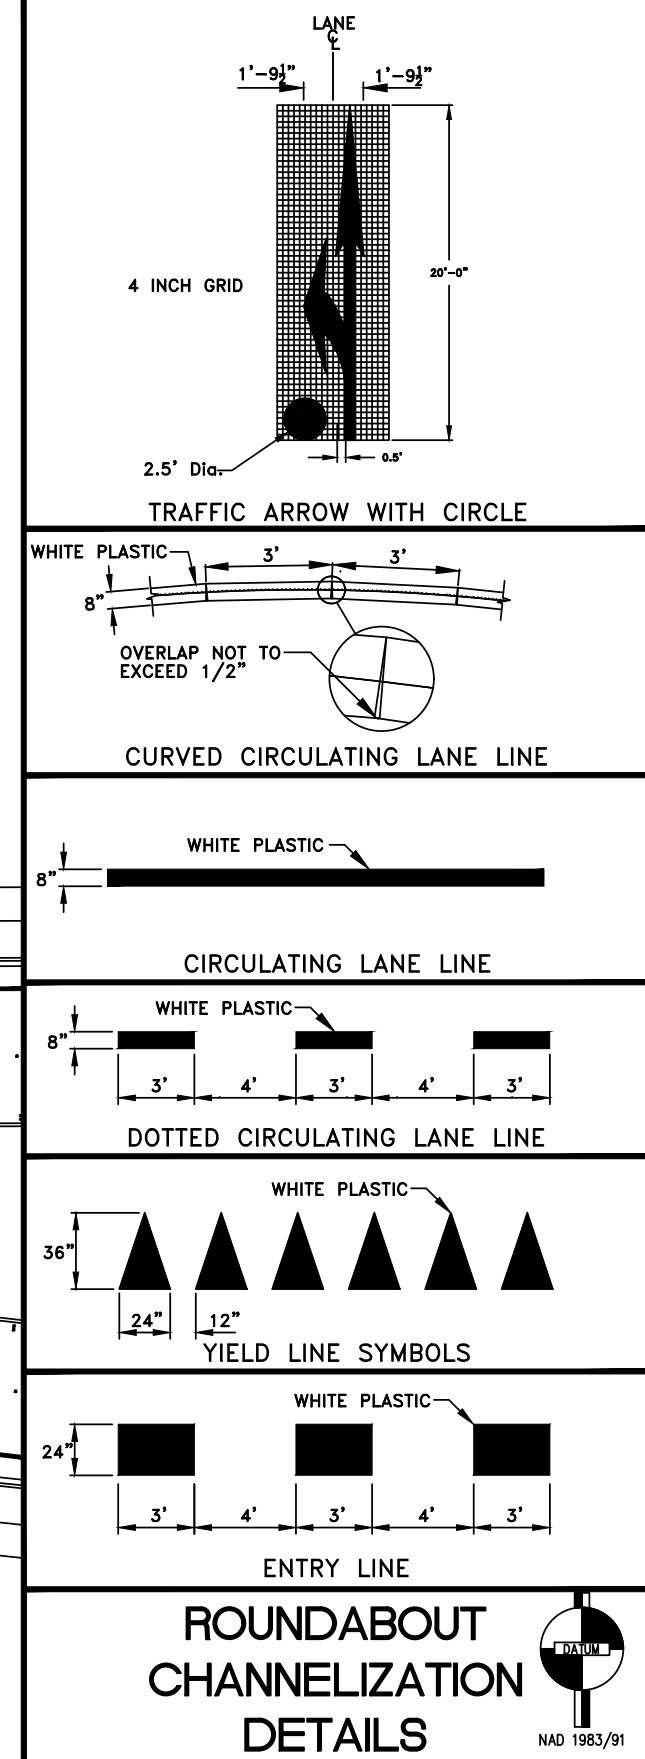

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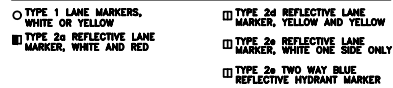
CARPENTER ROAD/BRITTON PARKWAY ROUNDBABOUT

CHANNELIZATION DETAILS

DRAWING NUMBER

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SHT 49 OF 64



LANE

10" 10" 2'-0" 6" 4 INCH GRID

LANE

1'-6" 1'-6" 12'-0" 6" 4 INCH GRID

LANE

1'-9 1/2" 1'-9 1/2" 20'-0" 6" 4 INCH GRID

LANE

2'-9" 2'-9" 20'-0" 6" 4 INCH GRID

LEFT TURN POCKET FOR SIGNALIZED INTERSECTIONS

9' CROSSWALK LINES

4" MIN. 2' STOP LINE

22' 12' VARIES 12' 8'

COMPLETE WORD STENCILS

ONLY

8'

YIELD

8'

TWO-WAY LEFT TURN LANE

| POSTED SPEED | * |
|--------------|-----|
| 25 | 5' |
| 30 | 6' |
| 35 | 7' |
| 40 | 8' |
| 45 | 9' |
| 50 | 10' |

TWO-WAY LEFT TURN STRIPES


GENERAL NOTES:

1. THE MATERIALS USED FOR ALL STOP LINES, CROSSWALKS, ARROWS, PARKING DELINEATION LINES, LETTERS, LEGENDS, AND SYMBOLS SHALL BE PREMARK OR HOT TAPE PREFORMED THERMOPLASTIC 125 MIL THICKNESS.
2. THE PLASTIC MATERIAL USED TO FORM ALL LONG LINE PAVEMENT MARKINGS SHALL BE PAVE-MARK OR NOBLINE THERMOPLASTIC HYDROCARBON FORMULATION 125 MIL THICKNESS MARKING MATERIAL.
3. ALL MARKINGS SHALL MEET FEDERAL METRIC STANDARDS.

Diagram illustrating the dimensions for a bike lane arrow:

- Overall length: 6'
- Arrow body length: 3'
- Arrow tail length: 2'
- Arrow head length: 2' 8"
- Arrow width: 3'

BIKE LANE ARROW

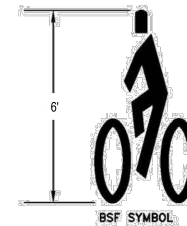

GENERAL NOTES:

- 1. THE MATERIALS USED FOR ALL STOP LINES, CROSSWALKS, ARROWS, PARKING DELINEATION LINES, LETTERS, LEGENDS, AND SYMBOLS SHALL BE PREMARK OR HOT TAP PREFORMED THERMOPLASTIC 125 MIL THICKNESS.**
- 2. THE PLASTIC MATERIAL USED TO FORM ALL LONG LINE PAVEMENT MARKINGS SHALL BE PAVE-MARK OR NORLINE THERMOPLASTIC.**
- 2. ALL MARKINGS SHALL MEET FEDERAL METRIC STANDARDS.**

Diagram illustrating the installation of crosswalk lines and half bars at a street intersection.

Top View (Side View):

- HALF BAR:** Indicated by a vertical line segment.
- CROSSWALK LINE:** Indicated by a horizontal line segment.
- EDGE OF GUTTER PAN (TYP.):** Indicated by a horizontal line segment.
- EDGE OF TRAVELED WAY:** Indicated by a horizontal line segment.
- LANE:** Indicated by a horizontal line segment.
- STOP LINE:** Indicated by a horizontal line segment.
- Dimensions:**
 - 2' (TYP.)
 - 1' (TYP.)
 - 1' (TYP.)
 - 1' (TYP.)
 - 5' (TYP.)
 - 4' MIN
 - 9'
 - 1' MIN

Bottom View (Top View):

- INSTALL CROSSWALK LINES PARALLEL TO THE ROADWAY:** Indicated by a horizontal line segment.
- EDGE OF CONCRETE GUTTER:** Indicated by a horizontal line segment.

Text:

USE HALF BAR WHEN THE DISTANCE FROM THE FACE OF CURB TO THE FIRST FULL BAR IS GREATER THAN 5' BUT LESS THAN 10'

CROSSWALK




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now what's **below**.
Call before you dig.

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CITY OF **LACEY**



CHANNELIZATION DETAILS

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| SIGN SCHEDULE | | | | |
|---------------|------------|-----------------|----------------------|----------|
| SIGN NO. | STATION | MUTCD SIGN TYPE | DESCRIPTION | COMMENTS |
| 1 | B 14+27.90 | W16-17P(MOD) | ROUNDABOUT AHEAD | NEW |
| | | W2-6 | INTERSECTION WARNING | NEW |
| | | W13-1P | 20 MPH | NEW |
| 2 | B 15+66.28 | D3-1 | BRITTON PKWY NE | 2 POSTS |
| 3 | B 15+65.76 | R1-2 | YIELD | NEW |
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LEGEND:

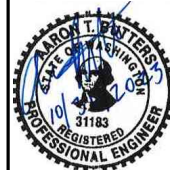EXISTING SIGN

PROPOSED SIGN

SIGN NUMBER

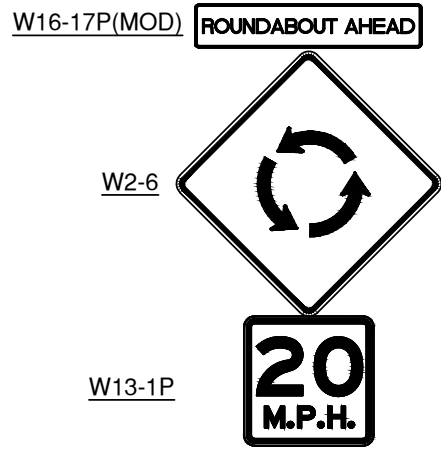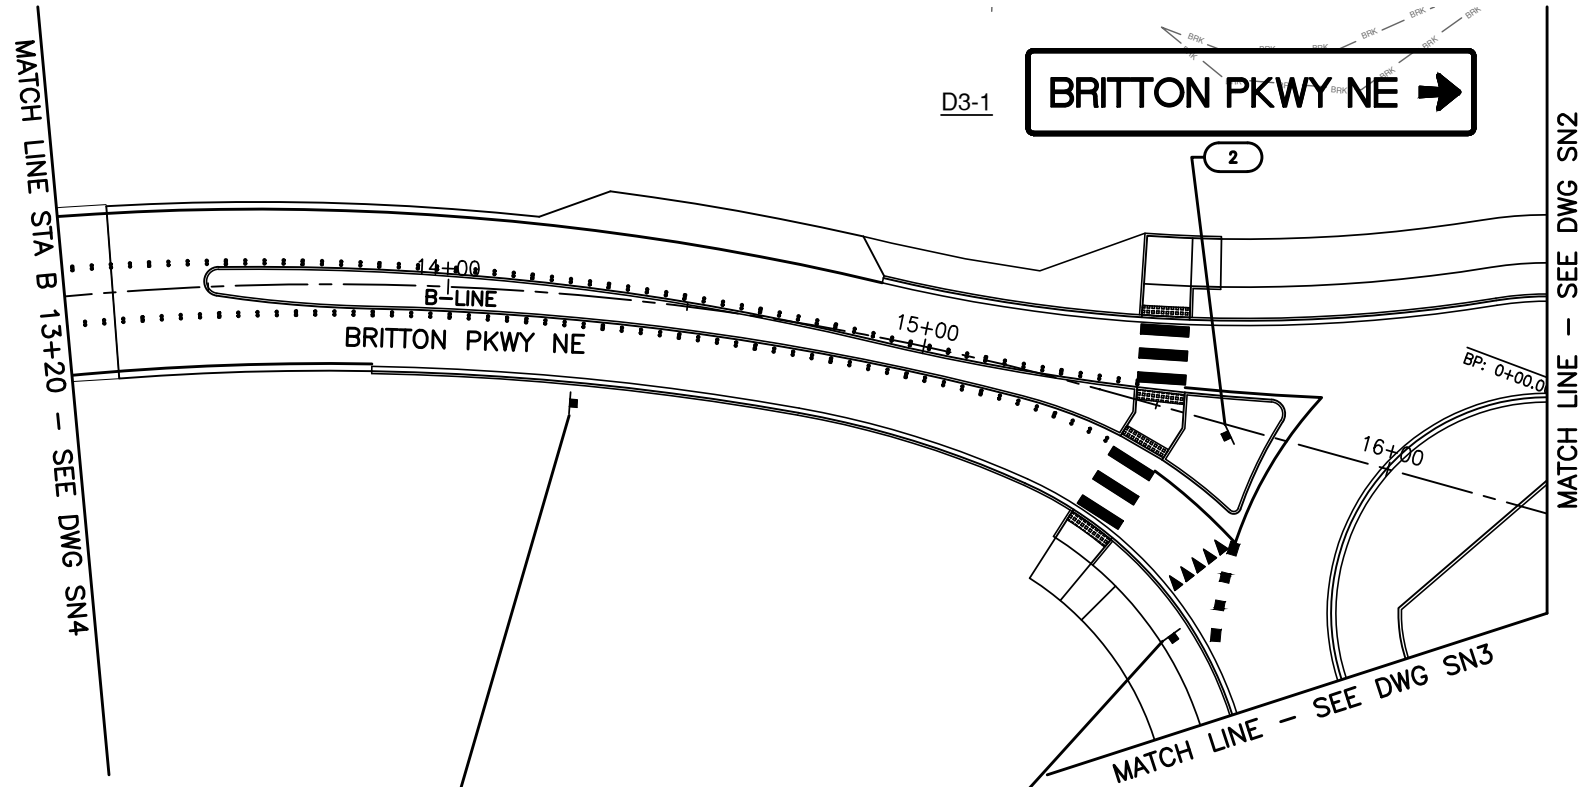- GENERAL NOTES:**
- SIGN PLACEMENT PER DETAIL ON DWG SND1
 - STEEL SIGN SUPPORT INSTALLATION PER DETAIL ON DWG SND1
 - SIGN BRACING PER DETAIL ON DWG SND1
 - NEW AND REPLACED SIGNS TO BE PROVIDED AND INSTALLED BY THE CITY, EXCEPT THE LED FLASHING STOP SIGN (EX36).

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Know what's below. Call before you dig.

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CARPENTER ROAD/BRITTON PARKWAY

ROUNDABOUT


SIGNING PLAN

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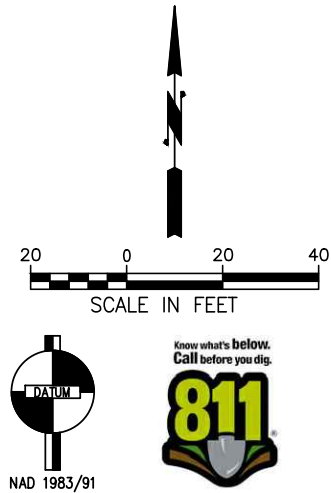
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- LEGEND:**
- EXISTING SIGN
 - PROPOSED SIGN
 - SIGN NUMBER
- GENERAL NOTES:**
- SIGN PLACEMENT PER DETAIL ON DWG SND1
 - STEEL SIGN SUPPORT INSTALLATION PER DETAIL ON DWG SND1
 - SIGN BRACING PER DETAIL ON DWG SND1
 - NEW AND REPLACED SIGNS TO BE PROVIDED AND INSTALLED BY THE CITY, EXCEPT THE LED FLASHING STOP SIGN (EX36).

| SIGN SCHEDULE | | | | |
|---------------|------------|-----------------|------------------------|----------|
| SIGN NO. | STATION | MUTCD SIGN TYPE | DESCRIPTION | COMMENTS |
| 4 | B 16+55.67 | R6-1 | ONE WAY | NEW |
| | | R6-4A | ROUNDABOUT DIRECTIONAL | NEW |
| 5 | B 16+60.16 | R6-1 | ONE WAY | NEW |
| | | R6-4A | ROUNDABOUT DIRECTIONAL | NEW |
| 6 | B 17+06.14 | R1-2 | YIELD | NEW |
| 7 | B 17+15.10 | D3-1 | BRITTON PKWY NE | 2 POSTS |
| 8 | B 18+19.99 | R9-6 | BICYCLE YIELD TO PEDS | NEW |
| 9 | B 19+51.16 | R5-601(MOD) | BICYCLE EXIT | NEW |
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| SIGN SCHEDULE | | | | |
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| SIGN NO. | STATION | MUTCD SIGN TYPE | DESCRIPTION | COMMENTS |
| 10 | B 18+80.91 | W16-7P(MOD) | ROUNDABOUT AHEAD | NEW |
| | | W2-6 | INTERSECTION WARNING | NEW |
| | | W13-1P | 20 MPH | NEW |
| 11 | B 20+74.33 | R2-1 | SPEED LIMIT 40 MPH | NEW |
| EX12 | B 16+61.06 | - | STREET NAME | EXISTING SIGN TO REMOVE |
| EX13 | B 16+76.66 | - | STOP SIGN AND STREET NAME | EXISTING SIGN TO REMOVE |
| EX14 | B 17+23.54 | - | KEEP RIGHT | EXISTING SIGN TO REMOVE |
| EX15 | B 17+39.67 | - | BIKE LANE AHEAD | EXISTING SIGN TO REMOVE |
| EX16 | B 17+51.60 | - | BIKE LANE ENDS | EXISTING SIGN TO REMOVE |
| EX17 | B 19+60.53 | - | SPEED LIMIT 40 MPH | EXISTING SIGN TO REMAIN |
| EX18 | B 19+59.50 | - | SPEED LIMIT 35 MPH | EXISTING SIGN TO REMOVE |
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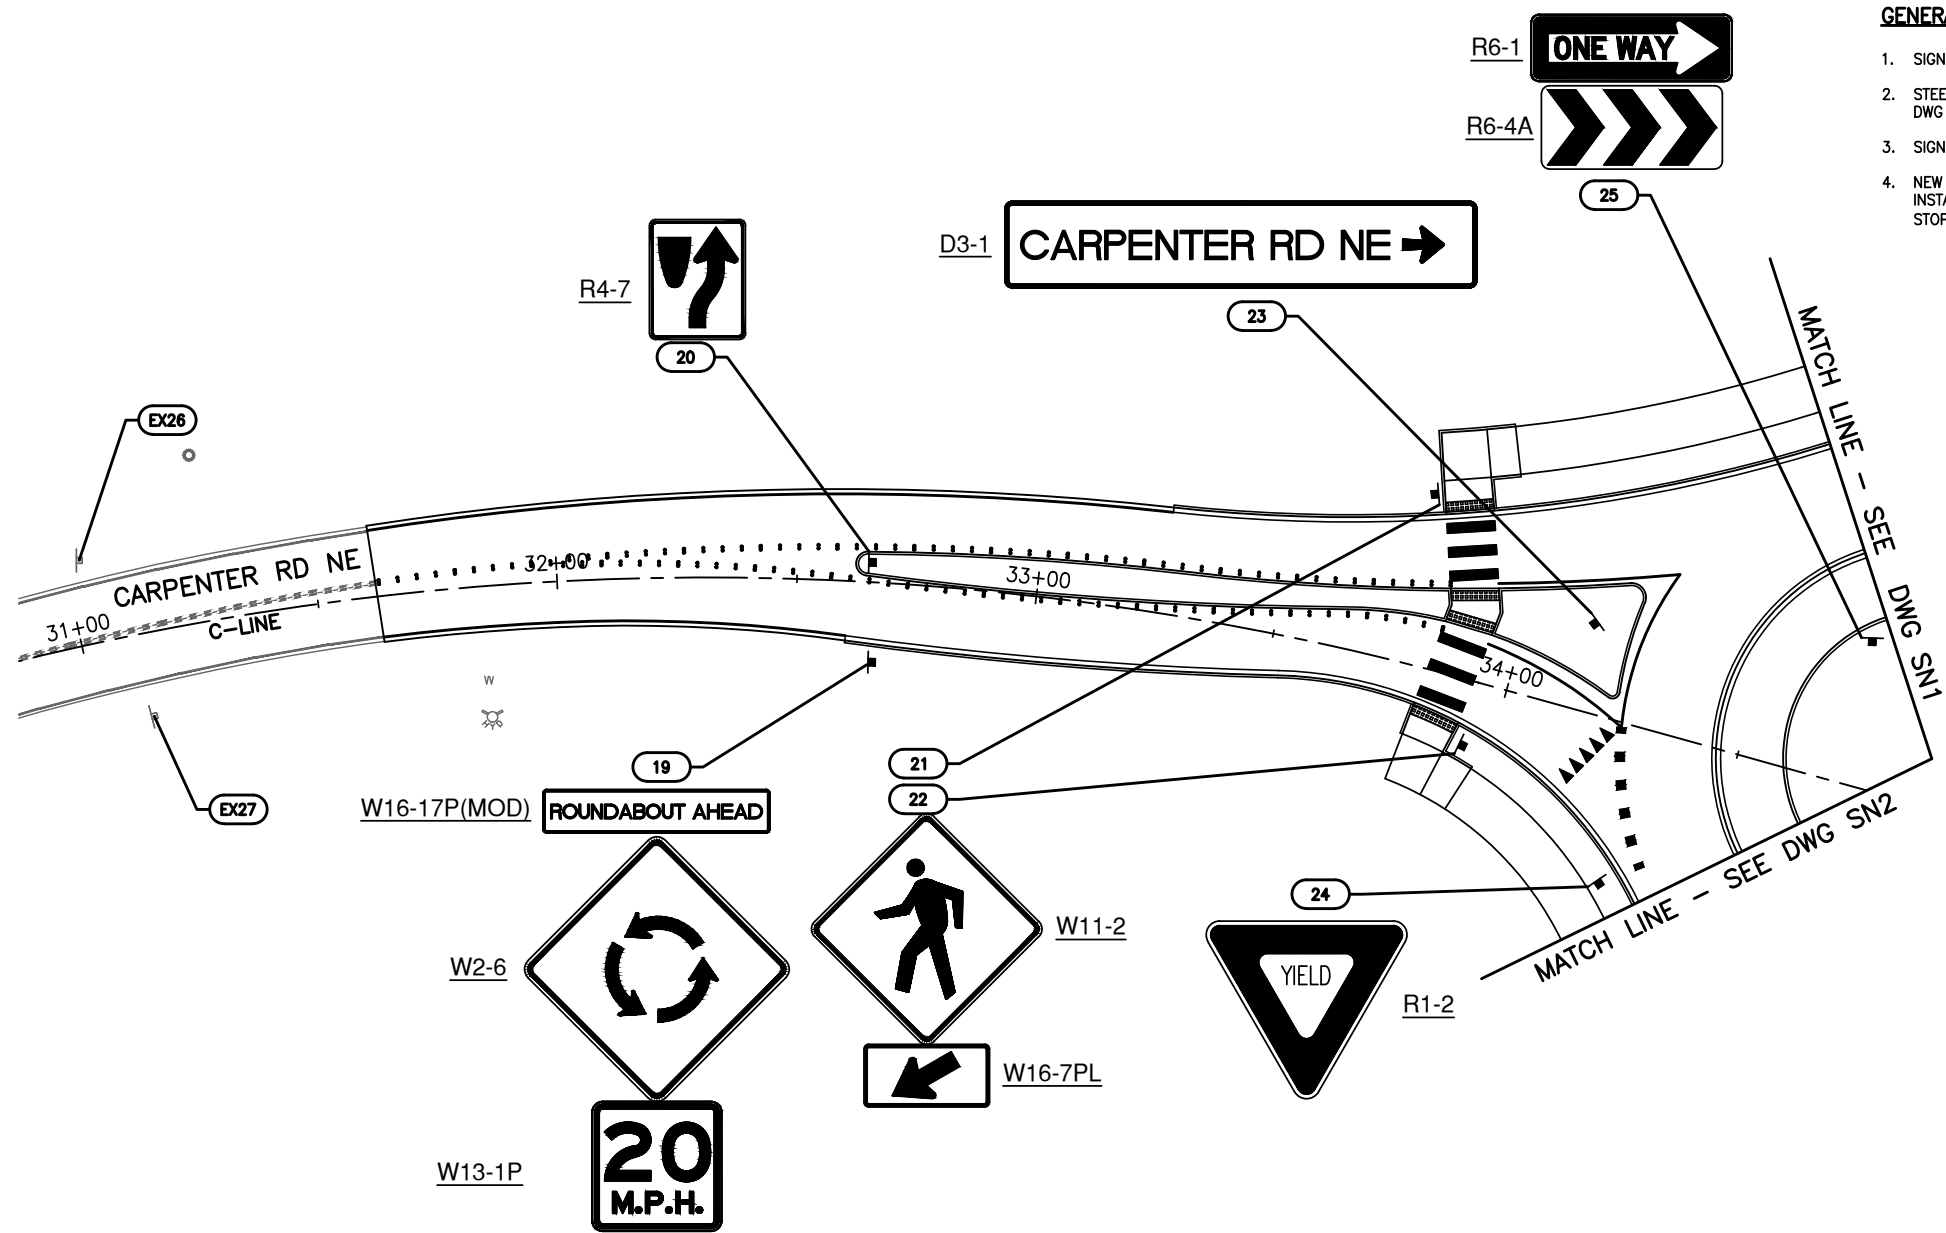
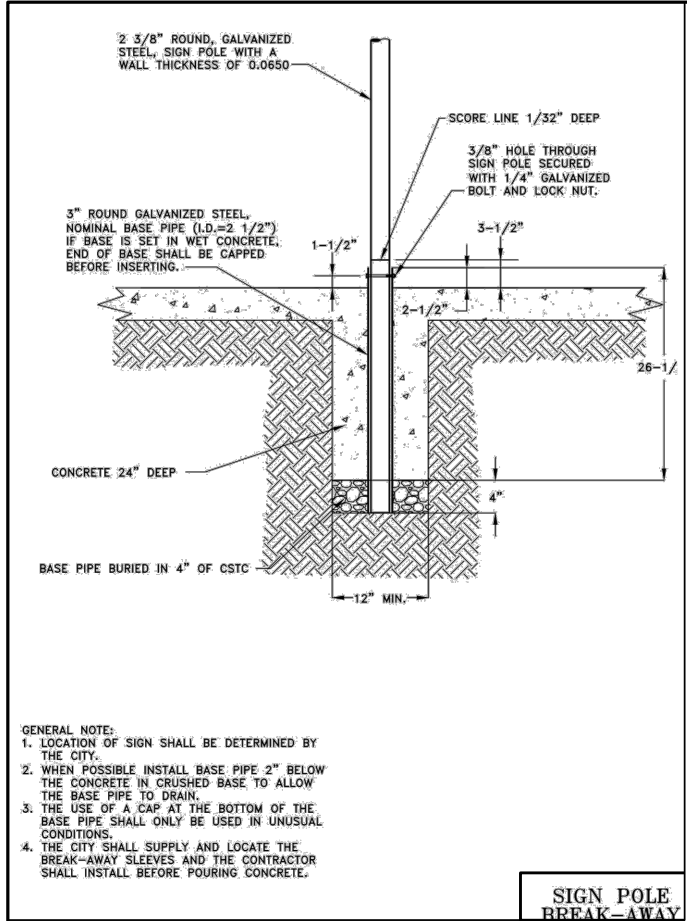
**CARPENTER ROAD/BRITTON PARKWAY
ROUNDABOUT**

SIGNING PLAN

DRAWING NUMBER
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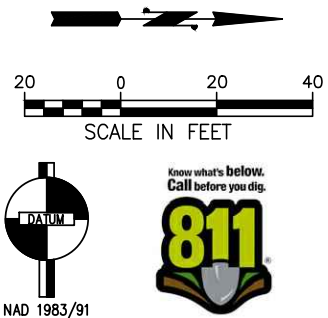
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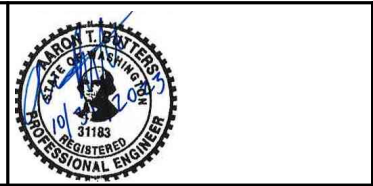
| SIGN SCHEDULE | | | | |
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| SIGN NO. | STATION | MUTCD SIGN TYPE | DESCRIPTION | COMMENTS |
| 19 | C 32+66.47 | W16-7P(MOD) | ROUNDABOUT AHEAD | NEW |
| | | W2-6 | INTERSECTION WARNING | NEW |
| | | W13-1P | 20 MPH | NEW |
| 20 | C 32+64.58 | R4-7 | KEEP RIGHT | NEW |
| | | W11-2 | PEDESTRIAN | NEW |
| 21 | C 33+76.44 | W16-7PL | DOWNWARD DIAGONAL ARROW | NEW |
| | | W11-2 | PEDESTRIAN | NEW |
| 22 | C 33+93.44 | W16-7PL | DOWNWARD DIAGONAL ARROW | NEW |
| | | W16-7PL | DOWNWARD DIAGONAL ARROW | NEW |
| 23 | C 34+14.45 | D3-1 | CARPENTER RD NE | 2 POSTS |
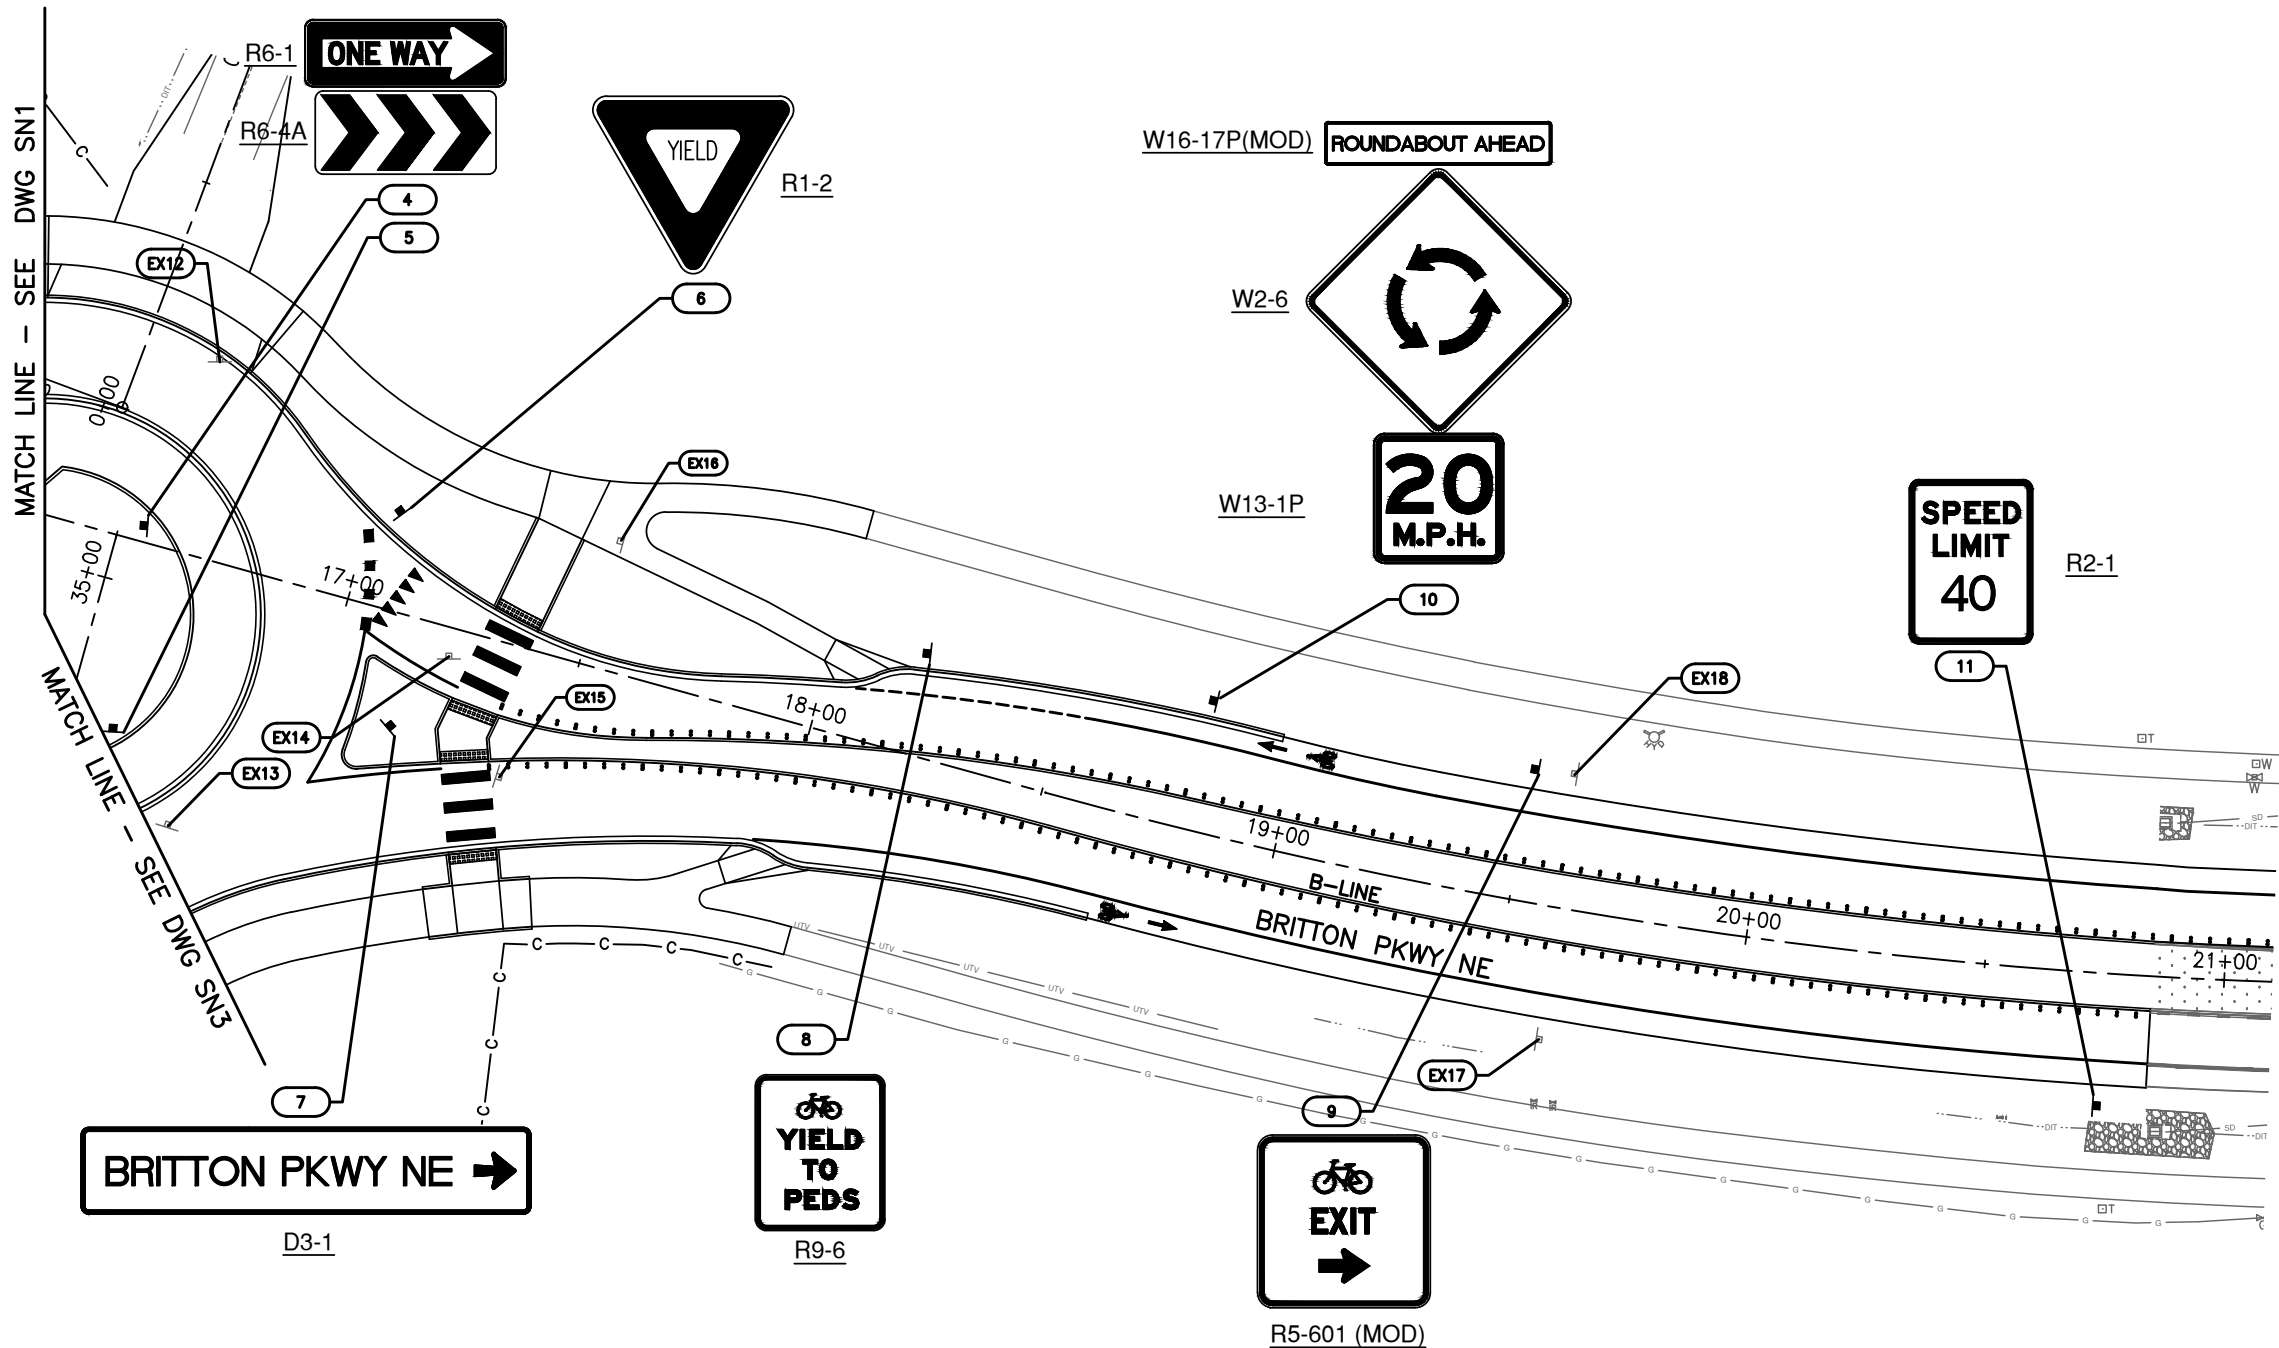
| SIGN SCHEDULE | | | | |
|---------------|------------|-----------------|------------------------|-------------------------|
| SIGN NO. | STATION | MUTCD SIGN TYPE | DESCRIPTION | COMMENTS |
| 24 | C 34+28.66 | R1-2 | YIELD | NEW |
| 25 | C 34+70.45 | R6-1 | ONE WAY | NEW |
| | | R6-4A | ROUNDABOUT DIRECTIONAL | NEW |
| EX26 | C 31+03.16 | - | SPEED LIMIT 35 MPH | EXISTING SIGN TO REMAIN |
| EX27 | C 31+11.76 | - | STOP SIGN AHEAD | EXISTING SIGN TO REMOVE |
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| CARPENTER ROAD/BRITTON PARKWAY ROUNDABOUT | DRAWING NUMBER |
| SIGNING PLAN | SN3 |
| | SHT 53 OF 64 |


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LEGEND:

- EXISTING SIGN
PROPOSED SIGN
SIGN NUMBER

GENERAL NOTES:

1. SIGN PLACEMENT PER DETAIL ON DWG SND1
2. STEEL SIGN SUPPORT INSTALLATION PER DETAIL ON DWG SND1
3. SIGN BRACING PER DETAIL ON DWG SND1
4. NEW AND REPLACED SIGNS TO BE PROVIDED AND INSTALLED BY THE CITY, EXCEPT THE LED FLASHING STOP SIGN (EX36).

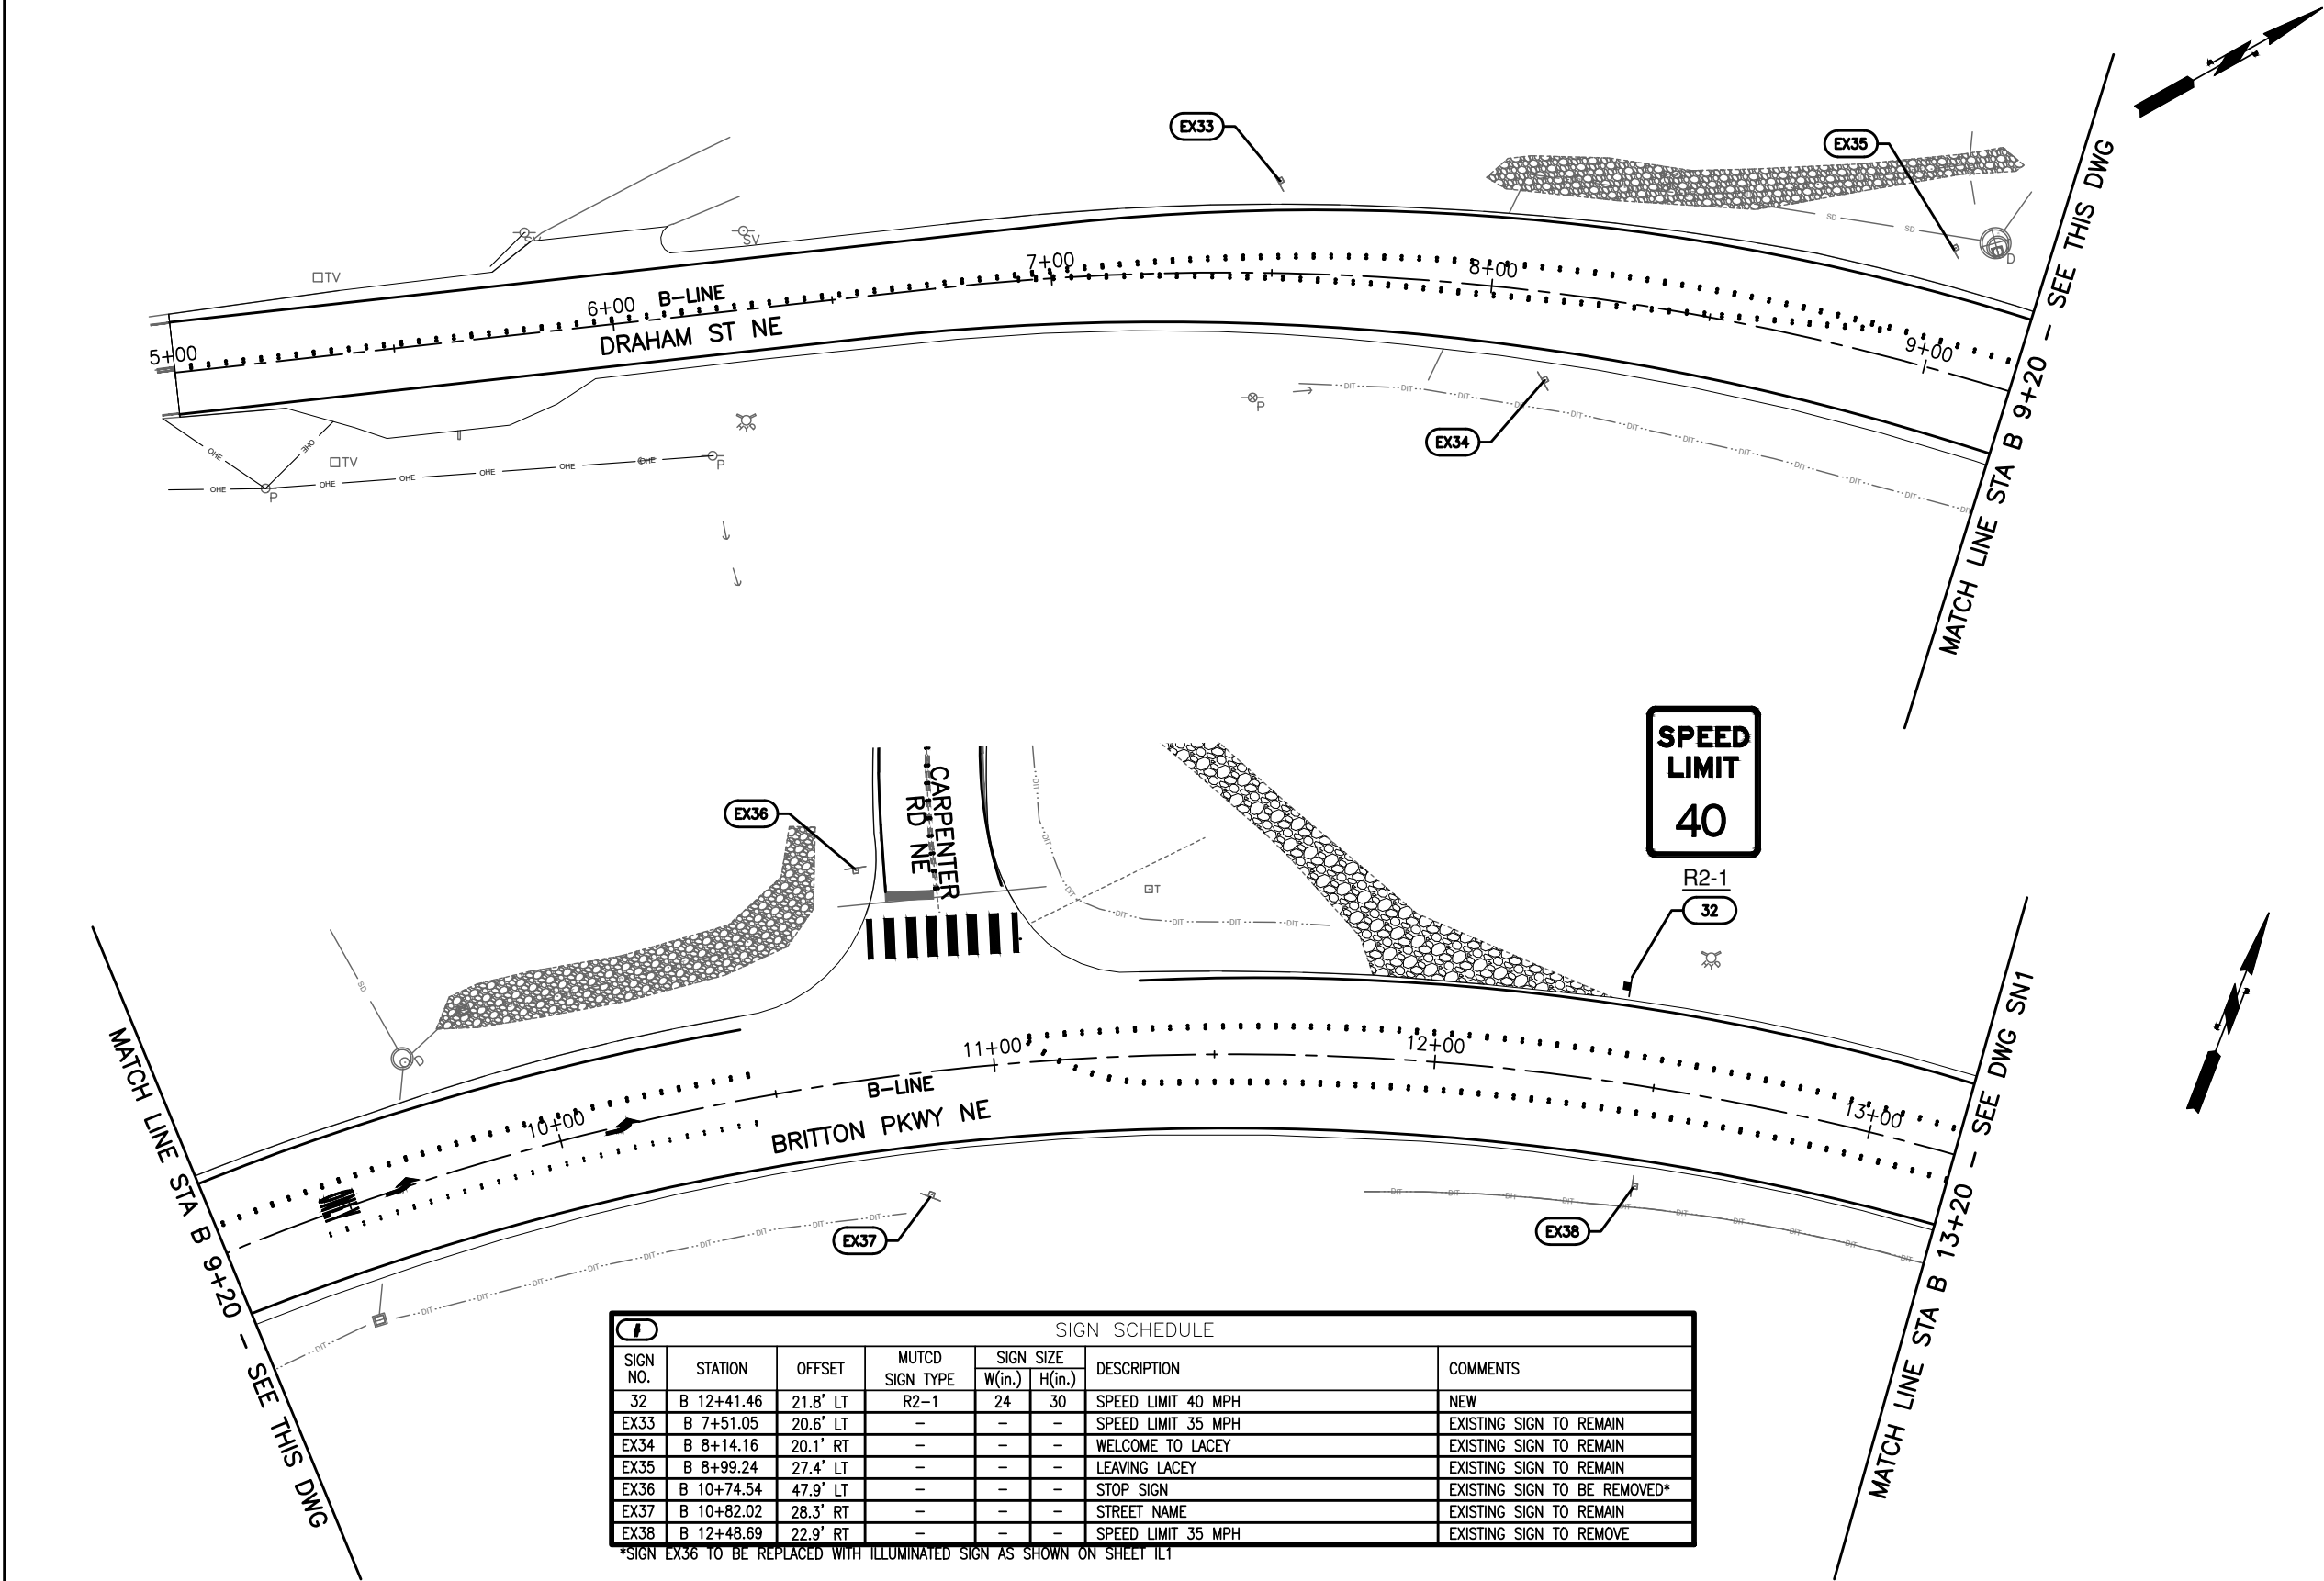

| SIGN SCHEDULE | | | | | | |
|---------------|------------|----------|-----------------|----------------------------|----|--------------------|
| SIGN NO. | STATION | OFFSET | MUTCD SIGN TYPE | SIGN SIZE W(in.) H(in.) | | DESCRIPTION |
| 32 | B 12+41.46 | 21.8' LT | R2-1 | 24 | 30 | SPEED LIMIT 40 MPH |
| EX33 | B 7+51.05 | 20.6' LT | - | - | - | SPEED LIMIT 35 MPH |
| EX34 | B 8+14.16 | 20.1' RT | - | - | - | WELCOME TO LACEY |
| EX35 | B 8+99.24 | 27.4' LT | - | - | - | LEAVING LACEY |
| EX36 | B 10+74.54 | 47.9' LT | - | - | - | STOP SIGN |
| EX37 | B 10+82.02 | 28.3' RT | - | - | - | STREET NAME |
| EX38 | B 12+48.69 | 22.9' RT | - | - | - | SPEED LIMIT 35 MPH |

*SIGN EX36 TO BE REPLACED WITH ILLUMINATED SIGN AS SHOWN ON SHEET 1L1




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| | YZ DESIGNED BY YZ DRAWN BY GW CHECKED BY ATB APPROVED BY DATE: 10/31/2023 |
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|---|
| CARPENTER ROAD/BRITTON PARKWAY ROUNDAABOUT |
| SIGNING PLAN |

| |
|----------------|
| DRAWING NUMBER |
| SN4 |
| SHT 54 OF 64 |



- GENERAL NOTE:
1. LOCATION OF SIGN SHALL BE DETERMINED BY THE CITY.
 2. WHEN POSSIBLE INSTALL BASE PIPE 2" BELOW THE CONCRETE IN CRUSHED BASE TO ALLOW THE BASE PIPE TO DRAIN.
 3. THE USE OF A CAP AT THE BOTTOM OF THE BASE PIPE SHALL ONLY BE USED IN UNUSUAL CONDITIONS.
 4. THE CITY SHALL SUPPLY AND LOCATE THE BREAK-AWAY SLEEVES AND THE CONTRACTOR SHALL INSTALL BEFORE POURING CONCRETE.

SIGN POLE BREAK-AWAY
NO SCALE

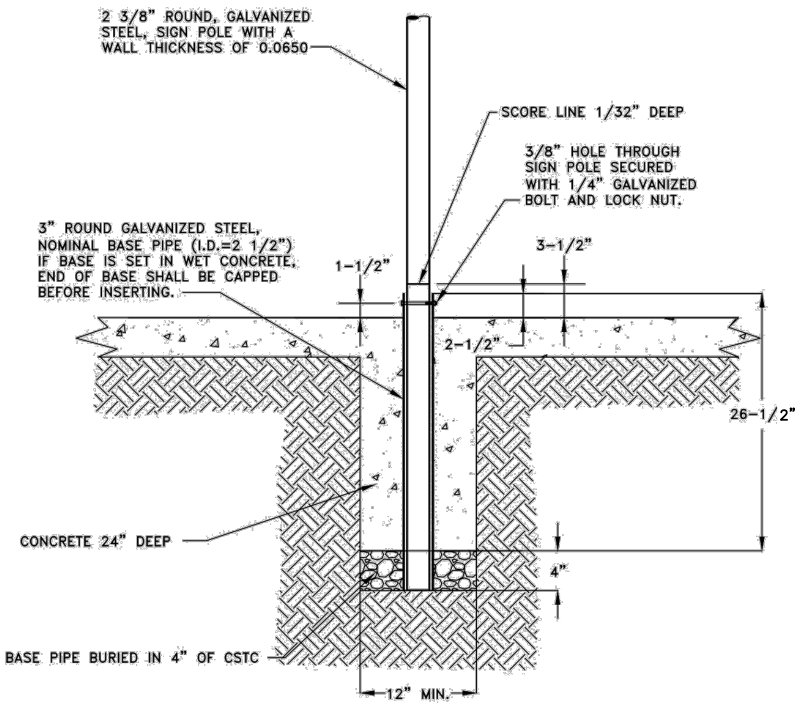

| NO. | DATE | BY | APPR. | REVISIONS |
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YZ
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DATE: 10/31/2023



LOCHNER



CARPENTER ROAD/BRITTON PARKWAY
ROUNDAABOUT

SIGNING DETAILS


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SHT 55 OF 64

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SEC. 10, T.18N., R.1W., W.M.






PLANTING NOTES
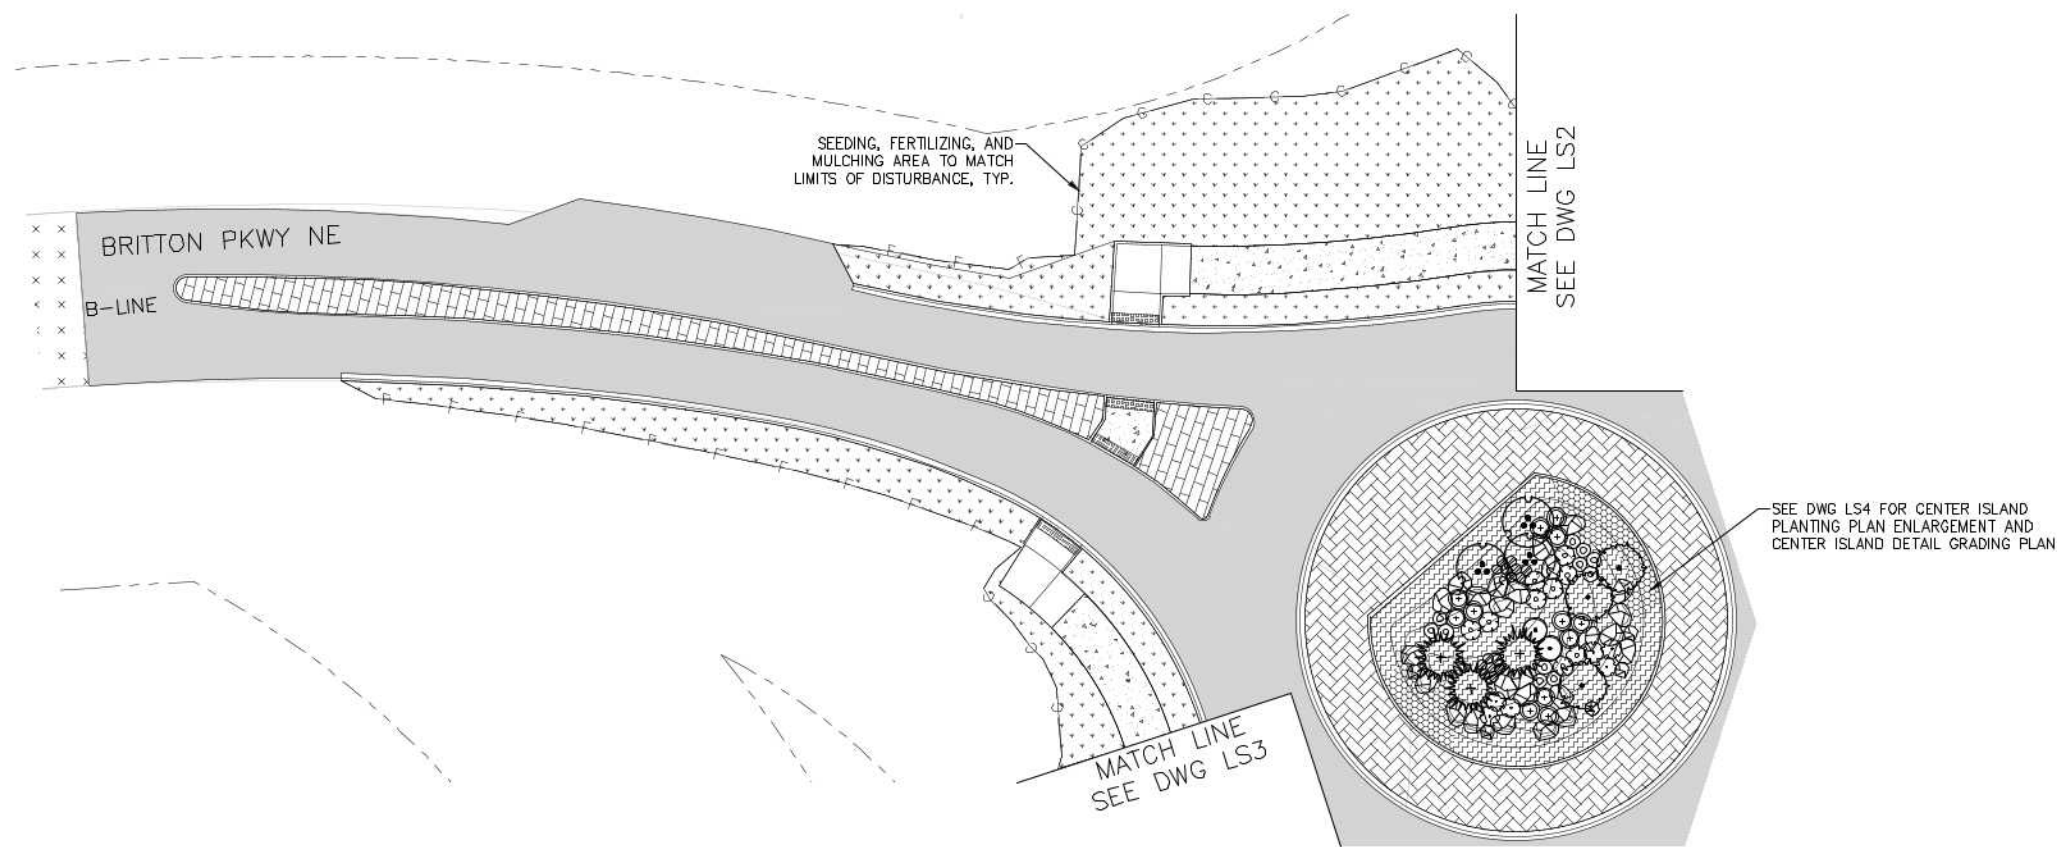
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


PLANT SCHEDULE

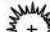
| TREES | QTY | SCIENTIFIC NAME | COMMON NAME | SIZE | SPACING | REMARKS |
|---|----------|---|---|----------|----------|---|
|  | 3 | CHAMAECYPARIS NOOTKATENSIS 'PENDULA' | WEeping ALASKA CEDAR | 7'-8' HT | AS SHOWN | SINGLE TRUNK WITH STRAIGHT CENTRAL LEADER. SYMMETRICAL BRANCHING HABIT. |
|  | 3 | CHAMAECYPARIS PISIFERA 'BOULEVARD' | EXCELSA WESTERN RED CEDAR | 7'-8' HT | AS SHOWN | SINGLE TRUNK WITH STRAIGHT CENTRAL LEADER. SYMMETRICAL BRANCHING HABIT. |
| SHRUBS | QTY | SCIENTIFIC NAME | COMMON NAME | SIZE | SPACING | REMARKS |
|  | 3 | AMELANCHIER X GRANDIFLORA 'AUTUMN BRILLIANCE' | AUTUMN BRILLIANCE SERVICEBERRY | 6'-7' HT | AS SHOWN | MULTI-STEM, THREE STEMS MIN, B&B |
|  | 103 | CALUNA VULGARIS 'SPRING TORCH' | SPRING TORCH HEATHER | #2 CONT | 18" O.C. | FULL AND WELL ROOTED |
|  | 6 | CORNUS SANGUINEA 'MIDWINTER FIRE' | MIDWINTER FIRE DOGWOOD | #2 CONT | AS SHOWN | FULL AND WELL ROOTED |
|  | 15 | CORNUS SERICEA 'KESEYI' | KELSEY DOGWOOD | #1 CONT | 24" O.C. | FULL AND WELL ROOTED |
|  | 664 | MAHONIA REPENS | CREeping OREGON GRAPE | #1 CONT | 18" O.C. | FULL AND WELL ROOTED |
|  | 2 | RIBES SANGUINEUM 'KING EDWARD VII' | KING EDWARD VII FLOWERING CURRANT | #2 CONT | AS SHOWN | FULL AND WELL ROOTED |
|  | 11 | SPIRAEA JAPONICA 'GOLDFLAME' | GOLDFLAME SPIREA | #2 CONT | AS SHOWN | FULL AND WELL ROOTED |
|  | 9 | VACCINIUM OVATUM | EVERGREEN HUCKLEBERRY | #2 CONT | AS SHOWN | FULL AND WELL ROOTED |
| GRASSES & PERENNIALS | QTY | SCIENTIFIC NAME | COMMON NAME | SIZE | SPACING | REMARKS |
|  | 13 | MISCANTHUS SINENSIS 'GRACILLIMUS' | MAIDEN HAIR GRASS | #2 CONT | AS SHOWN | FULL AND WELL ROOTED |
|  | 5,475 SF | SEEDING, FERTILIZING, AND MULCHING SEE SPECIAL PROVISIONS | SEED MIX SHALL BE TURF TYPE PERRENIAL RYE BLEND - TWO OR MORE VARIETIES (50% BY WEIGHT), CHEWING FESCUE (30% BY WEIGHT), AND HARD FESCUE (20% BY WEIGHT). APPLICATION RATE SHALL 6 LBS PER 1,000 SQUARE FEET. | | | |




SCALE IN FEET



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| <table><tr><th>NO.</th><th>DATE</th><th>BY</th><th>APPR.</th></tr><tr><td> </td><td> </td><td> </td><td> </td></tr><tr><td> </td><td> </td><td> </td><td> </td></tr><tr><td> </td><td> </td><td> </td><td> </td></tr><tr><td> </td><td> </td><td> </td><td> </td></tr><tr><td> </td><td> </td><td> </td><td> </td></tr></table> | NO. | DATE | BY | APPR. | | <table><tr><th colspan="2">REVISIONS</th></tr><tr><td> </td><td> </td></tr><tr><td> </td><td> </td></tr><tr><td> </td><td> </td></tr><tr><td> </td><td> </td></tr><tr><td> </td><td> </td></tr></table> | REVISIONS | | | | | | | | | | | | <table><tr><th colspan="2">APPROVED FOR CONSTRUCTION</th></tr><tr><td>ENGINEERING MANAGER</td><td>DATE</td></tr><tr><td>PROJECT MANAGER</td><td>DATE</td></tr><tr><td>PROJECT ENGINEER</td><td>DATE</td></tr></table> | APPROVED FOR CONSTRUCTION | | ENGINEERING MANAGER | DATE | PROJECT MANAGER | DATE | PROJECT ENGINEER | DATE | <table><tr><td>RDL DESIGNED BY</td><td> </td></tr><tr><td>RDL DRAWN BY</td><td> </td></tr><tr><td>MER CHECKED BY</td><td> </td></tr><tr><td>APPROVED BY</td><td> </td></tr><tr><td>DATE:</td><td>11/1/2023</td></tr></table> | RDL DESIGNED BY | | RDL DRAWN BY | | MER CHECKED BY | | APPROVED BY | | DATE: | 11/1/2023 |   |  | <table><tr><th colspan="2">CITY OF LACEY CARPENTER ROAD ROUNDABOUT</th></tr><tr><td colspan="2">LANDSCAPE PLAN</td></tr></table> | CITY OF LACEY CARPENTER ROAD ROUNDABOUT | | LANDSCAPE PLAN | | <table><tr><th colspan="2">DRAWING NUMBER</th></tr><tr><td colspan="2">LS1</td></tr><tr><td>SHT</td><td>56 OF 64</td></tr></table> | DRAWING NUMBER | | LS1 | | SHT | 56 OF 64 |
|---|
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| CITY OF LACEY CARPENTER ROAD ROUNDABOUT | |
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PLANTING NOTES

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6. SEEDING, FERTILIZING, AND MULCHING LIMITS SHALL MATCH LIMITS OF DISTURBANCE.

PLANT SCHEDULE

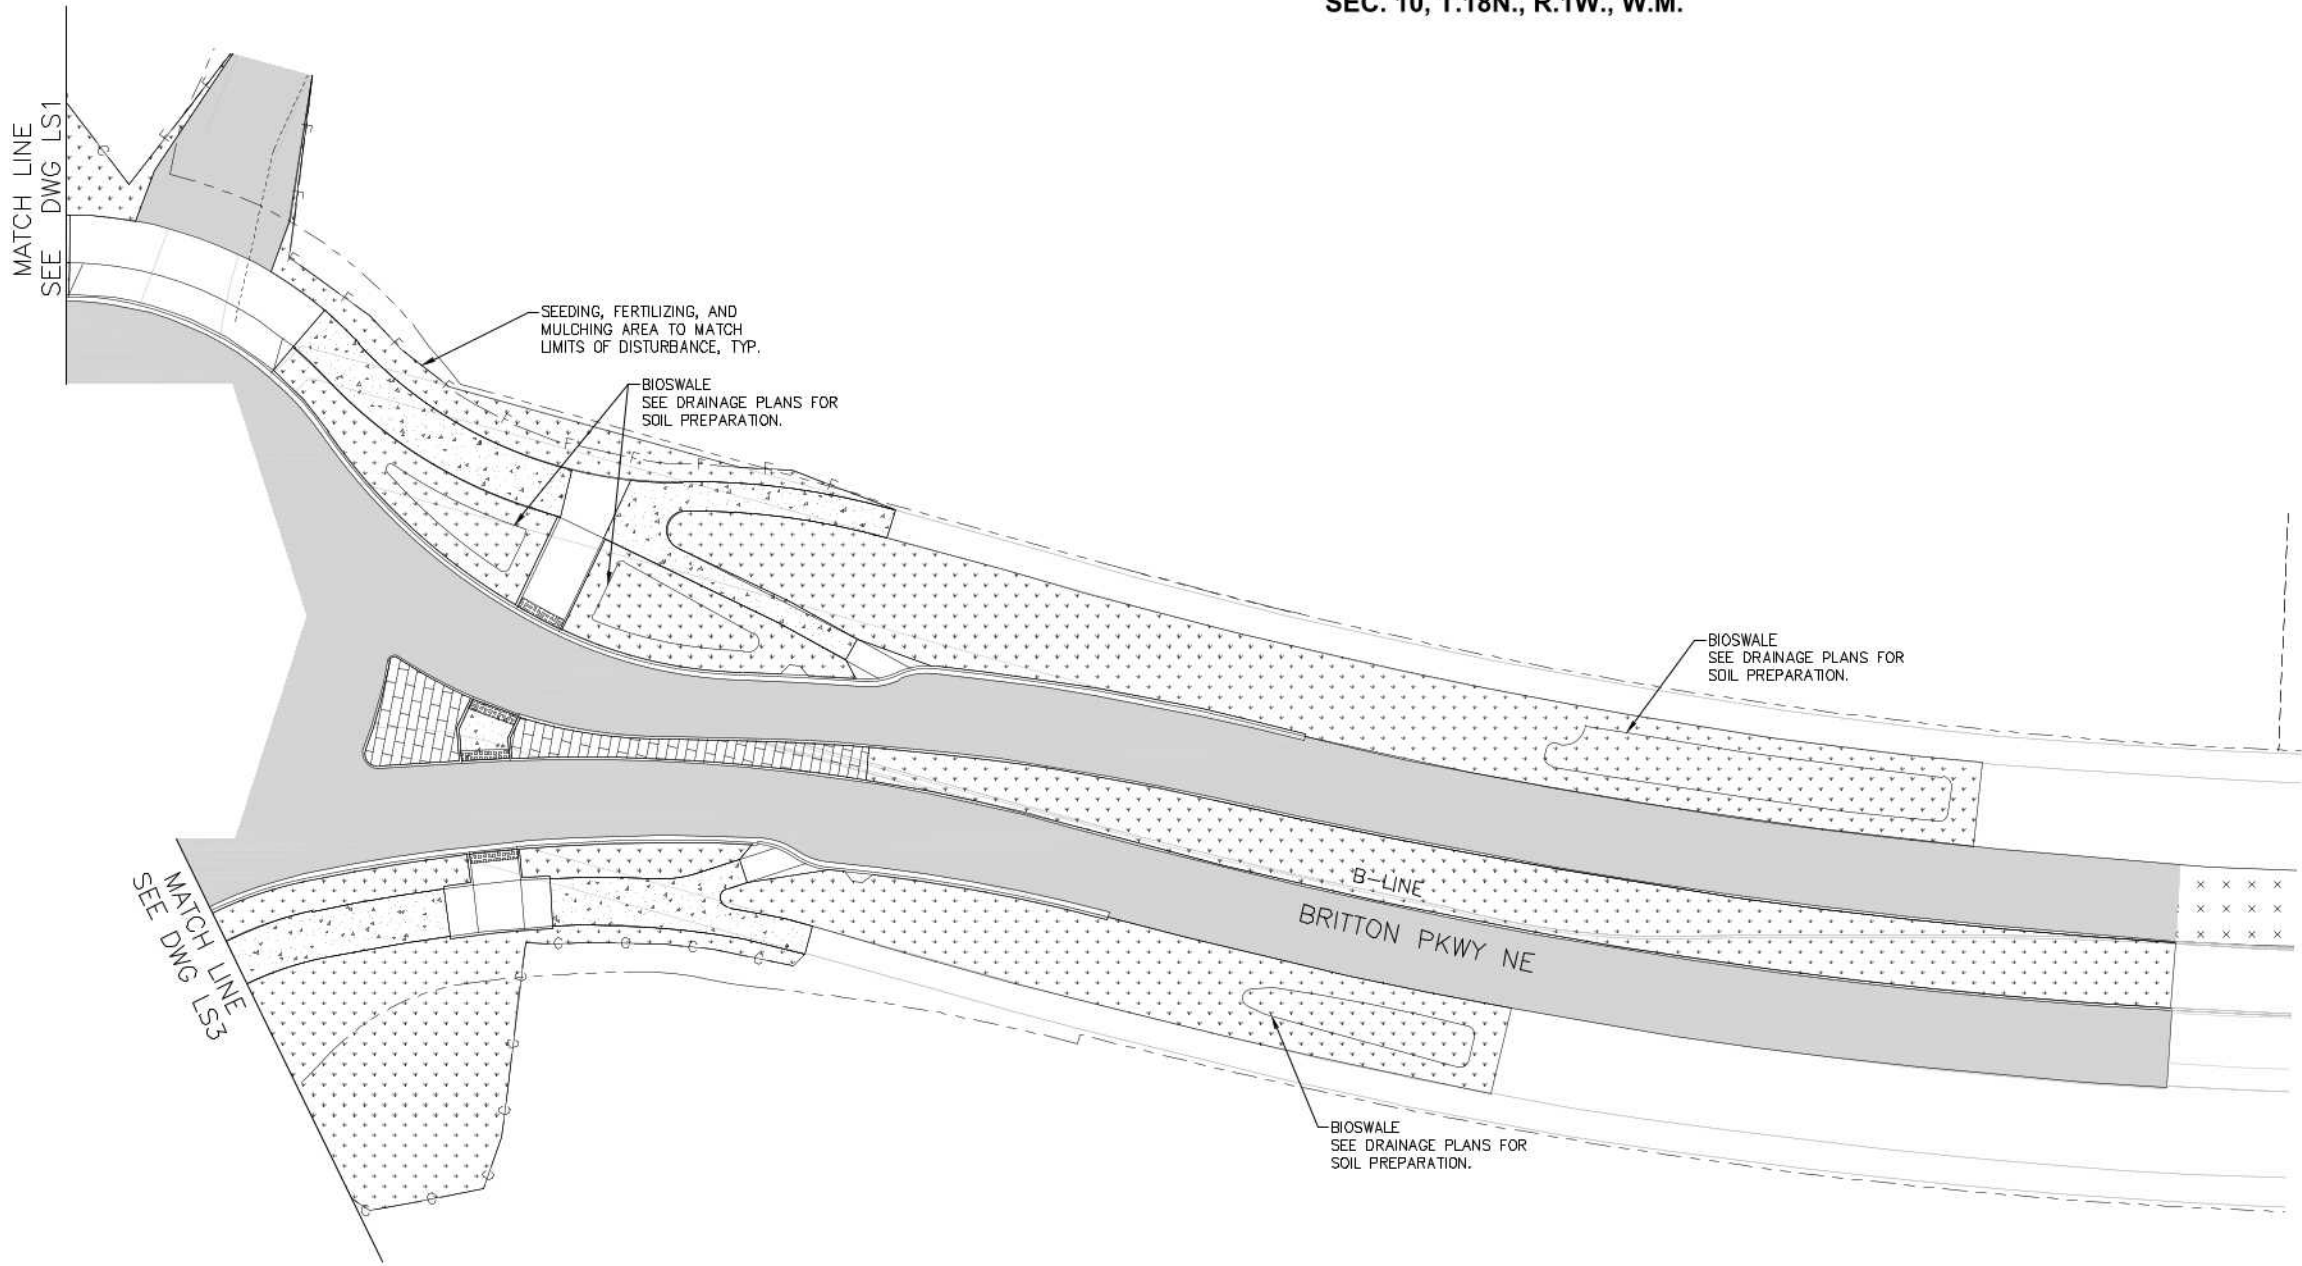GRASSES & PERENNIALS

QTY NAME



| | | |
|-----------|---|---|
| 17,000 SF | SEEDING, FERTILIZING, AND MULCHING SEE SPECIAL PROVISIONS | SEED MIX SHALL BE TURF TYPE PERENNIAL RYE BLEND - TWO OR MORE VARIETIES (50% BY WEIGHT), CHEWING FESCUE (30% BY WEIGHT), AND HARD FESCUE (20% BY WEIGHT). APPLICATION RATE SHALL 6 LBS PER 1,000 SQUARE FEET. |
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| APPROVED FOR CONSTRUCTION | | RDL |
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| ENGINEERING MANAGER | DATE | DESIGNED BY |
| PROJECT MANAGER | DATE | DRAWN BY |
| PROJECT ENGINEER | DATE | MER |
| | | CHECKED BY |
| | | APPROVED BY |
| | | DATE: 11/1/2023 |

**russell
lambert**
LANDSCAPE
ARCHITECTURE
7724 2nd Ave NE
Seattle, WA 98115
206.271.9620

LOCHNER

CITY OF LACEY

LACEY

CITY OF LACEY
CARPENTER ROAD ROUNDABOUT

LANDSCAPE PLAN


DRAWING NUMBER

LS2

SHT 57 OF 64



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PLANT SCHEDULE

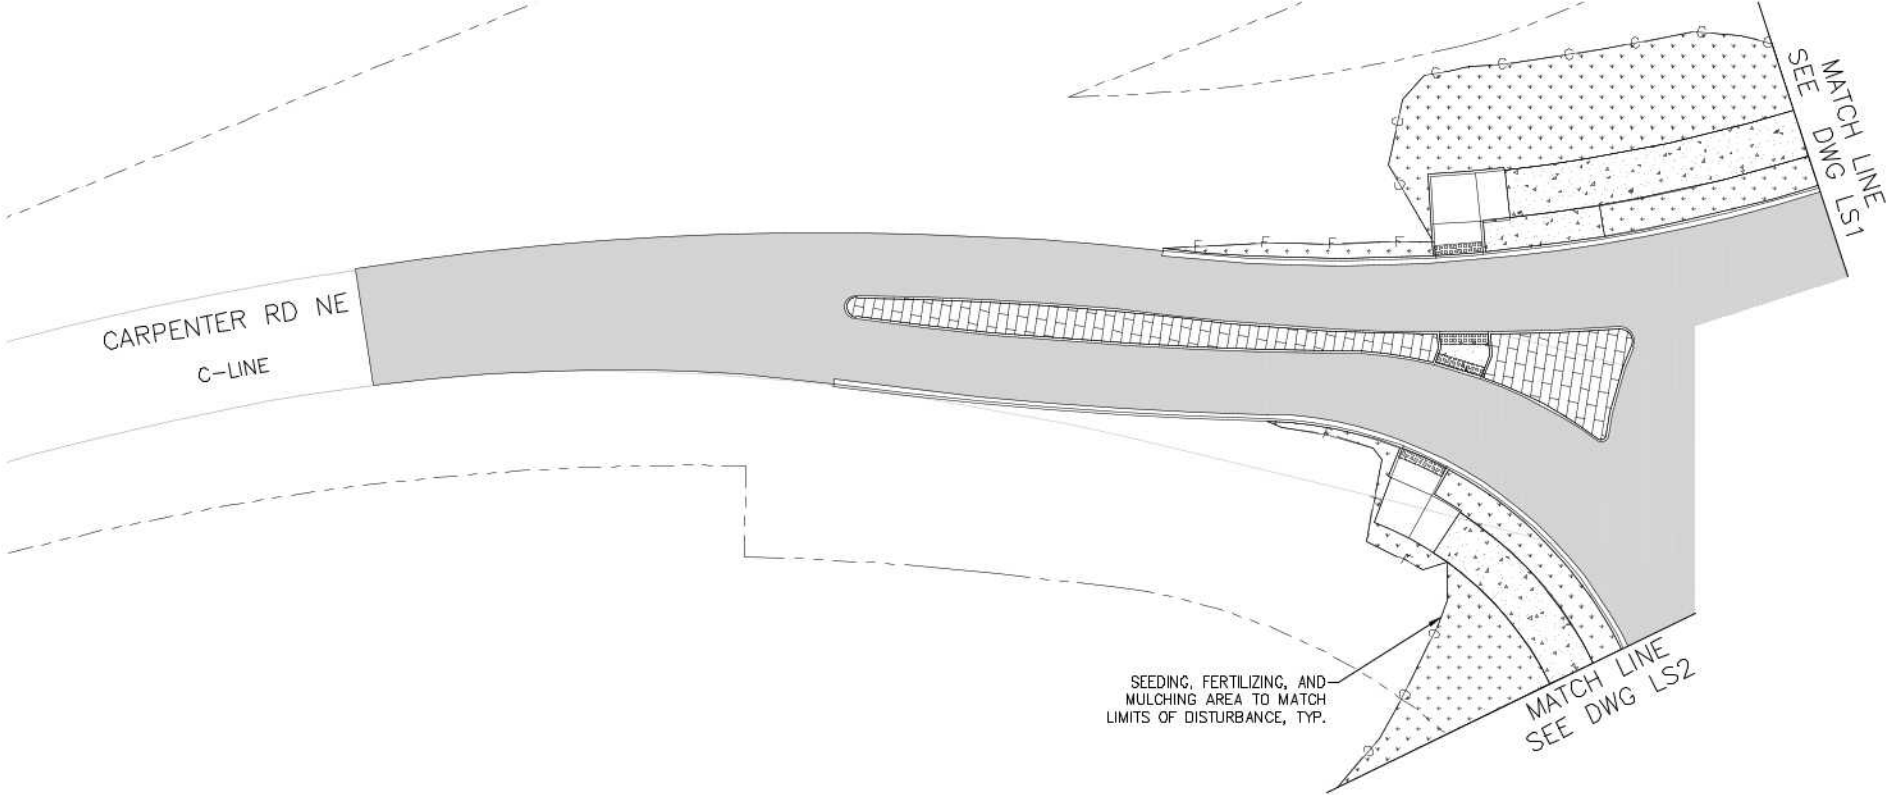GRASSES &
PERENNIALS

QTY NAME



3,320 SF

SEEDING, FERTILIZING, AND MULCHING
SEE SPECIAL PROVISIONS


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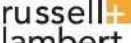
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| PROJECT MANAGER | DATE |
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| CHECKED BY | |
| APPROVED BY | |
| DATE: | 11/1/2023 |



STATE OF WASHINGTON
REGISTERED
LANDSCAPE ARCHITECT
RYAN D. LAMBERT
CERTIFICATE NO. 1180



**russell
lambert**
LANDSCAPE
ARCHITECTURE
7724 2nd Ave NE
Seattle, WA 98115
206.271.9620



LOCHNER



CITY OF LACEY

CITY OF LACEY
CARPENTER ROAD ROUNDABOUT

LANDSCAPE PLAN


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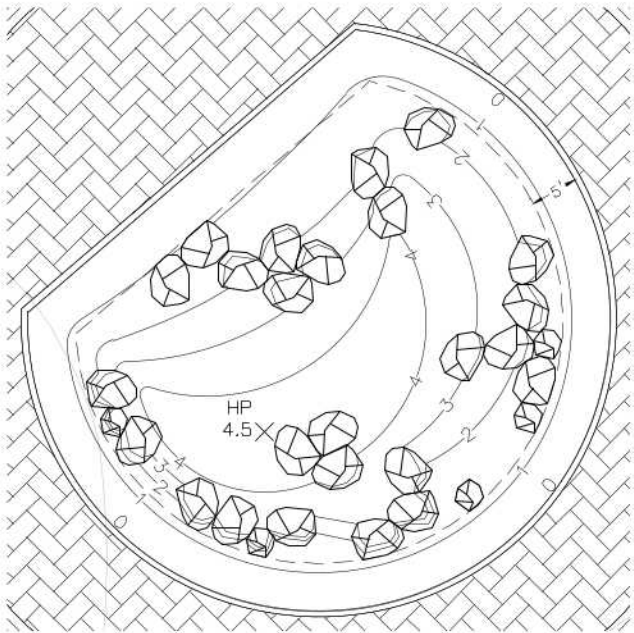
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A CENTER ISLAND PLANTING PLAN ENLARGEMENT
SCALE: 1" = 10'-0"



B CENTER ISLAND DETAIL GRADING PLAN
SCALE: 1" = 10'-0"

LEGEND

- STREAMBED BOULDER FOUR MAN
- STREAMBED BOULDER SIX MAN

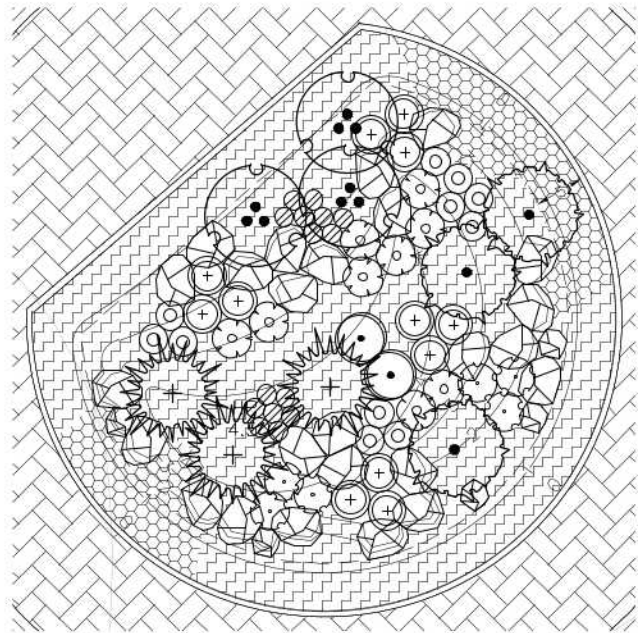GRADING NOTES:

1. CONTOUR UNITS ARE IN FEET.
2. GRADE CENTER ISLAND TO BE SMOOTH AND NATURAL IN APPEARANCE.
3. SLOPE ALL LANDSCAPE TO DRAIN AND TO BE FREE OF PUDDLES.
4. MINIMUM LANDSCAPE SLOPE SHALL BE 2%.
5. MAXIMUM LANDSCAPE SLOPE SHALL BE 2:1.
6. GRADING PLAN LAYOUT IS DIAGRAMMATIC AND MAY REQUIRE FIELD ADJUSTMENT PER DIRECTION OF THE OWNER'S REPRESENTATIVE.
7. ANY DISCREPANCIES BETWEEN THE DRAWINGS, SPEC'S, AND/OR SITE CONDITIONS SHALL BE BROUGHT TO THE ATTENTION OF THE OWNER'S REPRESENTATIVE PRIOR TO PROCEEDING WITH CONSTRUCTION.



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| RDL DRAWN BY | |
| MER CHECKED BY | |
| APPROVED BY | |
| DATE: | 11/1/2023 |



**russell
lambert**
LANDSCAPE
ARCHITECTURE
7724 2nd Ave NE
Seattle, WA 98115
206.271.9620

LOCHNER




**CITY OF LACEY
CARPENTER ROAD ROUNDABOUT**

PLANT SCHEDULE

| DRAWING NUMBER |
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| LS4 |
| SHT 59 OF 64 |

NOTES:


- 1) MULCH COMPLETELY BETWEEN ALL PLANTS.
2) PLANT SO THAT TOP OF ROOT BALL IS EVEN WITH FINISHED GRADE.
3) COMPLETELY REMOVE ALL WIRE AND FABRIC ON BALLED & BURLAPPED PLANTS.
4) SCARIFY SIDES OF PLANTING PITS PRIOR TO BACKFILLING.

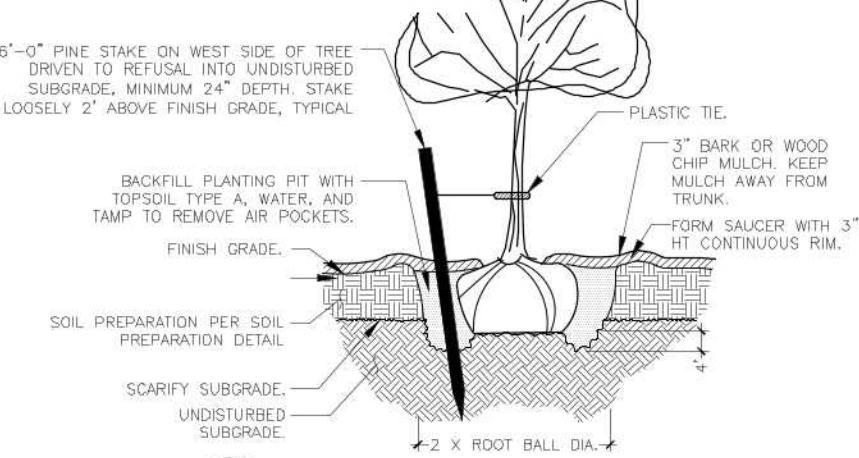

A TREE PLANTING IN LANDSCAPE PLANTING BED
NOT TO SCALE

NOTES:


- 1) MULCH COMPLETELY BETWEEN ALL PLANTS.
2) PLANT SO THAT TOP OF ROOT BALL IS EVEN WITH FINISHED GRADE.
3) COMPLETELY REMOVE ALL WIRE AND FABRIC ON BALLED & BURLAPPED PLANTS.
4) SCARIFY SIDES OF PLANTING PITS PRIOR TO BACKFILLING.

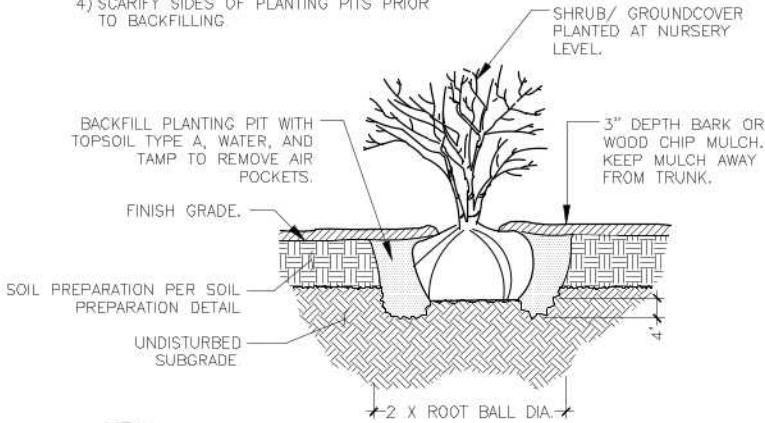


B TYPICAL SHRUB & GROUNDCOVER PLANTING
NOT TO SCALE

NOTE:


- 1) SEE DRAINAGE PLANS FOR SOIL PREPARATION AT BIOSWALES.

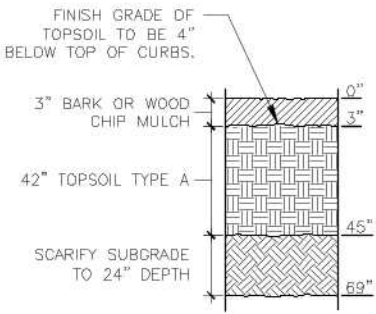


C CENTER ISLAND SOIL PREPARATION
NOT TO SCALE

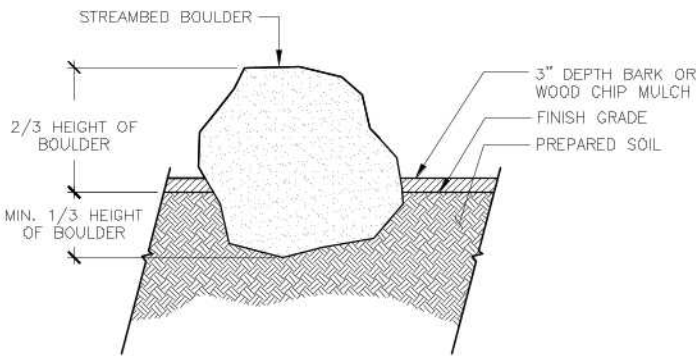

D STREAMBED BOULDER INSTALLATION
NOT TO SCALE

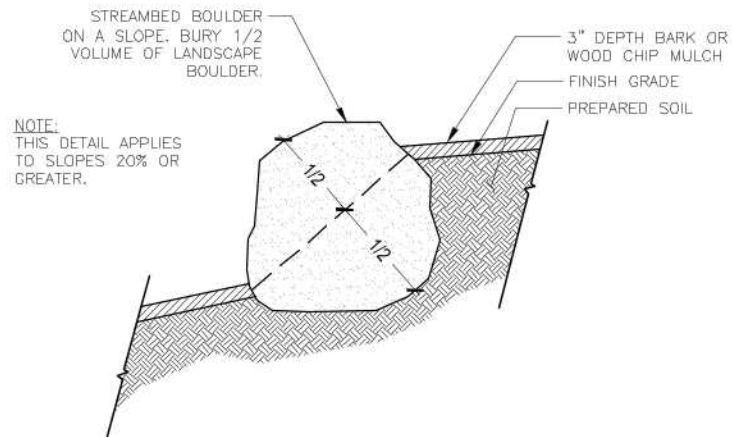

E STREAMBED BOULDER INSTALLATION ON SLOPE
NOT TO SCALE

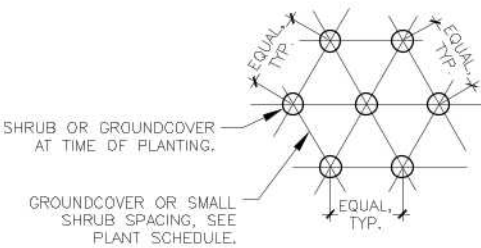

F TYPICAL GROUNDCOVER SPACING
NOT TO SCALE


20 0 20 40
SCALE IN FEET



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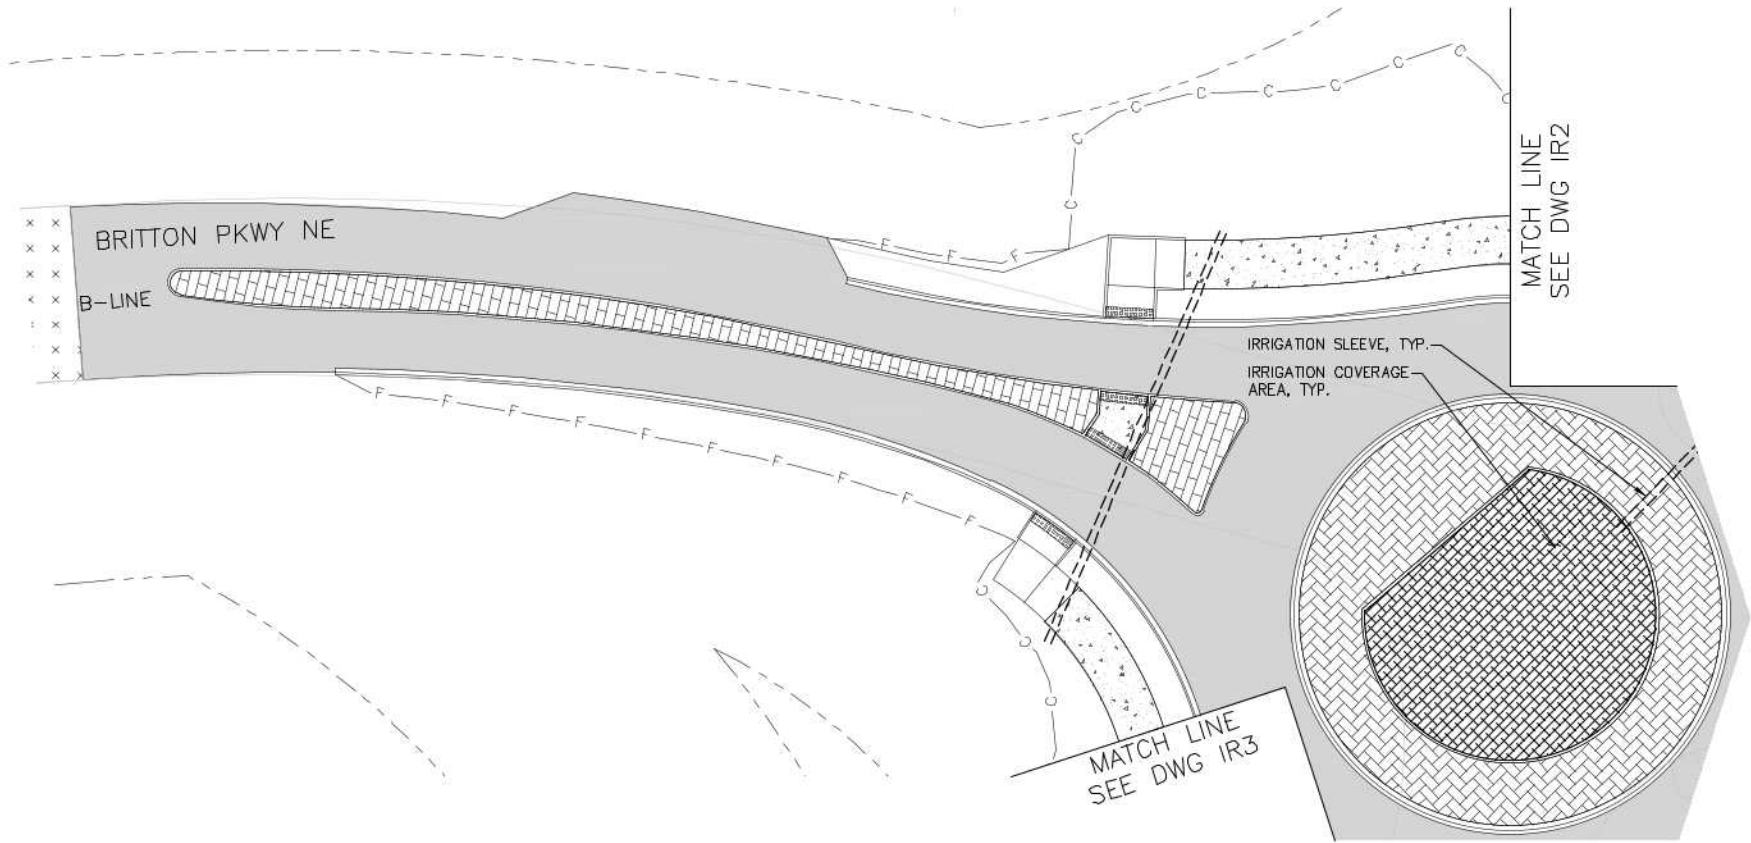


| CITY OF LACEY CARPENTER ROAD ROUNDABOUT | |
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| LANDSCAPE DETAILS | |

| DRAWING NUMBER |
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| LS5 |
| SHT 60 OF 64 |
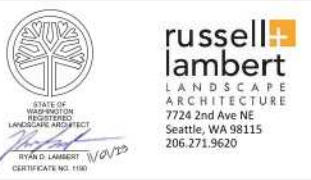
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SEC. 10, T.18N., R.1W., W.M.



IRRIGATION NOTES

1. CONTRACTOR SHALL DESIGN AND INSTALL IRRIGATION SYSTEM PER SPECIFICATIONS AND SPECIAL PROVISIONS.
2. IRRIGATION SYSTEM SHALL BE DESIGNED AND INSTALLED IN ACCORDANCE WITH THE REQUIREMENTS OF THE CITY OF LACEY.
3. ANY DISCREPANCIES BETWEEN THE DRAWINGS, SPEC'S, AND/OR SITE CONDITIONS SHALL BE BROUGHT TO THE ATTENTION OF THE OWNER'S REPRESENTATIVE PRIOR TO PROCEEDING WITH CONSTRUCTION.

IRRIGATION LEGEND

- IRRIGATION COVERAGE AREA
- POINT OF CONNECTION
- IRRIGATION SLEEVE



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lambert**
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7724 2nd Ave NE
Seattle, WA 98115
206.271.9620


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**CITY OF LACEY
CARPENTER ROAD ROUNDABOUT**

IRRIGATION PLAN, NOTES, AND LEGEND

| DRAWING NUMBER |
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| IR1 |
| SHT 61 OF 64 |



IRRIGATION NOTES
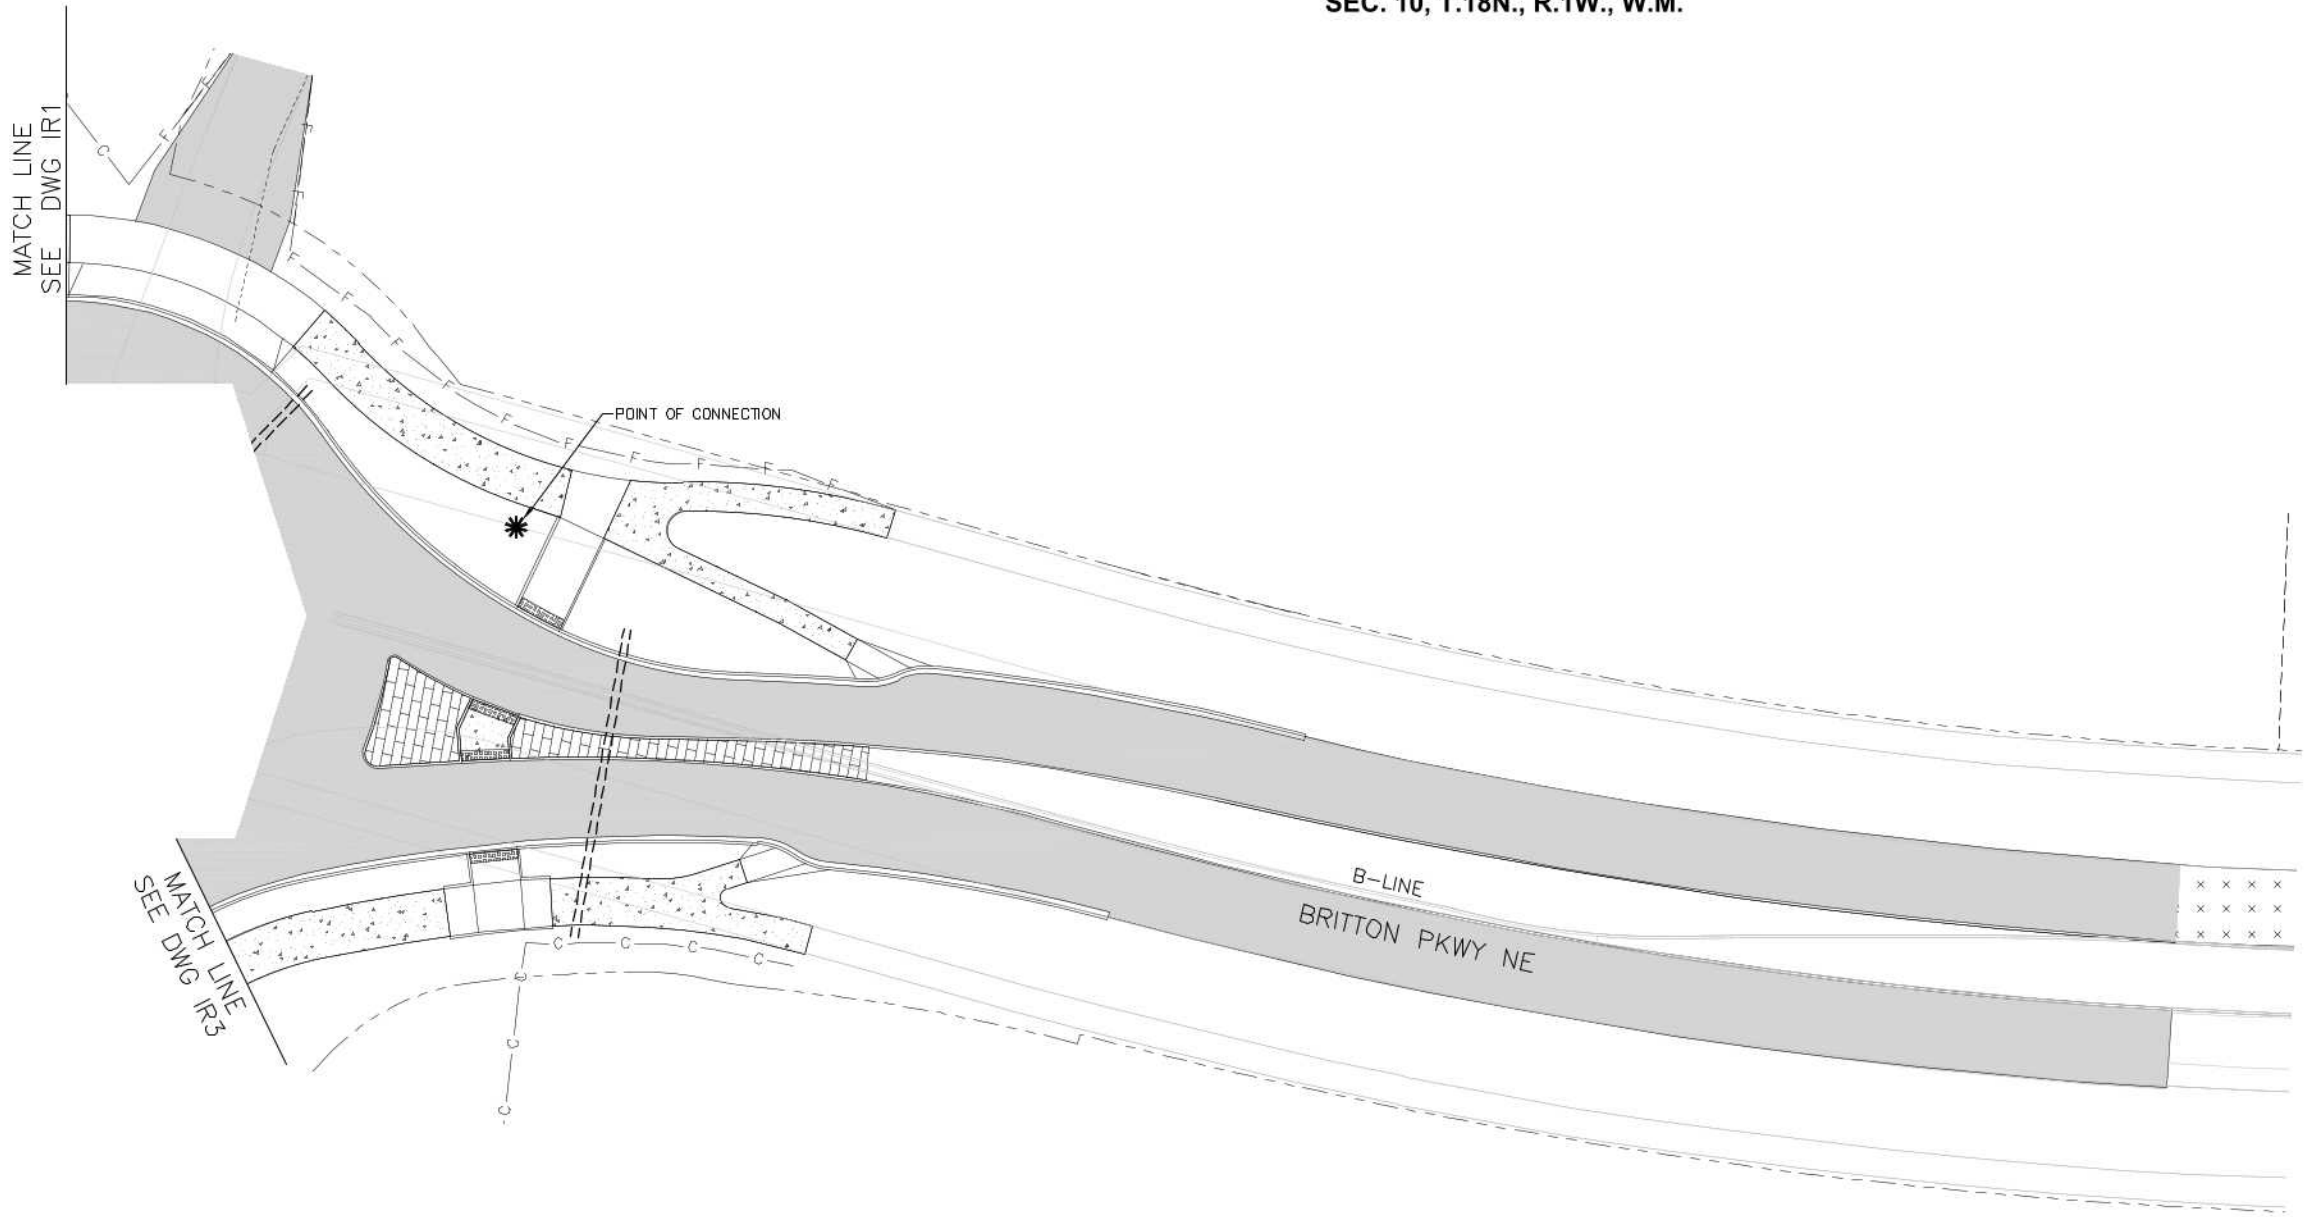
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IRRIGATION LEGEND

- IRRIGATION COVERAGE AREA
- POINT OF CONNECTION
- IRRIGATION SLEEVE



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| APPROVED BY | DATE: 11/1/2023 |

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lambert**
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7724 2nd Ave NE
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LOCHNER

CITY OF LACEY

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CARPENTER ROAD ROUNDABOUT
IRRIGATION PLAN, NOTES, AND LEGEND

DRAWING NUMBER
IR2
SHT 62 OF 64

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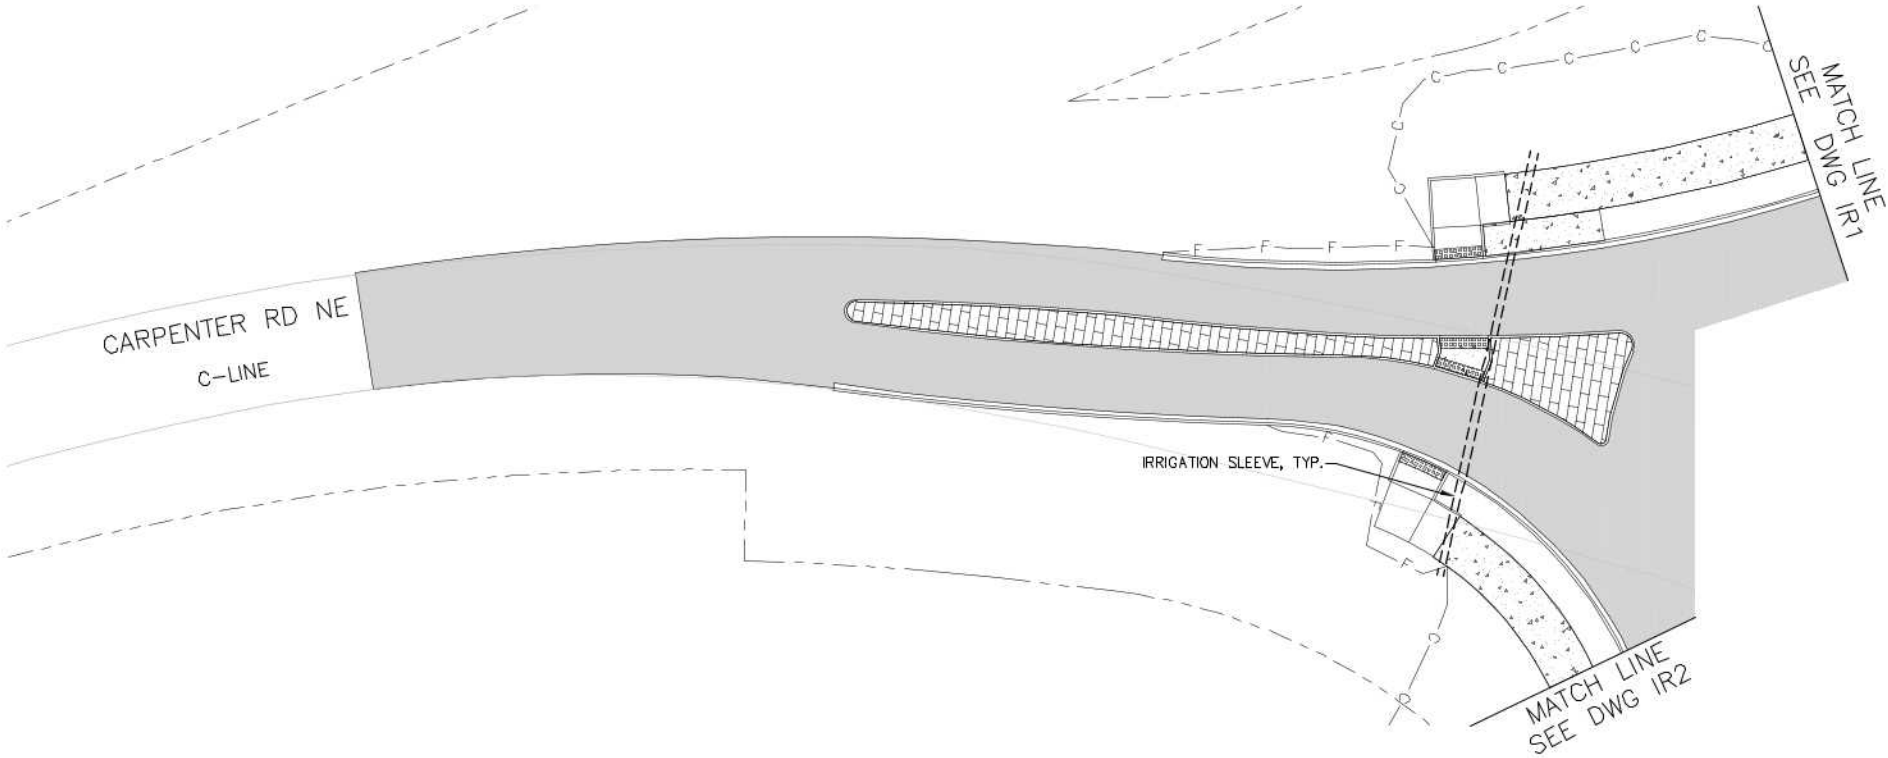


IRRIGATION NOTES

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IRRIGATION LEGEND

-  IRRIGATION COVERAGE AREA
-  POINT OF CONNECTION
-  IRRIGATION SLEEVE



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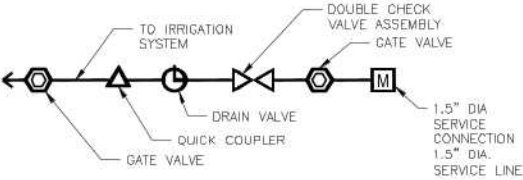
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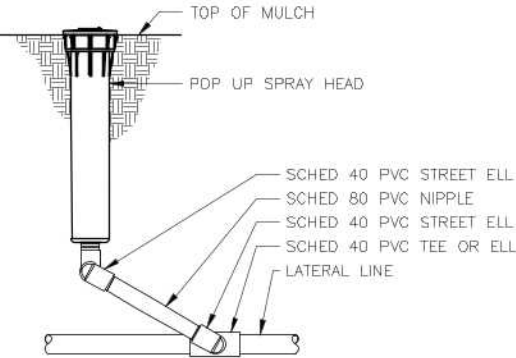


CITY OF LACEY
CARPENTER ROAD ROUNDABOUT
IRRIGATION PLAN, NOTES, AND LEGEND


| DRAWING NUMBER |
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| IR3 |
| SHT 63 OF 64 |




A POINT OF CONNECTION
SCALE: NOT TO SCALE




B POP-UP SPRAY HEAD
SCALE: NOT TO SCALE

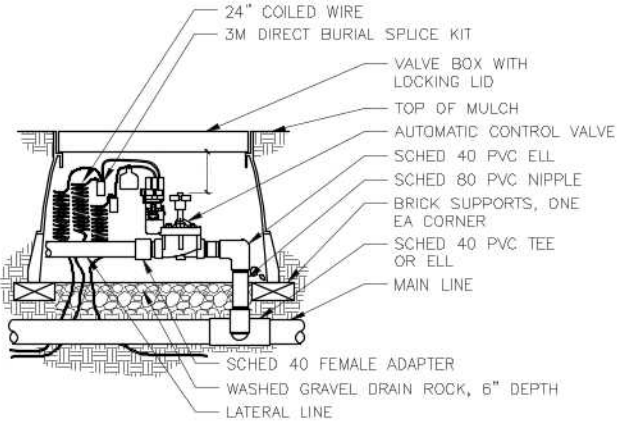


C AUTOMATIC CONTROL VALVE
SCALE: NOT TO SCALE

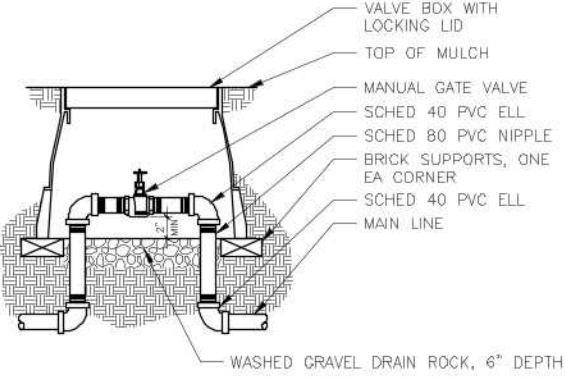


D GATE VALVE
SCALE: NOT TO SCALE

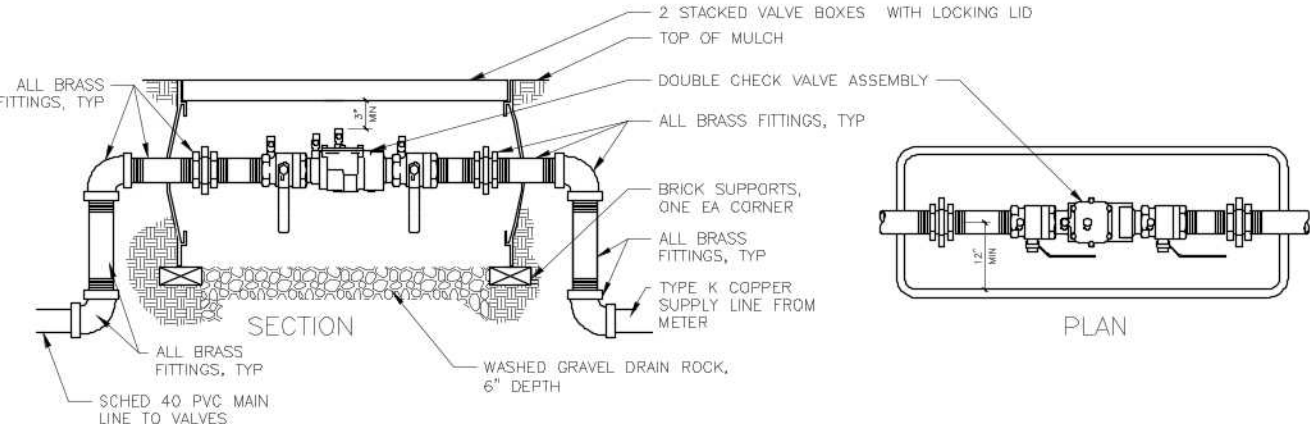


E BACKFLOW PREVENTER
SCALE: 1/2" = 1' - 0"

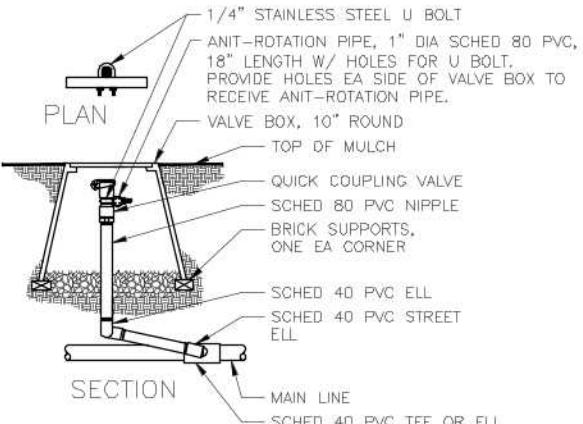


F QUICK COUPLING VALVE
SCALE: NOT TO SCALE

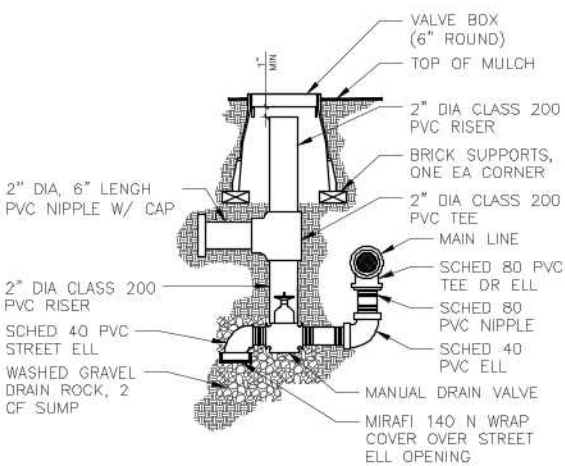

G MANUAL DRAIN VALVE
SCALE: NOT TO SCALE

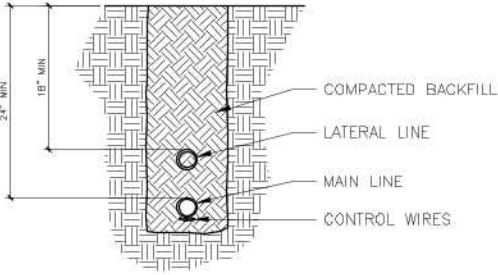

H MAIN AND/OR LATERAL LINE PIPE TRENCH
SCALE: NOT TO SCALE

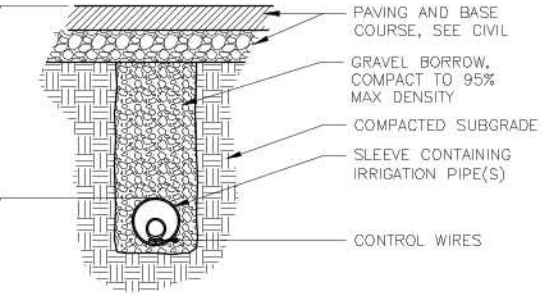

I IRRIGATION SLEEVE
SCALE: NOT TO SCALE



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| CITY OF LACEY CARPENTER ROAD ROUNDABOUT | |
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| IRRIGATION DETAILS | |

| DRAWING NUMBER |
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| IR4 |
| SHT 64 OF 64 |