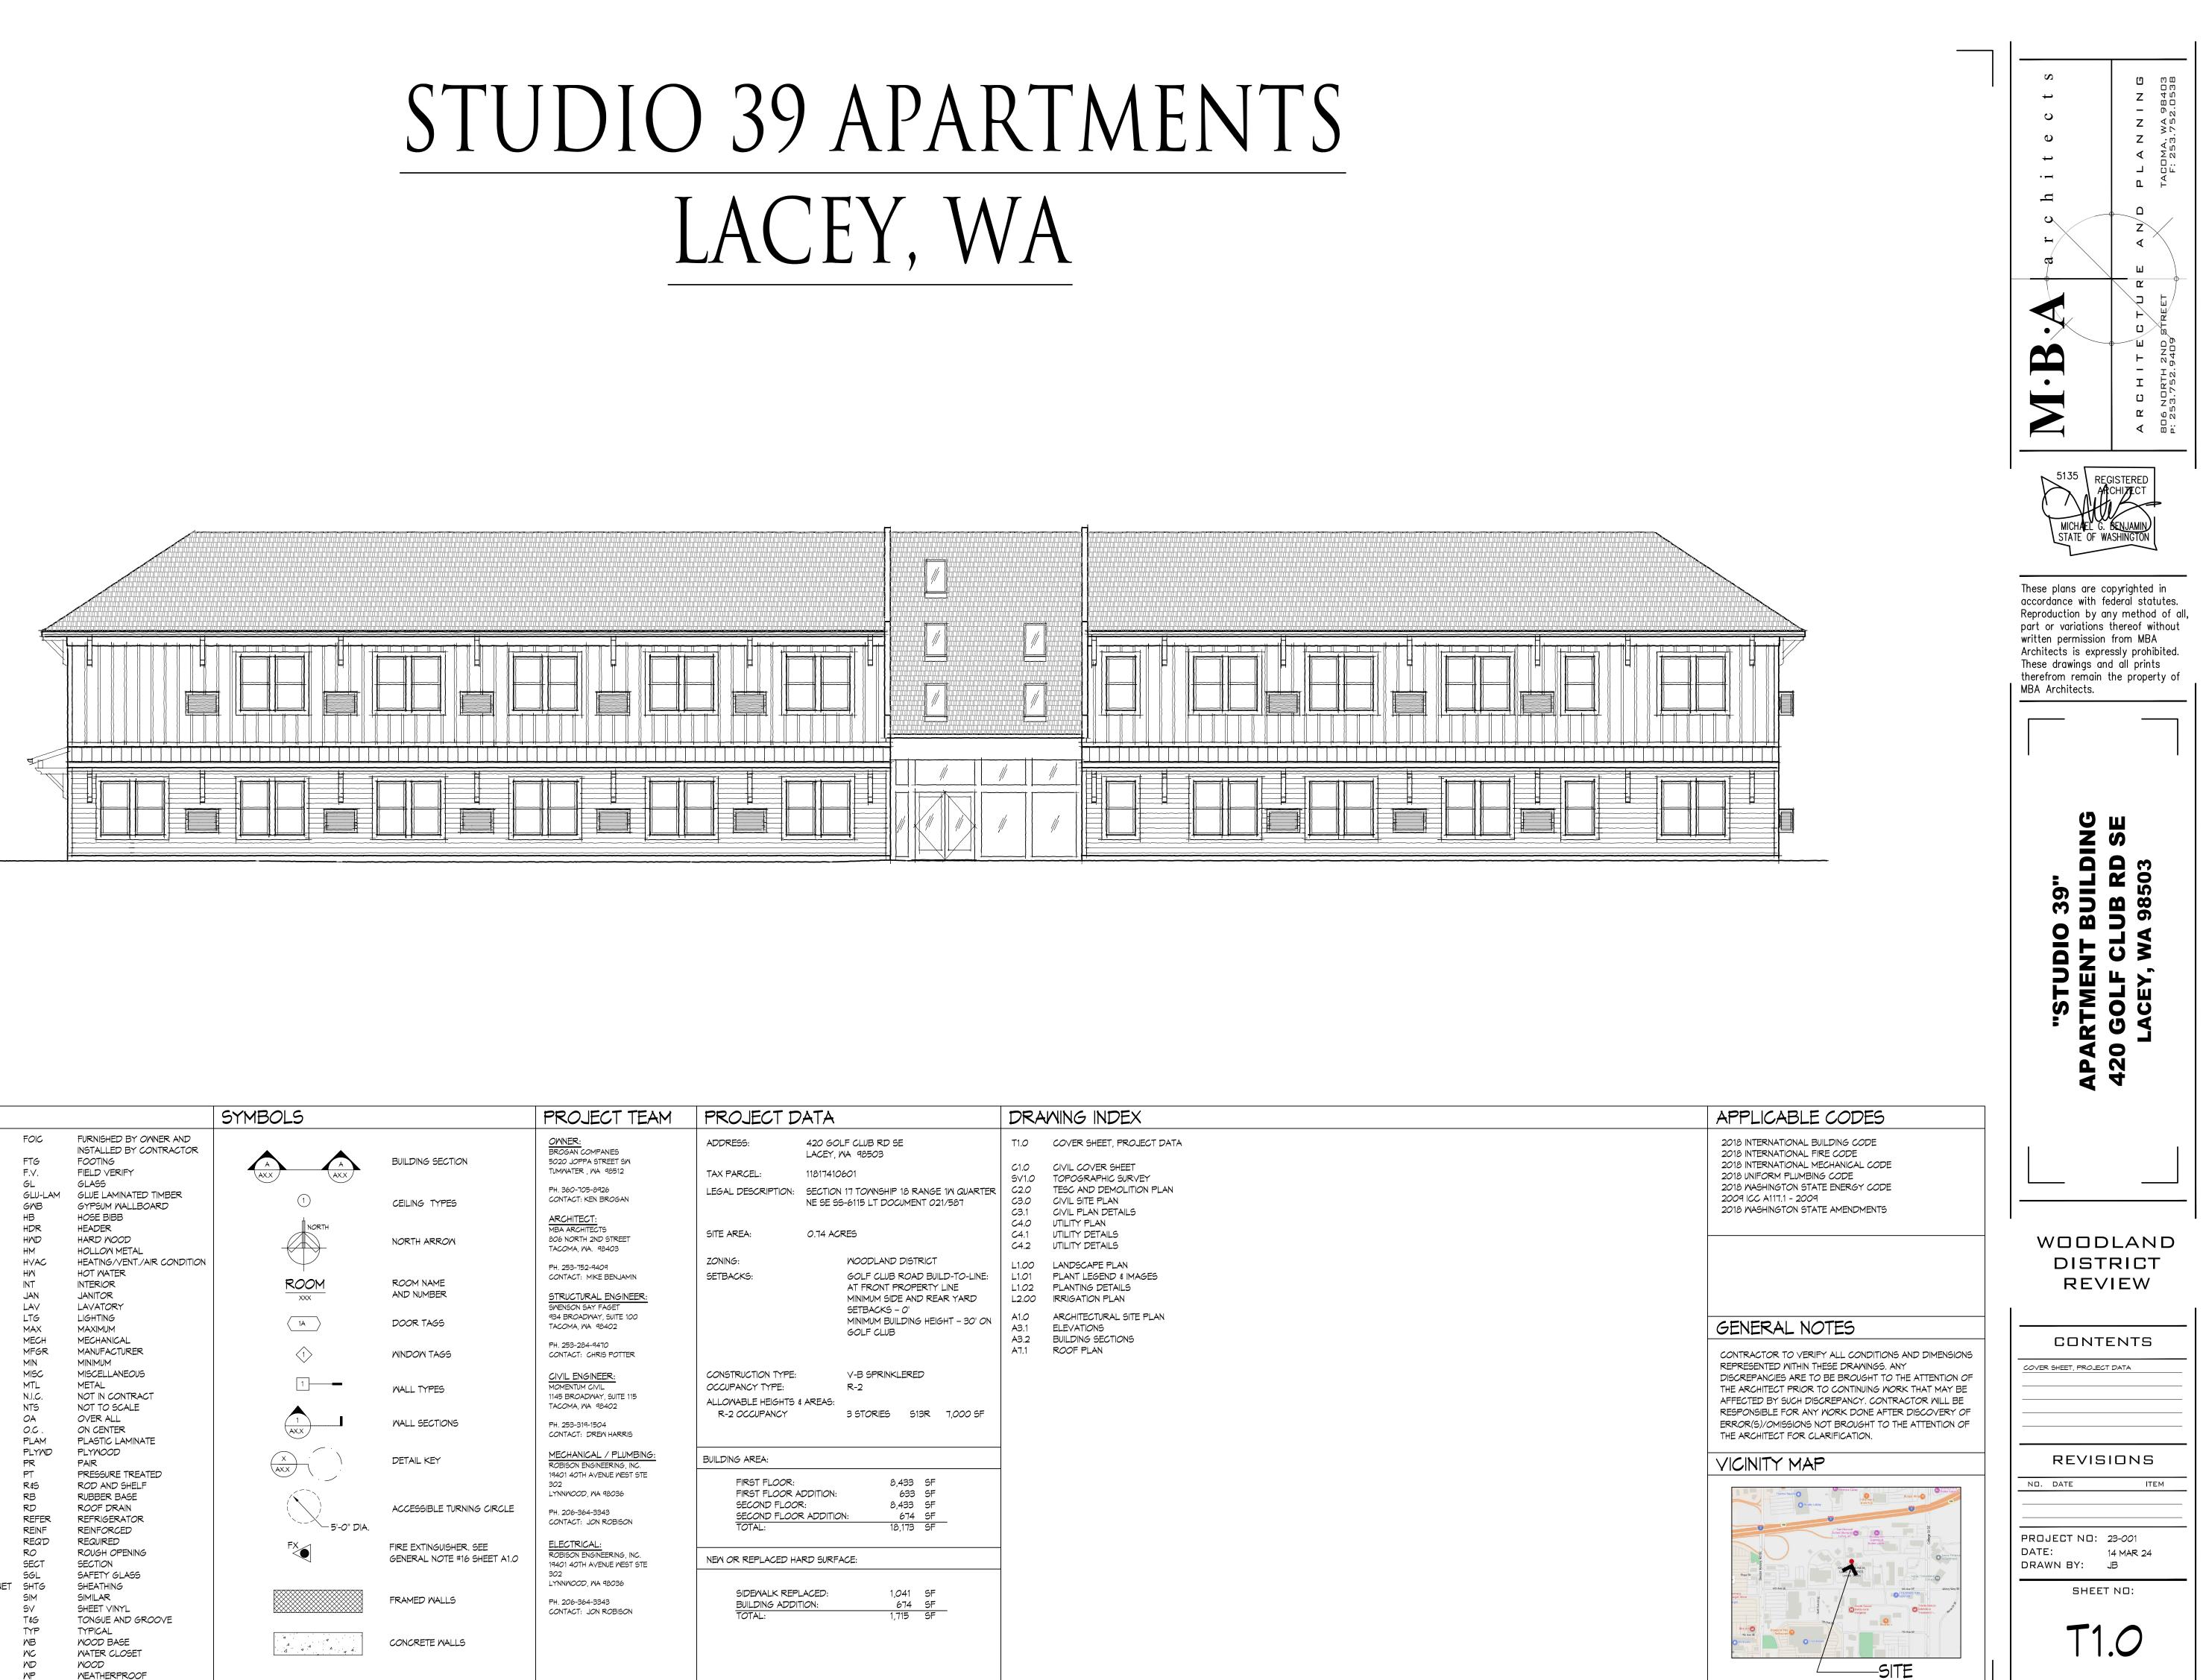
LACEY, WA



BBRE	VIATIONS			SYMBOLS		PR
AB	ANCHOR BOLT	FOIC	FURNISHED BY OWNER AND			OW
ACOUS	ACOUSTICAL		INSTALLED BY CONTRACTOR			BRC
ACT	ACOUSTICAL TILE	FTG	FOOTING		BUILDING SECTION	5020
ADJ	ADJUSTABLE /ADJACENT	F.∨.	FIELD VERIFY			TUM
AFF	ABOVE FINISHED FLOOR	GL	GLASS			
ALT	ALTERNATE	GLU-LAM	GLUE LAMINATED TIMBER			PH. 3 CON
ALUM	ALUMINUM	GNB	GYPSUM WALLBOARD		CEILING TYPES	CON
APPROX	APPROXIMATE	HВ	HOSE BIBB	1		ARC
ARCH	ARCHITECT	HDR	HEADER	NORTH		MBA
AUTO	AUTOMATIC	HND	HARD WOOD		NORTH ARROW	806
BLKG	BLOCKING	НM	HOLLOW METAL			TAC
BOT	BOTTOM	HVAC	HEATING/VENT./AIR CONDITION			-
BRG	BEARING	HМ	HOT WATER			PH. : CON
BU	BUILT UP	INT	INTERIOR	ROOM	ROOM NAME	
LJ	CONTROL JOINT	JAN	JANITOR		AND NUMBER	STR
CL	CENTER LINE	LAV	LAVATORY			SME
CLG	CEILING	LTG	LIGHTING			934
CLR	CLEAR	MAX	MAXIMUM		DOOR TAGS	TAC
CMU	CONCRETE MASONRY UNIT	MECH	MECHANICAL			
<i>CO</i>	CLEAN OUT	MFGR	MANUFACTURER	$\langle 1 \rangle$	WINDOW TAGS	PH. 2 CON
COL	COLUMN	MIN	MINIMUM			
CONC	CONCRETE	MISC	MISCELLANEOUS			CIV
CPT	CARPET	MTL	METAL	1	WALL TYPES	MON
C.T.	CERAMIC TILE	N.I.C.	NOT IN CONTRACT		NALL ITFES	1145
DBL	DOUBLE	NTS	NOT TO SCALE			TAC
DF	DRINKING FOUNTAIN	OA	OVER ALL		WALL SECTIONS	
DIA	DIAMETER	0.0.	ON CENTER	AX.X	MALL SECTIONS	PH. : CON
DIAG	DIAGONAL	PLAM	PLASTIC LAMINATE			
DIM	DIMENSION	PLYND	PLYWOOD			MEC
DISP	DISPENSER	PR	PAIR		DETAIL KEY	ROB
DN	DOWN	PT	PRESSURE TREATED	AX.X		1940
DS	DOWNSPOUT	RŧS	ROD AND SHELF			302
DWG	DRAWING	RB	RUBBER BASE			LYN
EA	EACH	RD	ROOF DRAIN		ACCESSIBLE TURNING CIRCLE	PH. :
ELEC	ELECTRIC	REFER	REFRIGERATOR			CON
EQ	EQUAL/EQUIP/EQUIPMENT	REINF	REINFORCED	5'-0" DIA.		
EX	EXISTING	REQ'D	REQUIRED	FX 🚽		ELE
EXT	EXTERIOR	RO	ROUGH OPENING	FX	FIRE EXTINGUISHER. SEE GENERAL NOTE #16 SHEET A1.0	ROB
FD	FLOOR DRAIN	SECT	SECTION		GENERAL NOTE #16 SHEET AT.O	1940
FE	FIRE EXTINGUISHER	SGL	SAFETY GLASS			302
FE&C	FIRE EXTINGUISHER & CABINET	SHTG	SHEATHING	<u></u>		LYN
DISP	DISPENSER/DISPOSAL	SIM	SIMILAR		FRAMED WALLS	PH. :
FF	FINISHED FLOOR	SV	SHEET VINYL			CON
FIN	FINISH	T\$G	TONGUE AND GROOVE			
FLR	FLOOR	TYP	TYPICAL	· · · · · · · · · · · · · · · · · · ·		1
FLOUR	FLUORESCENT	MB	WOOD BASE		CONCRETE WALLS	1
FND	FOUNDATION	MC	WATER CLOSET			1
FOC	FACE OF CONCRETE	ND	WOOD			1
		WP	WEATHERPROOF			1

ROJECT TEAM	PROJECT DATA			WING INDEX
NNER: Ogan companies	ADDRESS:	420 GOLF CLUB RD SE LACEY, WA 98503	T1.0	COVER SHEET, PROJECT DATA
20 JOPPA STREET SM 1WATER , WA 98512	TAX PARCEL:	11817410601	C1.0 SV1.0	CIVIL COVER SHEET TOPOGRAPHIC SURVEY
360-705-8926 NTACT: KEN BROGAN	LEGAL DESCRIPTION:	SECTION 17 TOWNSHIP 18 RANGE 1W QUARTER NE SE SS-6115 LT DOCUMENT 021/587	C2.0 C3.0	TESC AND DEMOLITION PLAN CIVIL SITE PLAN
CHITECT: A ARCHITECTS	SITE AREA:	0.74 ACRES	C3.1 C4.0 C4.1	CIVIL PLAN DETAILS UTILITY PLAN UTILITY DETAILS
6 NORTH 2ND STREET COMA, WA. 98403			C4.2	UTILITY DETAILS
253-752-9409	ZONING:	WOODLAND DISTRICT	L1.00	LANDSCAPE PLAN
NTACT: MIKE BENJAMIN RUCTURAL ENGINEER:	SETBACKS:	GOLF CLUB ROAD BUILD-TO-LINE: AT FRONT PROPERTY LINE MINIMUM SIDE AND REAR YARD	L1.01 L1.02 L2.00	PLANT LEGEND & IMAGES PLANTING DETAILS IRRIGATION PLAN
ENSON SAY FAGET		SETBACKS - O'		ARCHITECTURAL SITE PLAN
BROADWAY, SUITE 100 COMA, WA 98402		MINIMUM BUILDING HEIGHT - 30' ON GOLF CLUB	A1.0 A3.1 A3.2	ARCHITECTURAL SHE FLAN ELEVATIONS BUILDING SECTIONS
253-284-9470 NTACT: CHRIS POTTER			A7.1	ROOF PLAN
VIL ENGINEER: MENTUM CIVIL 5 BROADWAY, SUITE 115 COMA, WA 98402	CONSTRUCTION TYPE: OCCUPANCY TYPE: ALLOWABLE HEIGHTS & R-2 OCCUPANCY	V-B SPRINKLERED R-2 # AREAS: 3 STORIES S13R 7,000 SF		
253-319-1504 NTACT: DREW HARRIS				
CHANICAL / PLUMBING: BISON ENGINEERING, INC.	BUILDING AREA:			
01 40TH AVENUE WEST STE 2	FIRST FLOOR:	8,433 SF		
NNWOOD, WA 98036	FIRST FLOOR A SECOND FLOOF			
206-364-3343 NTACT: JON ROBISON	SECOND FLOOP	R ADDITION: 674 SF		
	TOTAL:	18,173 SF		
ECTRICAL: BISON ENGINEERING, INC. 01 40TH AVENUE WEST STE	NEW OR REPLACED HA	RD SURFACE:		
2 NNWOOD, WA 98036				
206-364-3343	SIDEWALK REPI BUILDING ADDI			
NTACT: JON ROBISON	TOTAL:	1,715 SF		

DEVELOPMENT TEAM

OWNER / APPLICANT

DAVE KNITTLE & BOB PRESLEY PO BOX 67 OLYMPIA, WA 98507 CONTACT: DAVE KNITTLE EMAIL: DKCONCRETELLC@AOL.COM PHONE: (360) 329-1634

CIVIL ENGINEER

MOMENTUM CIVIL 1145 BROADWAY, SUITE 115 TACOMA. WA 98402 CONTACT: DREW HARRIS, P.E. EMAIL: DREWH@MOMENTUMCIVIL.COM PHONE: (253) 722-6059

CONTACT: TONY CALLAHAN, P.E. EMAIL: TONYC@MOMENTUMCIVIL.COM PHONE: (563) 451-2623

SURVEYOR

INFORMED LAND SURVEY PO BOX 5137 **TACOMA, WA 98415** CONTACT: EVAN WAHLSTROM, PLS EMAIL: EWAHLSTORM@I-LANDSURVEY.COM PHONE: (253) 507-7787 EXT. 1004

ARCHITECT

M.B.A ARCHITECTS 806 N 2ND STREET TACOMA, WA 98403 CONTACT: LAWERENCE ARANDA PHONE: 253-752-9409 EMAIL: LAWRENCE@MBAARCHITECTS.COM

GENERAL NOTES

- CONTRACTOR SHALL PROVIDE TRAFFIC CONTROL PLAN TO THE CITY OF LACEY PUBLIC WORKS FOR REVIEW AND OBTAIN APPROVAL PRIOR TO ANY WORK WITHIN THE
- RIGHT-OF-WAY. MOMENTUM CIVIL ASSUMES NO RESPONSIBILITY FOR TRAFFIC CONTRO ALL WORKMANSHIP AND MATERIALS SHALL CONFORM TO THE CITY OF LACEY STANDARDS. IF CITY OF LACEY STANDARDS DO NOT ADDRESS A PROJECT ELEMENT, THEN THE LATEST VERSION OF THE WSDOT STANDARD SPECIFICATIONS FOR ROAD, BRIDGE
- AND MUNICIPAL CONSTRUCTION SHALLY APPLY UNLESS SUPERSEDED BY THIS PLAN SET OR AN ORDER OF THE ENGINEER OR OWNER. CONTRACTOR TO INSTALL IRRIGATION SLEEVING AND ELECTRICAL AND LIGHTING
- CONDUIT BASED ON LANDSCAPE AND ELECTRICAL/LIGHTING PLANS, RESPECTIVELY

SITE INFORMATION

PARCEL NUMBER(S): 8612030015 PROJECT ADDRESS: 420 GOLF CLUB RD SE LACEY, WA 98503 PARCEL AREA: 32.387 SF (0.74 ACRES

SURFACE COVERAGE SUMMARY:

FILL VOLUM NET VOLUM

NEW AND REPLACED IMPERVIOUS SURFACE:	2,325+/- SF (0.05 AC)
EFFECTIVE IMPERVIOUS SURFACE:	2,325+/- SF (0.05 AC)
NEW & REPLACED POLLUTION GENERATING HARD SURFACE:	76+/- SF (0.002 AC)
LANDSCAPING/TOPSOIL AMENDMENT AREA:	535+/- SF (0.01 AC)
TOTAL DISTURBED AREA:	2,860+/- SF (0.07 AC)
SITE VOLUME CALCULATIONS	
CUT VOLUME	3 CY

3 CY <FILL>

EARTHWORK NOTE: ALL VOLUMES ARE APPROXIMATE AND ARE PROVIDED FOR PERMITTING PURPOSES ONLY AND REPRESENT THE FINISH GRADE TO EXISTING GRADE AS SHOWN ON THE PLANS. CONTRACTOR SHALL RELY ON THEIR OWN ESTIMATES FOR DETERMINING ACTUAL EARTHWORK QUANTITIES. THE VOLUMES LISTED ABOVE DO NOT ACCOUNT FOR STRIPPINGS, IMPORTED SUBGRADE MATERIALS, PAVEMENT DEPTHS, TRENCHING, STRUCTURAL EXCAVATION, EXPANSION/COMPACTION FACTORS, OR ANY SOIL TYPE RESTRICTIONS.

TOPOGRAPHIC SURVEY DISCLAIMER

THE EXISTING CULTURAL AND TOPOGRAPHIC DATA SHOWN ON THESE PLANS HAS BEEN PREPARED BASED UPON INFORMATION FURNISHED BY OTHERS. WHILE THIS INFORMATION IS BELIEVED TO BE RELIABLE, MOMENTUM CIVIL CANNOT ENSURE ITS ACCURACY AND THUS IS NOT RESPONSIBLE FOR THE ACCURACY OF THAT INFORMATION OR FOR ANY ERRORS OR OMISSIONS WHICH MAY HAVE BEEN INCORPORATED INTO THESE PLANS AS A RESULT.

FIRE SPRINKLER DESIGN

AN APPROVED NATIONAL FIRE PROTECTION ASSOCIATION (NFPA) FIRE SPRINKLER SYSTEM IS REQUIRED FOR THE PROPOSED STRUCTURE. REFER TO FIRE SPRINKLER PLANS PREPARED BY OTHERS FOR ALL INTERIOR COMPONENTS.

FILL SPECIFICATION

FILL MATERIAL SHALL NOT CONTAIN PETROLEUM PRODUCTS, OR ANY KNOWN SUBSTANCES THAT ARE TOXIC. HAZARDOUS, DANGEROUS, OR WHICH OTHERWISE VIOLATE ANY STATE, FEDERAL, OR LOCAL LAW, ORDINANCE CODE, REGULATION RULE, ORDER. OR STANDARD OF AN AGENCY HAVING JURISDICTION . ALL FILL MATERIAL SHALL BE EARTHEN, BE CAPABLE OF COMPACTION IN COMPLIANCE WITH ASTM D1557, AND BE IN COMPLIANCE WITH THE PROJECT-SPECIFIC GEOTECHNICAL RECOMMENDATIONS.

POST-CONSTRUCTION SOIL QUALITY AND DEPTH

ALL DISTURBED SOILS THAT ARE TO REMAIN VEGETATED IN THE POST-DEVELOPED CONDITION SHALL BE AMENDED IN-PLACE TO COMPLY WITH DEPARTMENT OF ECOLOGY BEST MANAGEMENT PRACTICE (BMP) T5.13

EXISTING CONDITIONS VERIFICATION

PRIOR TO ANY EXCAVATION ACTIVITIES, THE CONTRACTOR SHALL VERIFY THE LOCATIONS AND DEPTHS OF UNDERGROUND UTILITIES TO IDENTIFY ANY POTENTIAL CONFLICTS WITH PROPOSED CONSTRUCTION. CONTACT PROJECT ENGINEER IF ANY CONFLICTS ARE IDENTIFIED. EXISTING UTILITIES SHALL BE POTHOLED AT THE LOCATION WHERE NEW CONNECTIONS ARE PROPOSED TO VERIFY INVERTS, MATERIALS, SIZE, AND GENERAL CONFORMANCE WITH THESE PLANS. CONTACT PROJECT ENGINEER IF CONDITIONS ARE DIFFERENT THAN ANTICIPATED.

PRIOR TO ANY CONSTRUCTION ACTIVITIES, VERIFY EXISTING TOPOGRAPHY AND GENERAL SITE FEATURES ARE CONSISTENT WITH THESE PLANS AND IF THERE ARE ANY POTENTIAL CONFLICTS WITH PROPOSED IMPROVEMENTS. CONTACT PROJECT ENGINEER IF ANY CONFLICTS ARE IDENTIFIED.

COL CONTROL POINT NO 511 FOUND CASED PIN IN IRON PIPE

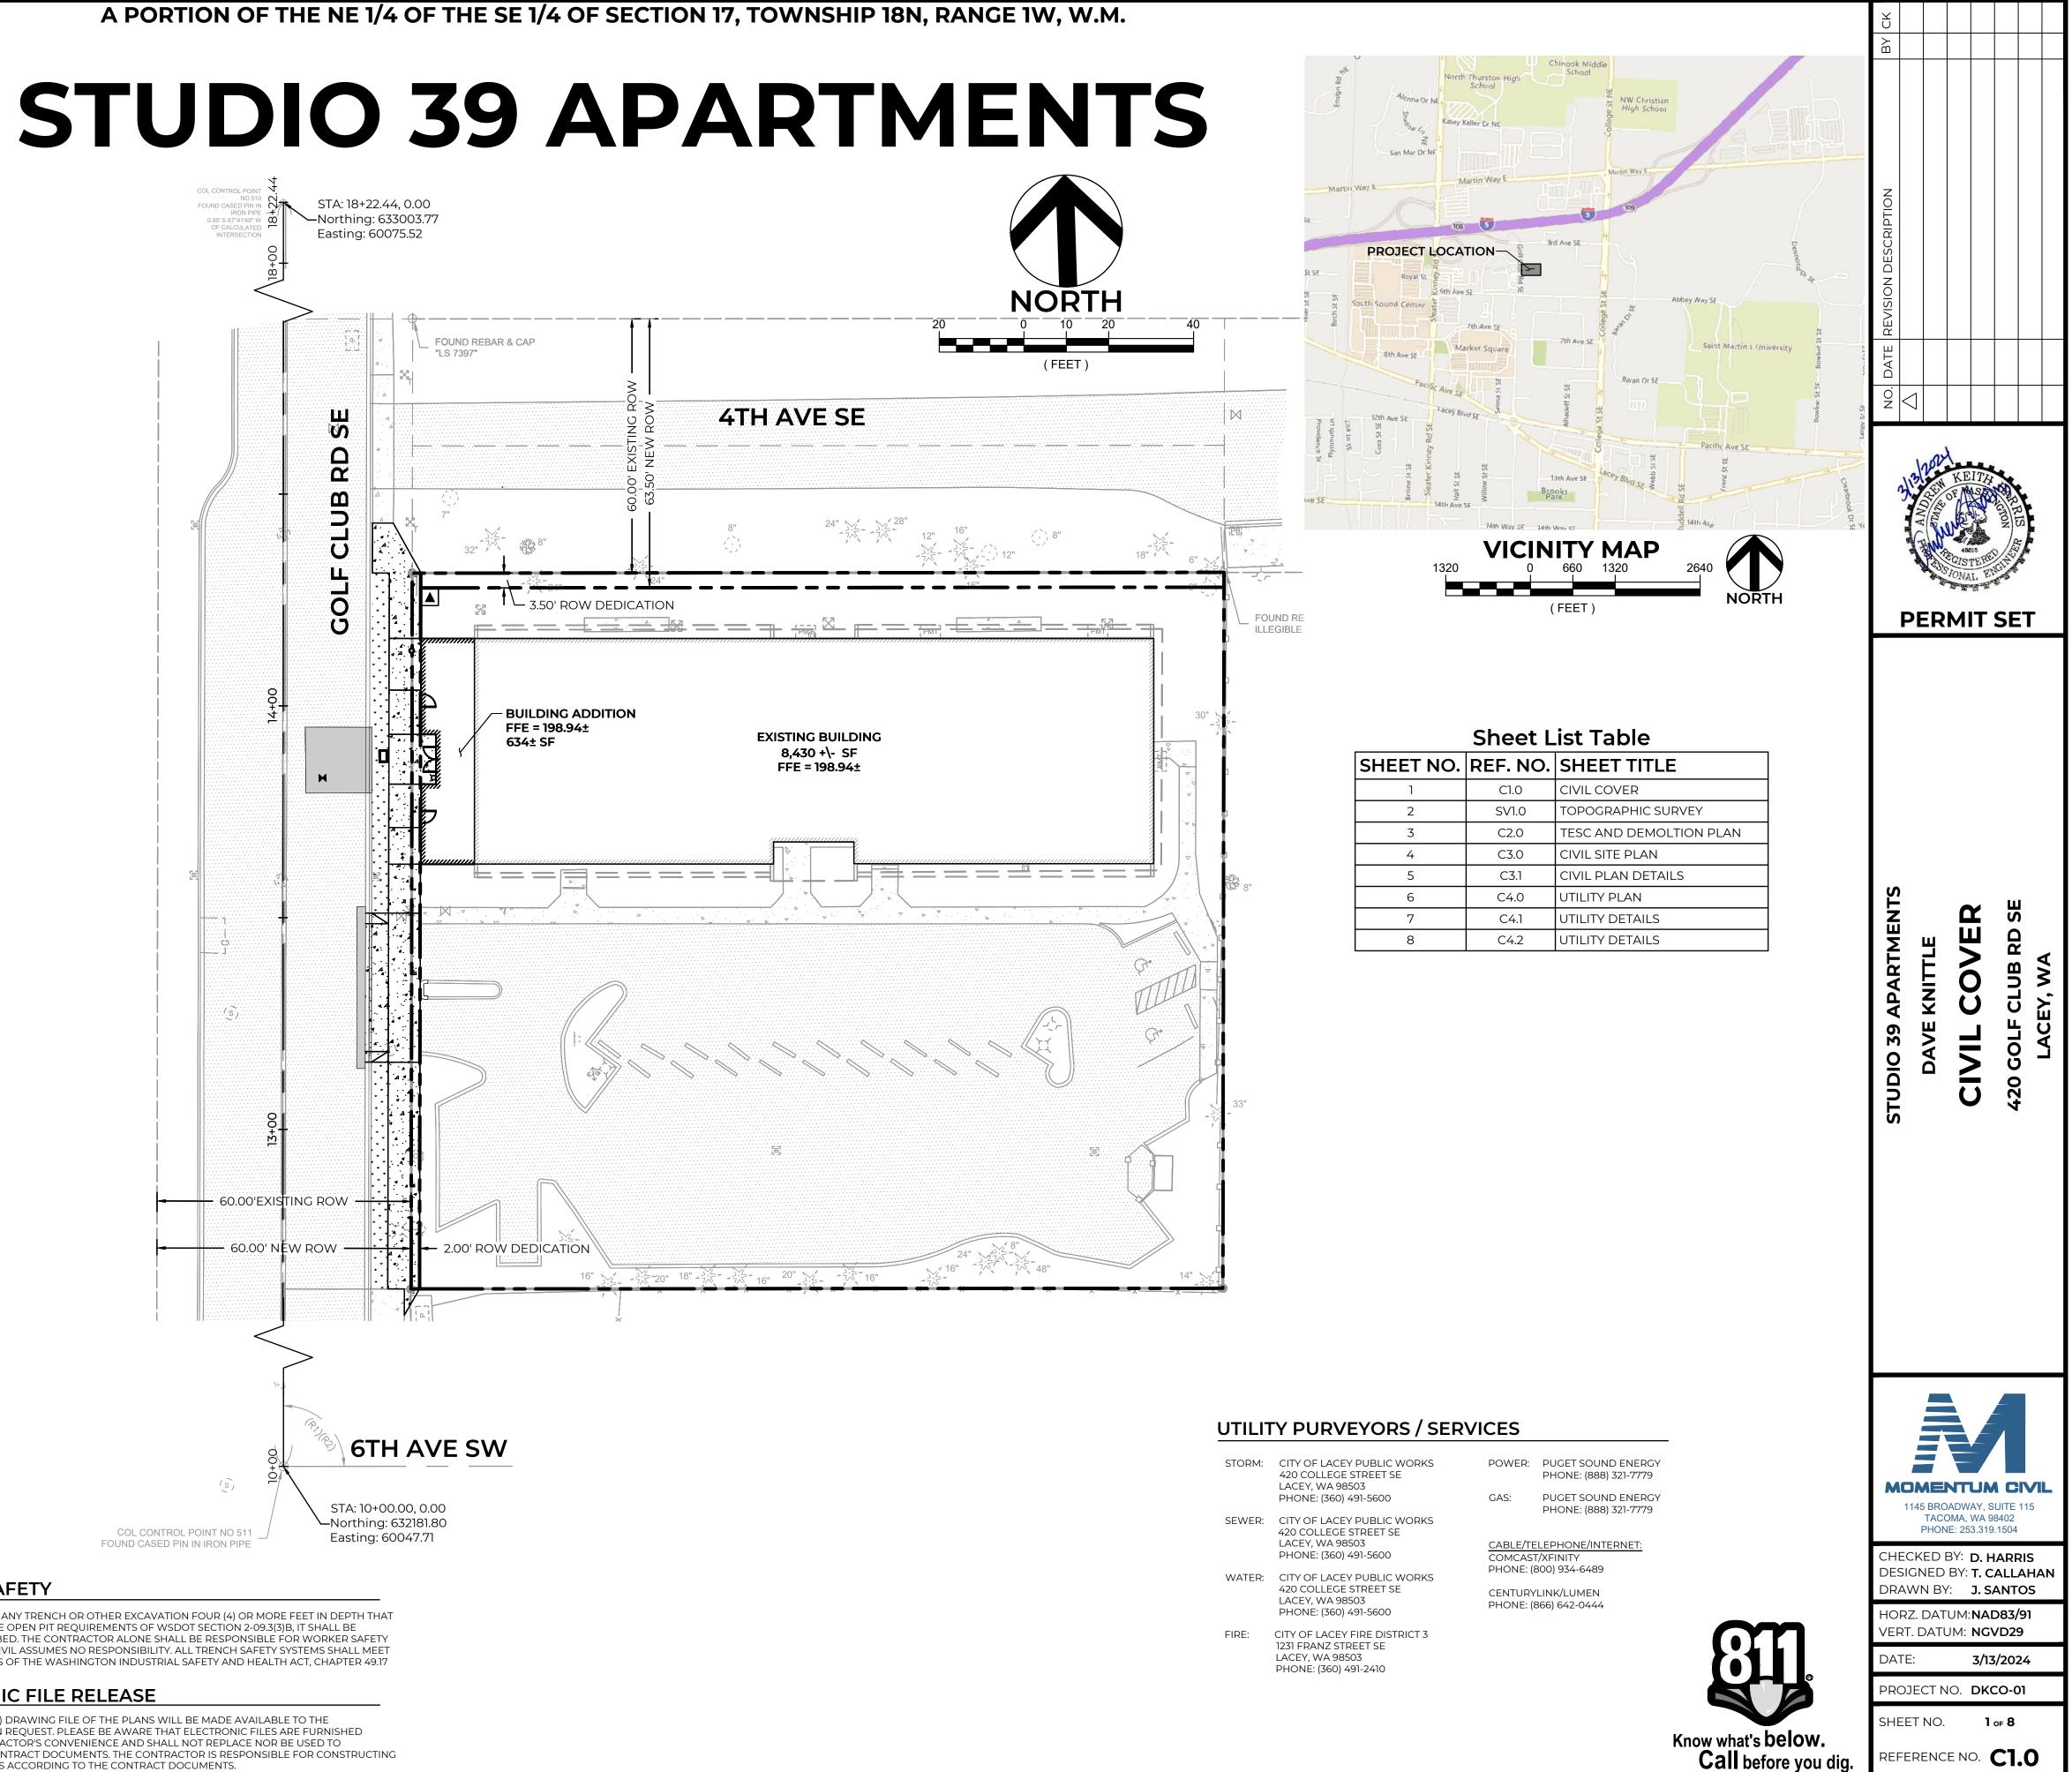
TRENCH SAFETY

IF WORKERS ENTER ANY TRENCH OR OTHER EXCAVATION FOUR (4) OR MORE FEET IN DEPTH THAT DOES NOT MEET THE OPEN PIT REQUIREMENTS OF WSDOT SECTION 2-09.3(3)B, IT SHALL BE SHORED AND CRIBBED. THE CONTRACTOR ALONE SHALL BE RESPONSIBLE FOR WORKER SAFETY AND MOMENTUM CIVIL ASSUMES NO RESPONSIBILITY. ALL TRENCH SAFETY SYSTEMS SHALL MEET THE REQUIREMENTS OF THE WASHINGTON INDUSTRIAL SAFETY AND HEALTH ACT, CHAPTER 49.17 RCW.

ELECTRONIC FILE RELEASE

AN AUTOCAD (DWG) DRAWING FILE OF THE PLANS WILL BE MADE AVAILABLE TO THE CONTRACTOR UPON REQUEST. PLEASE BE AWARE THAT ELECTRONIC FILES ARE FURNISHED SOLELY FOR CONTRACTOR'S CONVENIENCE AND SHALL NOT REPLACE NOR BE USED TO SUBSTITUTE THE CONTRACT DOCUMENTS. THE CONTRACTOR IS RESPONSIBLE FOR CONSTRUCTING THE IMPROVEMENTS ACCORDING TO THE CONTRACT DOCUMENTS.





LEGAL DESCRIPTION PARCEL 2 OF SHORT SUBDIVISION NO. SS-6115 RECORDED DECEMBER 3, 1986 UNDER

RECORDING NO. 8612030015; EXCEPTING THEREFROM THE NORTH 60 FEET AS CONVEYED TO THE CITY OF LACEY BY DEEDS RECORDED MARCH 29, 1989 UNDER RECORDING NOS. 8903290113 AND 8903290114; IN THURSTON COUNTY, WASHINGTON

SURVEYOR'S NOTES

- THE PURPOSE OF THIS SURVEY IS TO DETERMINE THE LOCATION OF THE BOUNDARIES AND PROVIDE TOPOGRAPHIC INFORMATION OF THE PARCEL AS DESCRIBED HEREON.
- 2. THIS SURVEY WAS MADE BY FIELD TRAVERSE USING A GEOMAX ZOOM 90 2" ROBOTIC TOTAL STATION AND TOPCON HIPER SR GPS WITH RESULTING CLOSURES EXCEEDING THE MINIMUM ACCURACY STANDARDS AS SET FORTH BY WAC 332-130.
- 3. THE BOUNDARY CORNERS AND LINES DEPICTED ON THIS MAP REPRESENT DEED LINES ONLY THEY DO NOT PURPORT TO SHOW OWNERSHIP LINES THAT MAY OTHERWISE BE DETERMINED BY A COURT OF LAW.
- 4. THE TITLE REPORT WAS PROVIDED BY CHICAGO TITLE COMPANY OF WASHINGTON, COMMITMENT NUMBER CTTC220056488, DATED JANUARY 30, 2023 AT 8:00 AM.
- 5. FIELD WORK FOR THIS PROJECT WAS PERFORMED IN SEPTEMBER, 2023 AND IS THEREFORE A REFLECTION OF THE CONDITIONS AT THAT TIME. ALL MONUMENTS WERE VISITED OR SET IN SEPTEMBER, 2023.

HORIZONTAL DATUM/BASIS OF BEARINGS

THE HORIZONTAL DATUM FOR THIS SURVEY IS THE CITY OF LACEY COORDINATE SYSTEM, PER TIES TO CITY OF LACEY MONUMENT #511 FOUND AT THE INTERSECTION OF GOLF CLUB RD SE AND 6TH AVE SE AND CITY OF LACEY MONUMENT #510 FOUND AT THE INTERSECTION OF GOLF CLUB RD SE AND 3RD AVE SE. THE BEARING BETWEEN SAID MONUMENT BEING NORTH 01'56'15" EAST AS SHOWN HEREON.

VERTICAL DATUM

THE VERTICAL DATUM FOR THIS SURVEY IS NGVD29, PER TIES TO CITY OF LACEY BENCHMARK #1092 ELEVATION 201.272 FEET FOUND AT THE NORTHEAST CORNER OF THE INTERSECTION OF 6TH AVE SE AND GOLF CLUB PL SE. UNITS OF MEASUREMENT ARE U.S. SURVEY FEET.

REFERENCE SURVEYS

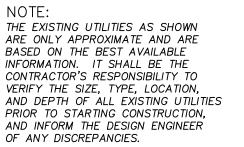
R1) SHORT PLAT, RECORDING NO 8612030015 R2) RECORD OF SURVEY, RECORDING NO 3782212 R3) RECORD OF SURVEY, RECORDING NO 3096676

RECORDS OF THURSTON COUNTY AUDITOR'S OFFICE

EASEMENTS OF RECORD

(PER TITLE REPORT PROVIDED BY CHICAGO TITLE COMPANY OF WASHINGTON, COMMITMENT NUMBER CTTC220056488, DATED JANUARY 30, 2023 AT 8:00 AM.):

- 7. EASEMENT(S) FOR THE PURPOSE(S) SHOWN BELOW AND RIGHTS INCIDENTAL THERETO, ÀS GRANTED IN A DOCUMENT: GRANTED TO: PUGET SOUND POWER & LIGHT COMPANY PURPOSE: ELECTRIC TRANSMISSION AND/OR DISTRIBUTION LINE RECORDING DATE: DECEMBER 12, 1974 RECORDING NO.: 926522 AFFECTS: PORTION OF SAID PREMISES SURVEYOR'S NOTE: THIS EASEMENT AFFECTS THE PROPERTY BUT IS BLANKET
- IN NATURE, NOT SHOWN ON MAP. 8. COVENANTS, CONDITIONS, RESTRICTIONS, RECITALS, RESERVATIONS, EASEMENTS,
- EASEMENT PROVISIONS, ENCROACHMENTS, DEDICATIONS, BUILDING SETBACK LINES, NOTES, STATEMENTS, AND OTHER MATTERS, IF ANY, AS SET FORTH ON SHORT SUBDIVISION NO. SS-6115: RECORDING NO: 8612030015
- SURVEYOR'S NOTE: DOCUMENT CONTAINS PROVISIONS PERTAINING TO THE RIGHT TO MAKE NECESSARY CUTS AND FILLS OVER LOTS IN SHORT PLAT ABUTTING PRIVATE OR PUBLIC STREETS.
- 9. RIGHT TO MAKE NECESSARY SLOPES FOR CUTS OR FILLS UPON PROPERTY HEREIN DESCRIBED AS GRANTED OR RESERVED IN DEED IN FAVOR OF: CITY OF LACEY
- RECORDING DATE: MARCH 29, 1989 RECORDING NO.: 8903290113
- SURVEYOR'S NOTE: THIS ITEM AFFECTS THE PARCEL, PORTION DEEDED TO THE CITY OF LACEY SHOWN ON MAP. DOCUMENT CONTAINS PROVISIONS PERTAINING TO THE RIGHT TO MAKE CUTS AND FILLS.
- 10. RIGHT TO MAKE NECESSARY SLOPES FOR CUTS OR FILLS UPON PROPERTY HEREIN DESCRIBED AS GRANTED OR RESERVED IN DEED IN FAVOR OF: CITY OF LACEY RECORDING DATE: MARCH 29, 1989
- RECORDING NO.: 8903290114 SURVEYOR'S NOTE: THIS ITEM AFFECTS THE PARCEL, PORTION DEEDED TO THE CITY OF LACEY SHOWN ON MAP. DOCUMENT CONTAINS PROVISIONS PERTAINING TO THE RIGHT TO MAKE CUTS AND FILLS.



Call Before You DIg 1-800-424-5555

STORM DRAIN MANHOLE RIM EL=197.46' N 12" CPP IE=192.46' E 12" CPP IE=193.46' S 12" CPP IE=192.46' W 8" CPP IE=193.66

COL CONTROL POINT

SEWER MANHOLE RIM EL=197.27' N 8" PVC IE=187.27' S 8" PVC IE=187.27' W 8" PVC IE=187.27' LADDER (E,W)

STORM DRAIN MANHOLE RIM EL=197.76' S 12" CPP IE=192.51' W 12" CPP IE=192.76' UNABLE TO DETERMINE N PIPE IE, PIPE MATERIAL OR SIZE DUE TO LINE OF SIGHT IN STRUCTURE

> FLOWLINE EL AT CURB FACE INLET=197.29'

CATCH BASIN WITH CURB FACE INLET RIM EL=197.79' E 12" CPP IE=194.29'

FLOWLINE EL AT CURB FACE INLET=197.32'

FLOWLINE EL AT CURB FACE INLET=197.73'

> CATCH BASIN WITH CURB FACE INLET RIM EL=198.18' E 12" CPP IE=194.93'

FLOWLINE EL AT CURB FACE INLET=197.70'

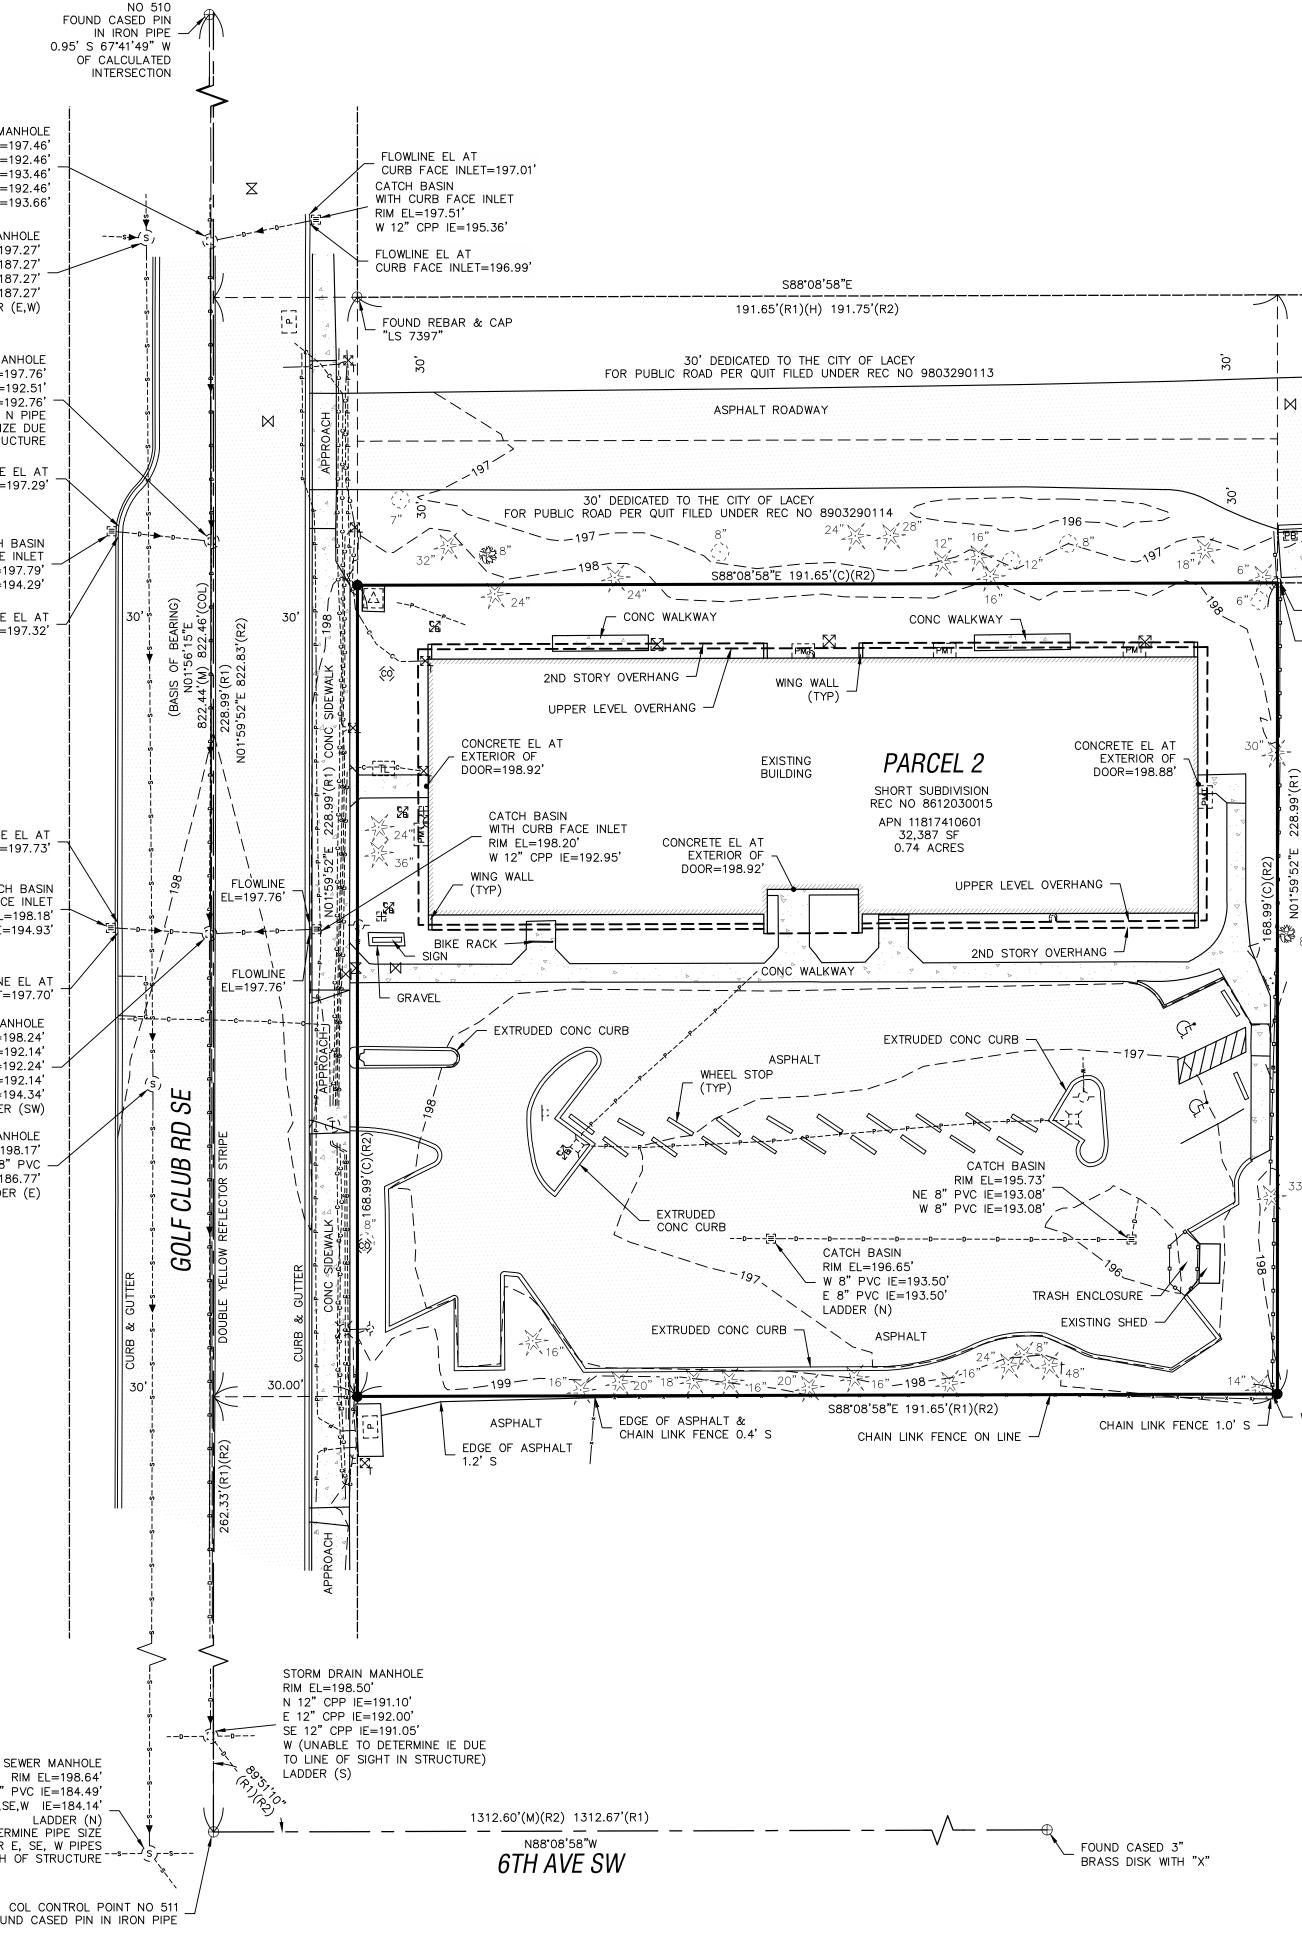
STORM DRAIN MANHOLE RIM EL=198.24' N 12" CPP IE=192.14' E 12" CPP IE=192.24' S 12" CPP IE=192.14' W 12" CPP IE=194.34' LADDER (SW)

SEWER MANHOLE RIM EL=198.17' N,S 8"PVC CENTER CHANNEL IE=186.77' LADDER (E)

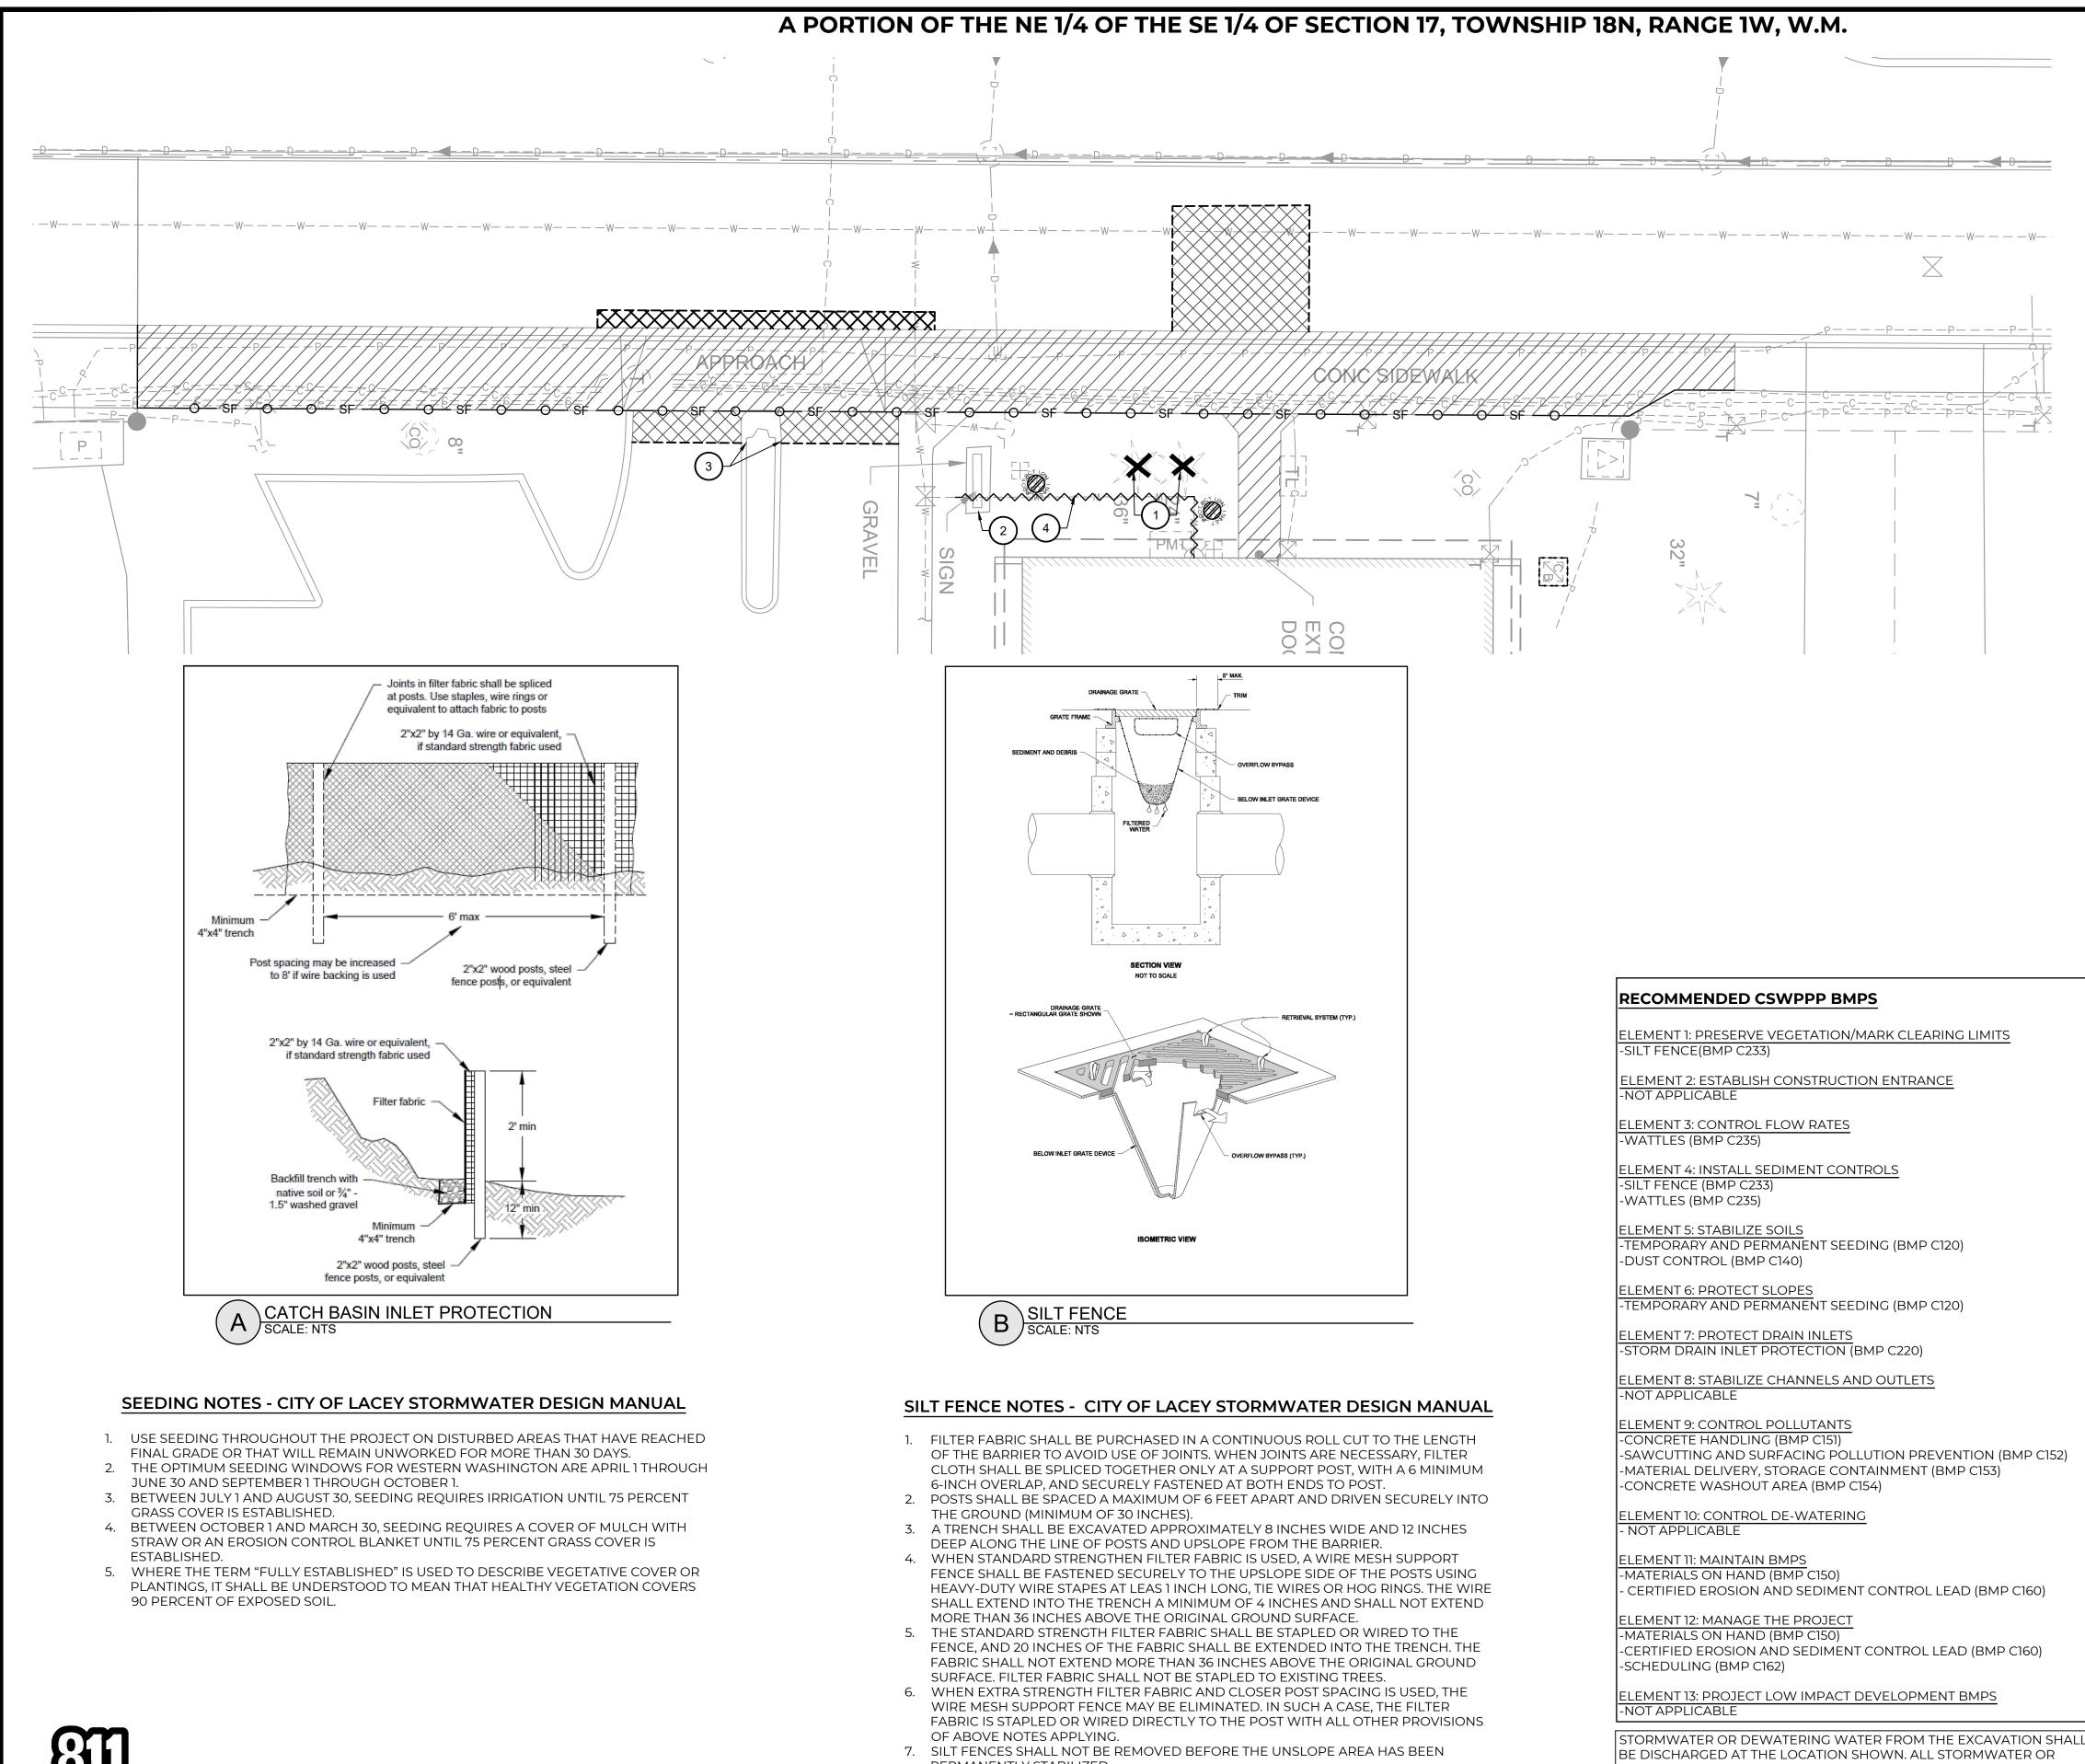
> SEWER MANHOLE RIM EL=198.64' N 8" PVC IE=184.49' E,SE,W IE=184.14' LADDER (N) UNABLE TO DETERMINE PIPE SIZE & MATERIAL FOR E, SE, W PIPES DUE TO DEPTH OF STRUCTURE

> > FOUND CASED PIN IN IRON PIPE

TOPOGRAPHIC SURVEY



		SHT.	of 2	8
LEGEND ⊕ FOUND CASED MONUMENT (AS SHOW ● SET REBAR & CAP EMW LS #44651 ○ FOUND REBAR & CAP (AS SHOWN)	MN)	LOCATED IN NE 1/4 OF THE SE 1/4 OF SECTION 17, TOWNSHIP 18N, RANGE 1W, W.M.	FOR: MOMENTUM CIVIL ENGINEERING CONSULTANTS	CITY OF LACEY, THURSTON COUNTY, WA
CURB & GUTTER CONC SIDEWALK CONC SIDEWALK CONVER TRANSFORMER CONMUNICATION PEDESTAL CONMUNICATION VAULT CONMUNICATION VAULT SIGN CONTROL BOX SEVER MANHOLE CONFER TREE CONFER TRE		HAW WANT	TOPOGRAPHIC SURVEY	10/4/2023
(M) DISTANCE AS MEASURED (C) DISTANCE AS CALCULATED COL CITY OF LACEY WOOD FENCE 			420 GOLF CLUB RD SE LACEY, WA 98503 TAV PAPCEL NO 11017410601	ARCEL NO. 1101
GRAPHIC SCAL 0 10 20 1" = 20	LE 40 FEET	informed land survey	PO Box 5137 Tacoma, WA 98415-0137 Phone: 253-627-2070 admin@i-landsurvey.com www.i-landsurvey.com	LAND SURVEYING • MAPPING • CONSTRUCTION LAYOUT

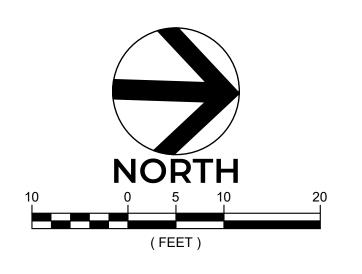


Know what's **below**. Call before you dig.

PERMANENTLY STABILIZED.

8. SILT FENCES SHALL BE INSPECTED IMMEDIATELY AFTER EACH RAINFALL AND AT LEST DAILY DURING PROLONGED RAINFALL. ANY REQUIRED REPAIRS SHALL BE MADE IMMEDIATELY.

DEWATERING WATER DISCHARGED FROM THE SITE MUST MEET THE EFFLUENT LIMITATIONS SET FORTH IN THE DEPARTMENT OF ECOLOGY'S GENERAL STORMWATER PERMIT. IF NECESSARY, CONTRACTOR SHALL PROVIDE A SETTLING TANK/POND OR A FILTRATION UNIT TO MAINTAIN COMPLIANCE WITH THIS STATE-WIDE ORDINANCE.



TESC AND DEMOLITION LEGEND

	PROPERTY LINE
	FULL DEPTH PAVEMENT SAWCUT LIN
	SILT FENCE
<u>\$</u>	TRIANGULAR FOAM SILT DIKE
	CURB REMOVAL
	HMA PAVEMENT REMOVAL
	CONCRETE SIDEWALK REMOVAL
	STORM DRAINAGE INLET PROTECTION
*	TREE & STUMP REMOVAL
- 197	EXISTING MINOR CONTOUR
198	EXISTING MAJOR CONTOUR
197	PROPOSED MINOR CONTOUR
	PROPOSED MAJOR CONTOUR

TESC AND DEMOLITION KEYNOTES

REMOVE EXISTING TREE ENCROACHING ON PROPOSED SIDEWALK AND/OR BUILDING ADDITION.

- (2) DEMOLISH EXISTING SIGN AND ASSOCIATED FOUNDATION.
- 3 REMOVE CURBING IN ISLAND TO ALLOW FOR NEW SIDEWALK CONSTRUCTIONS. (SEE SITE PLAN)
- REMOVE EXISTING 6" PIPE DOWNSTREAM OF NEW FIRE HYDRANT LOCATION SEE SHEETC4.0 FOR NEW FIRE HYDRANT LOCATION.

GENERAL DEMOLITION NOTES

- . CONTRACTOR SHALL COORDINATE WITH FRANCHISE UTILITY PURVEYORS REGARDING CONFLICTS, REMOVAL, OR RELOCATION OF EXISTING FACILITIES.
- 2. CONTRACTOR SHALL PROTECT ALL UTILITIES / STRUCTURES TO REMAIN, AND ADJUST RIMS TO FINISHED GRADE 3. CONTRACTOR TO POTHOLE AND VERIFY PROPOSED CROSSINGS
- AND CONNECTIONS WITH EXISTING UTILITIES. VERIFY PIPE SIZE ANI INVERTS. NOTIFY ENGINEER OF ANY CONFLICT WITH DESIGN. 4. PROTECT AND PRESERVE ALL ADJACENT IMPROVEMENTS.
- COORDINATE WITH OWNER/ENGINEER IF CONFLICTS EXIST OR CONDITIONS ARE DIFFERENT THAN SHOWN. 5. PROTECT AND PRESERVE ALL SITE IMPROVEMENTS NOT
- DESIGNATED FOR DEMOLITION.

RECOMMENDED CONSTRUCTION SEQUENCE

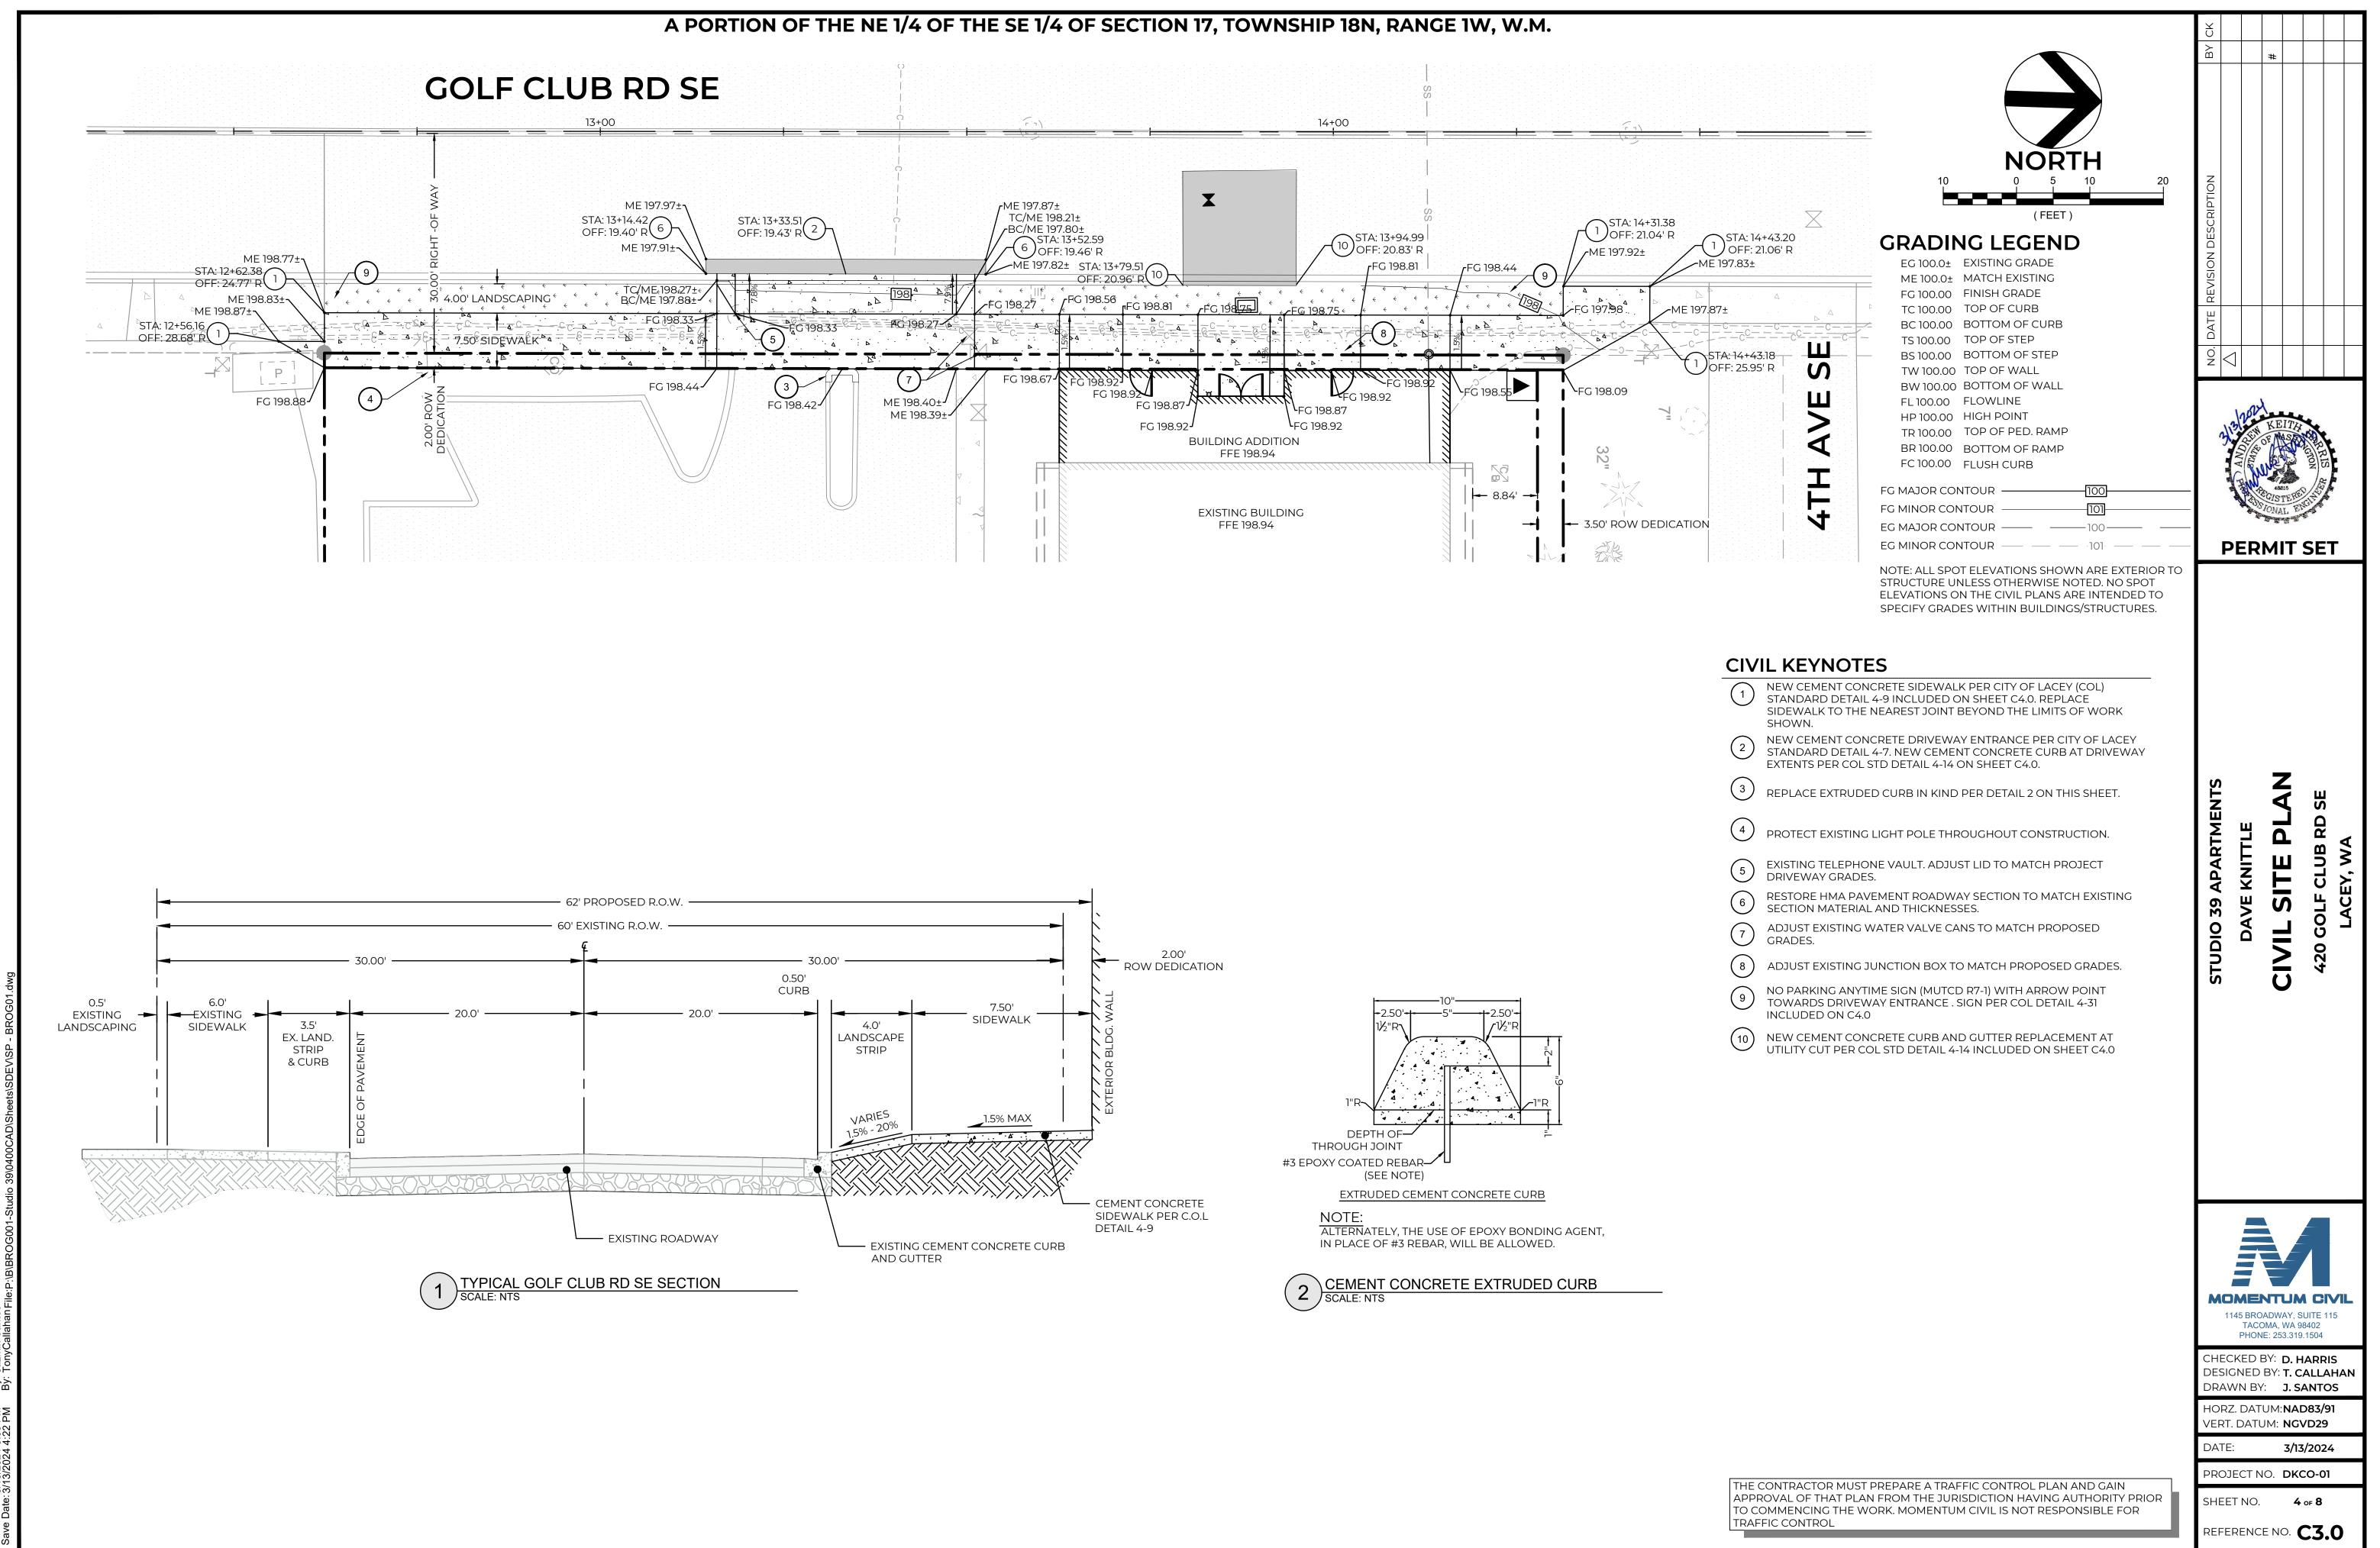
- MARK CLEARING AND DEMOLITIONS LIMITS. 2. INSTALL INLET PROTECTION AROUND EXISTING STORM DRAIN
- INLETS. 3. INSTALL CONSTRUCTION ENTRANCES, SILT FENCES, SEDIMENT
- TRAPS, AND CONSTRUCTION FENCES ON THE SITE. 4. INSTALL PERMANENT STORMWATER CONVEYANCE SYSTEM. INSTALL INLET PROTECTION IN STRUCTURES AS THEY ARE INSTALLED.
- . BEGIN DEMOLITION.
- 6. GRADE SITE. 7. INSTALL UTILITIES, IRRIGATION SLEEVES, CURBS AND GUTTER.
- 8. CONSTRUCT BUILDING. 9. PREPARE SITE FOR PAVING.
- 10. PAVE SITE
- 11. COMPLETE PAVING AND PERMANENTLY STABILIZE THE SITE. 12. REMOVE ALL TEMPORARY EROSION AND SEDIMENT CONTROL DEVICES AFTER SITE IS PERMANENTLY STABILIZED.

PROTECT ALL EXISTING IMPROVEMENTS NOT DESIGNATED FOR REMOVAL THROUGHOUT CONSTRUCTION. PARTICULAR ITEMS ARE CALLED OUT FOR PROTECTION WITHIN THIS PLAN SET FOR EMPHASIS ONLY AND THE LIST IS NOT ALL-INCLUSIVE. CONTACT ENGINEER OR OWNER IF THERE IS ANY UNCERTAINTY PERTAINING TO THE LIMITS OF DEMOLITION OR EXISTING ITEMS TO REMAIN

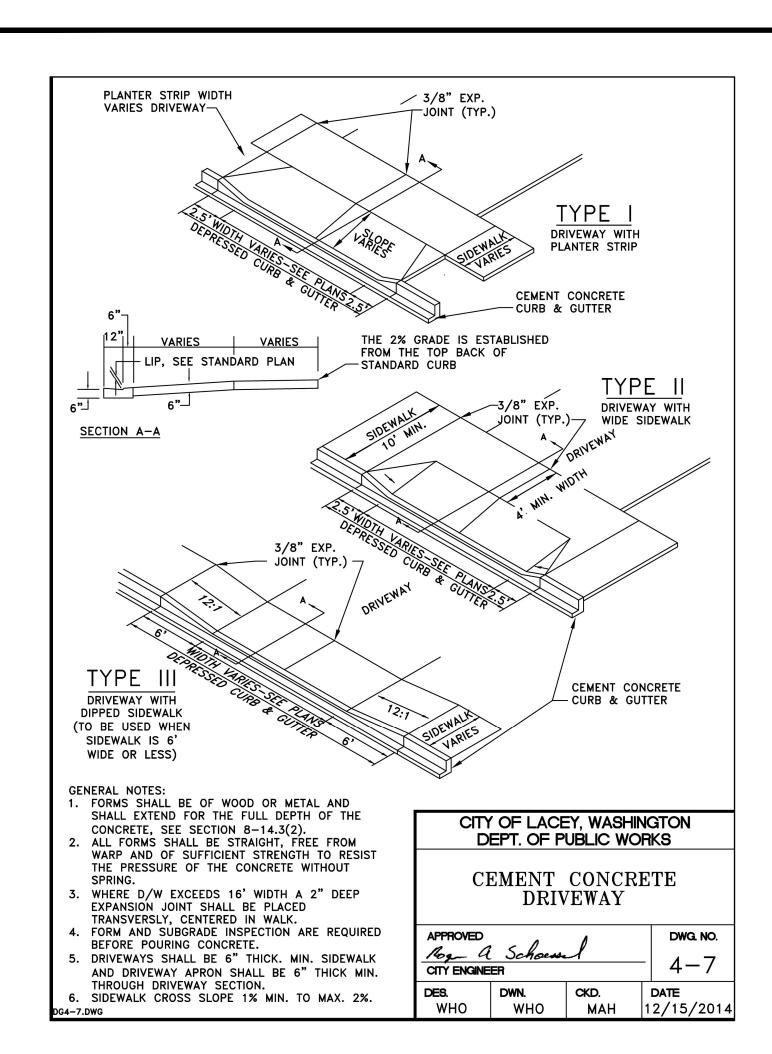
THIS TEMPORARY EROSION AND SEDIMENT CONTROL (T.E.S.C.) PLAN REPRESENTS A MINIMAL LEVEL OF BMPS ANTICIPATED FOR THIS SITE. THE CONTRACTOR SHALL MODIFY AND AUGMENT THIS T.E.S.C. PLAN AS NECESSARY TO FULFILL ALL THE REQUIREMENTS OF THE SITE SPECIFIC CONSTRUCTION STORM WATER PERMIT.

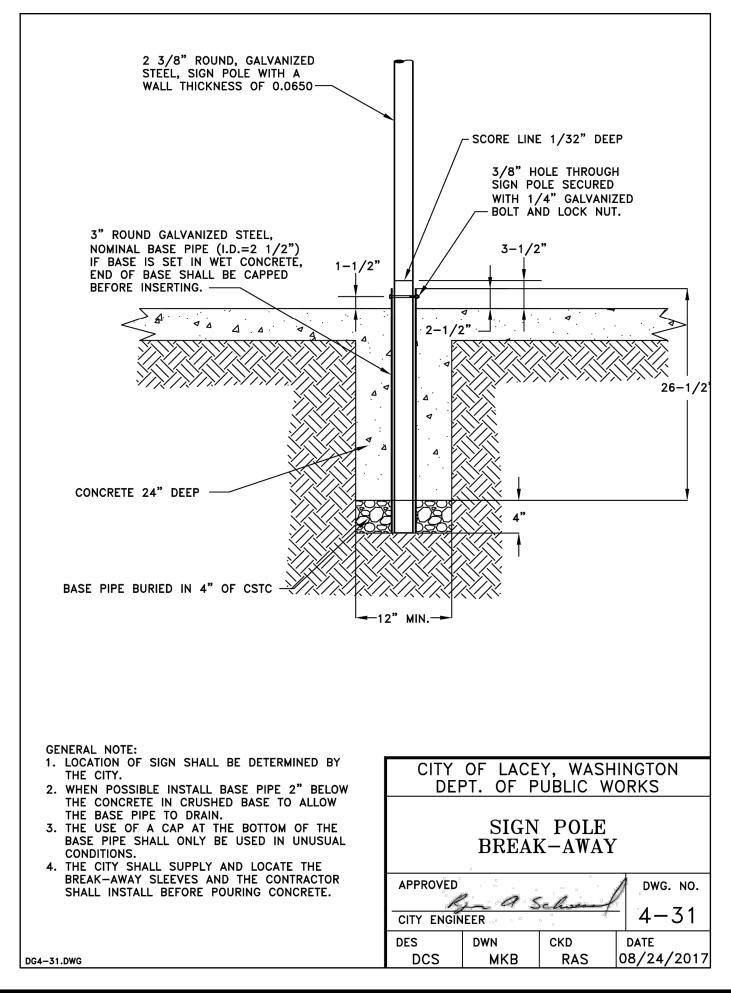
CAUTION LOCATION OF EXISTING UTILITIES SHOWN IS APPROXIMATE AND MAY NOT BE ACCURATE OR ALL INCLUSIVE. IT IS THE CONTRACTOR'S RESPONSIBILITY TO FIELD VERIFY LOCATION OF UTILITIES PRIOR TO PROCEEDING WITH CONSTRUCTION. CONTRACTOR MUST CALL 1-800-424-5555 NOT LESS THAN TWO FULL BUSINESS DAYS BEFORE BEGINNING EXCAVATION WHERE ANY UNDERGROUND UTILITIES MAY EXIST. EXISTING UTILITIES TO BE LOCATED, PROTECTED, AND REPAIRED IN ACCORDANCE WITH RCW 19.122.

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STUDIO 39 APARTMENTS	KNITTLE		
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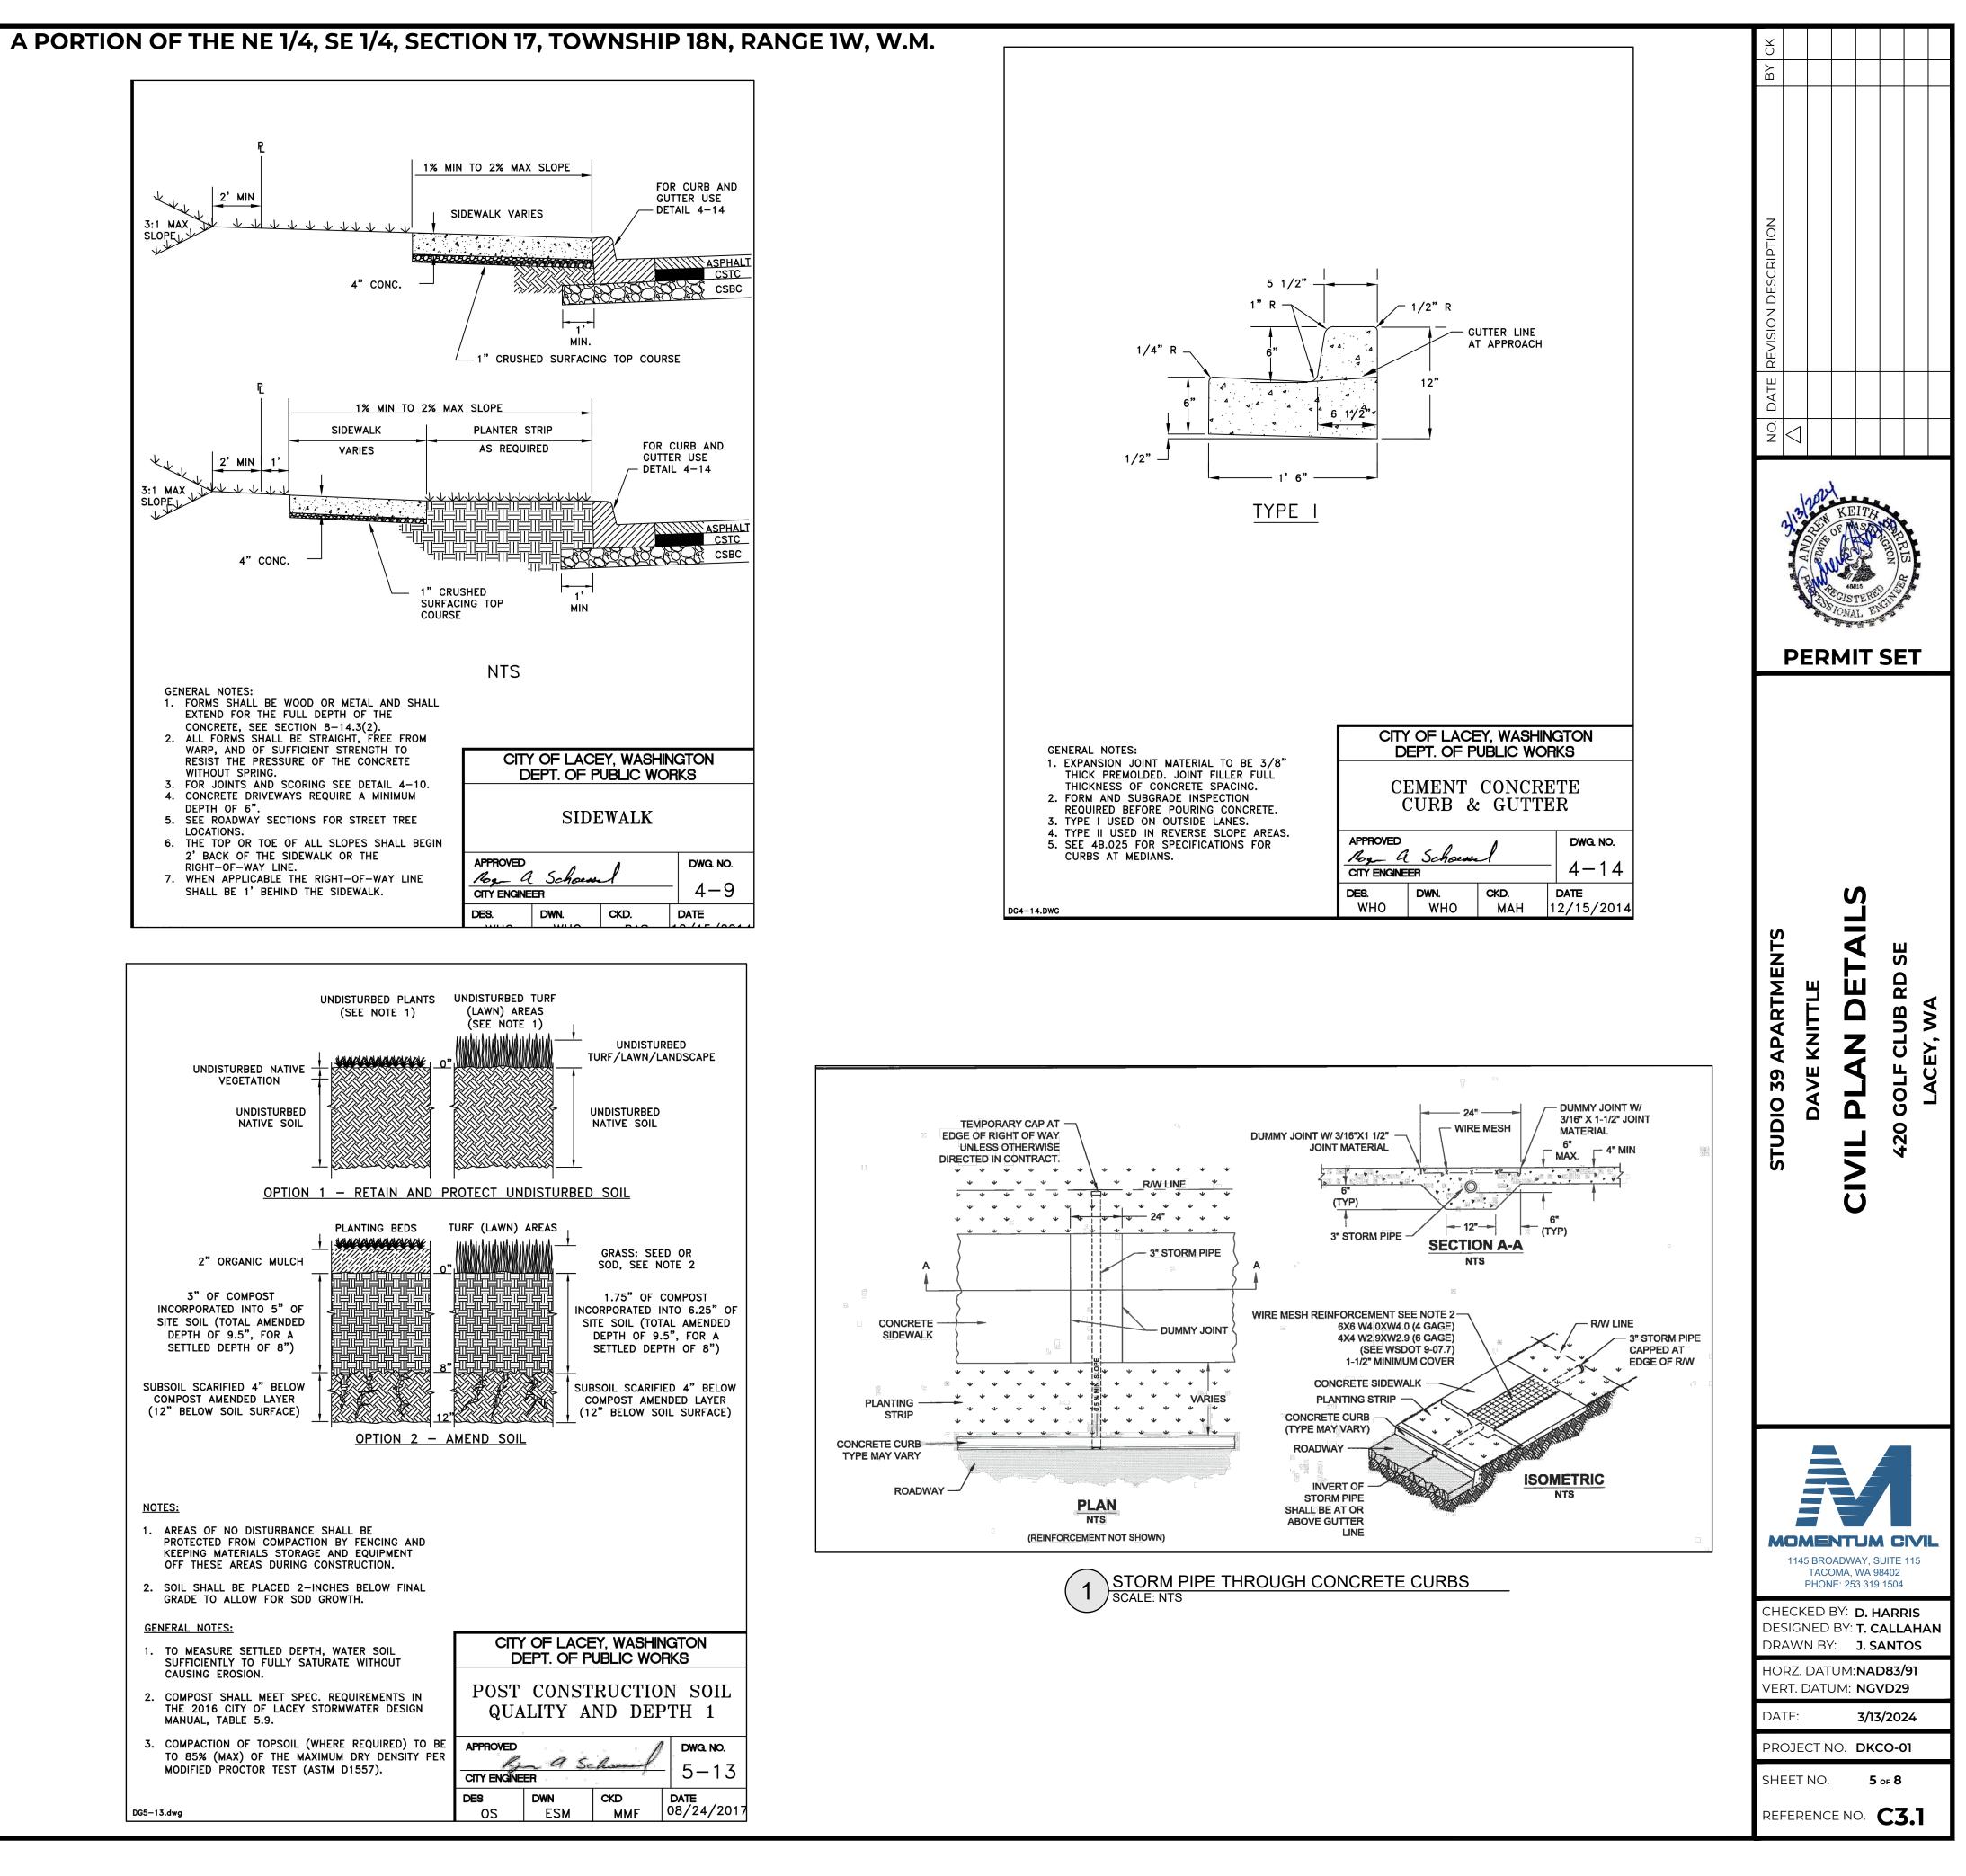


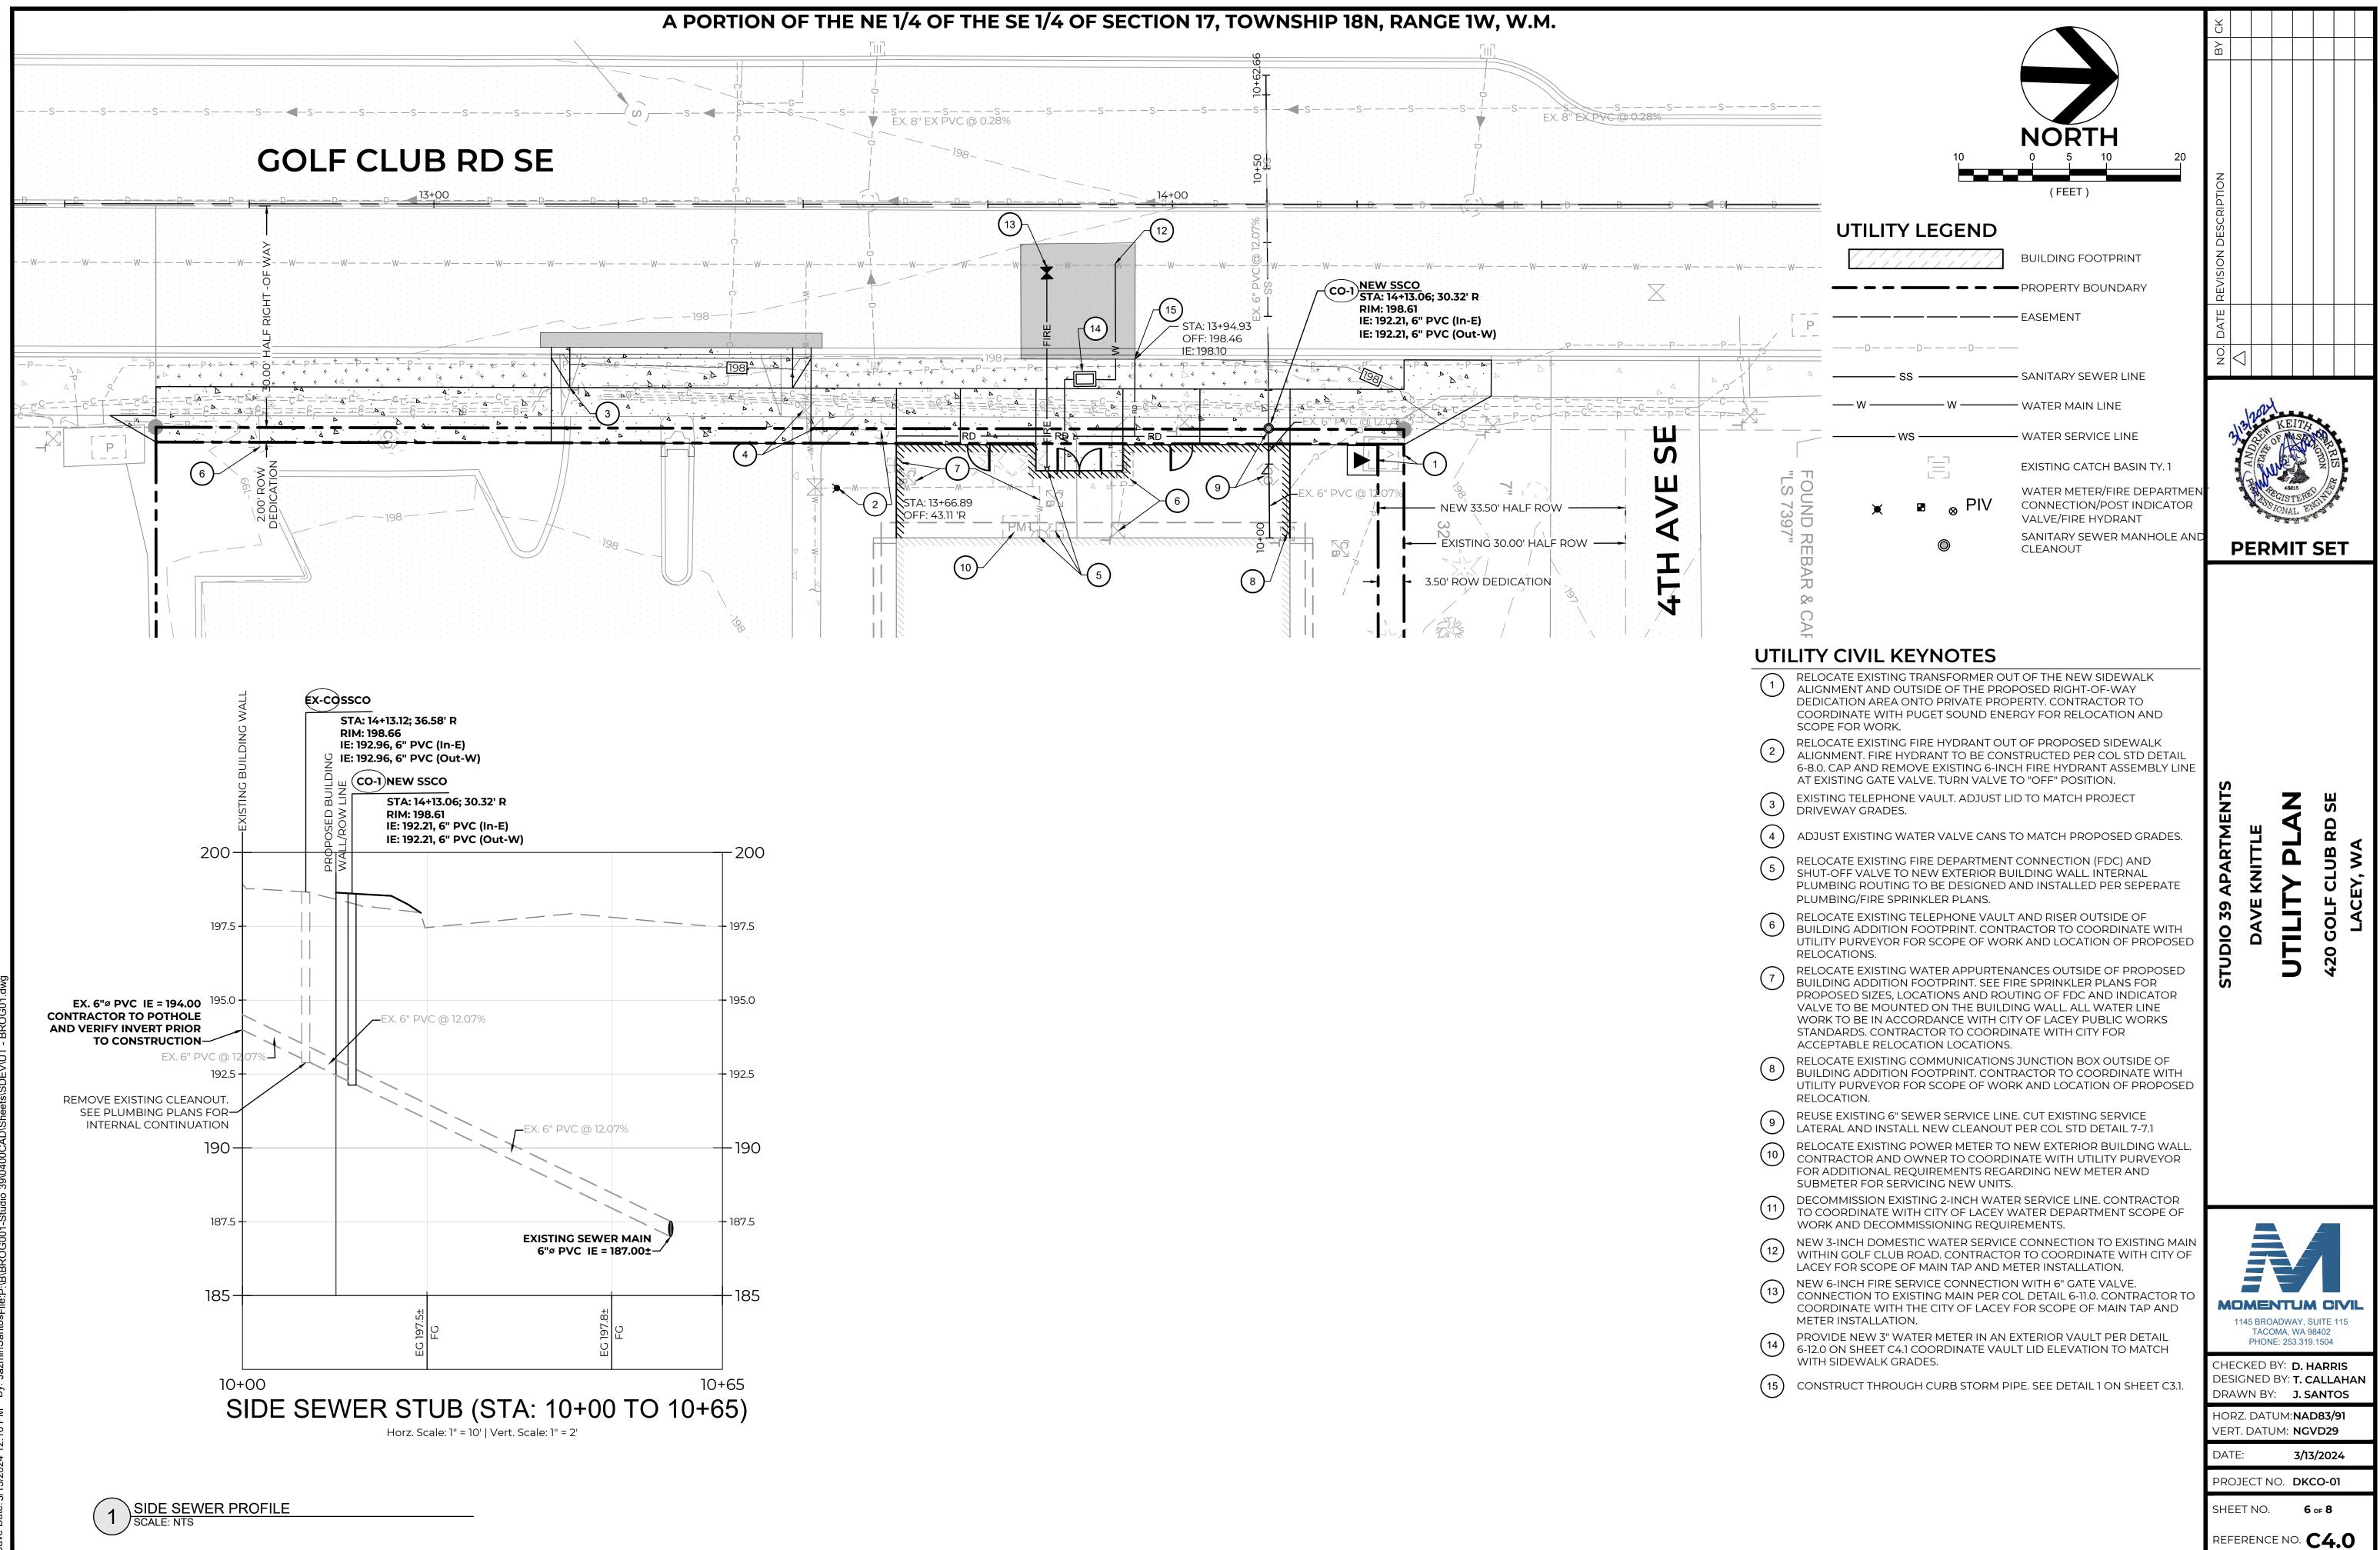
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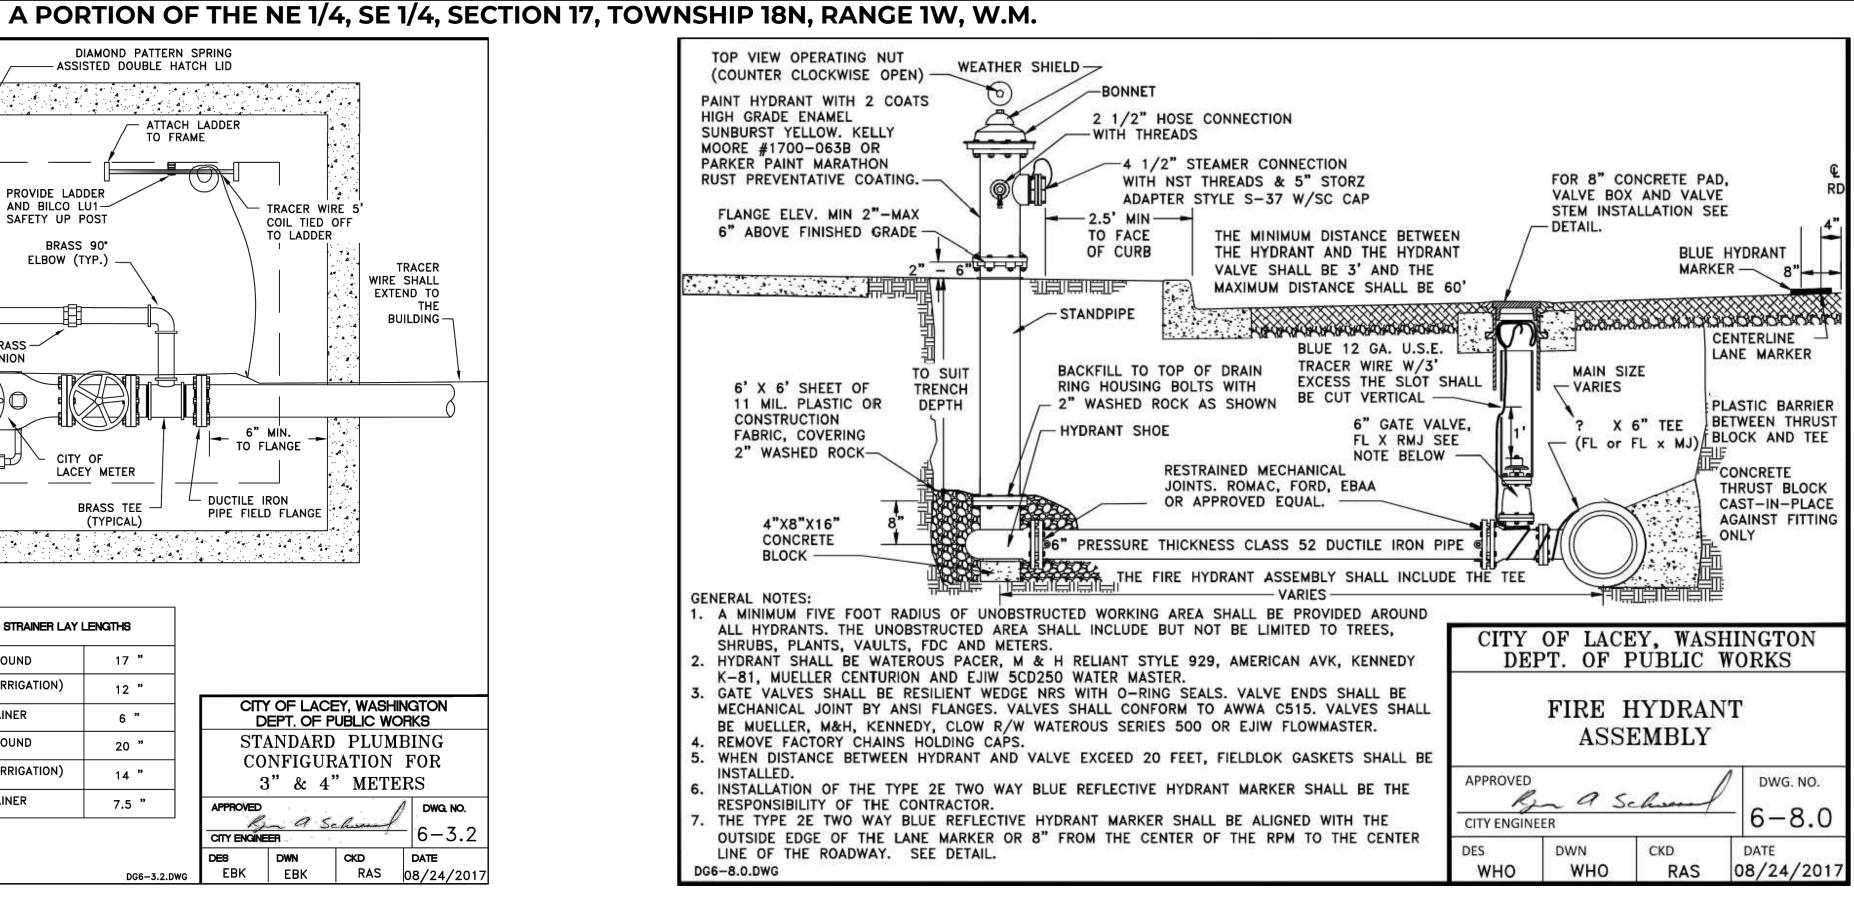


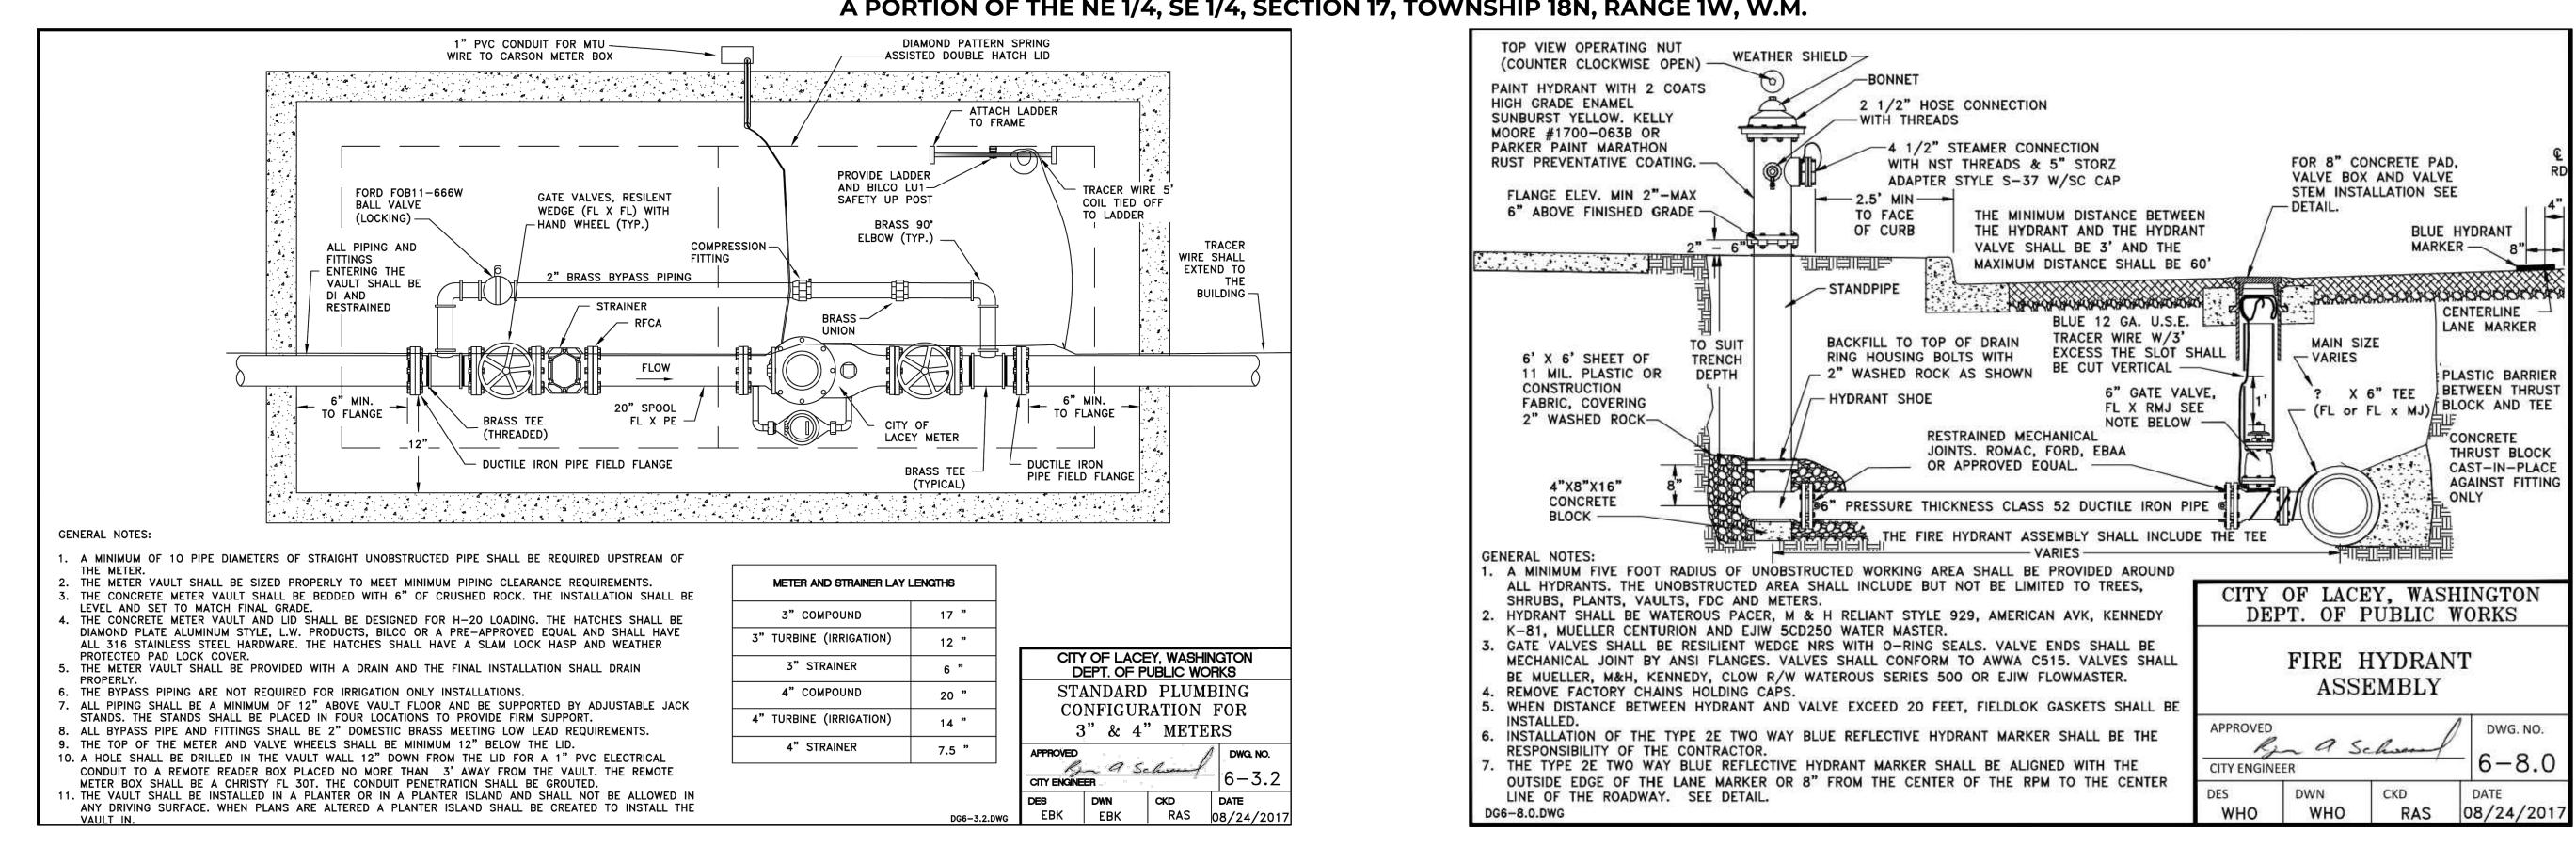
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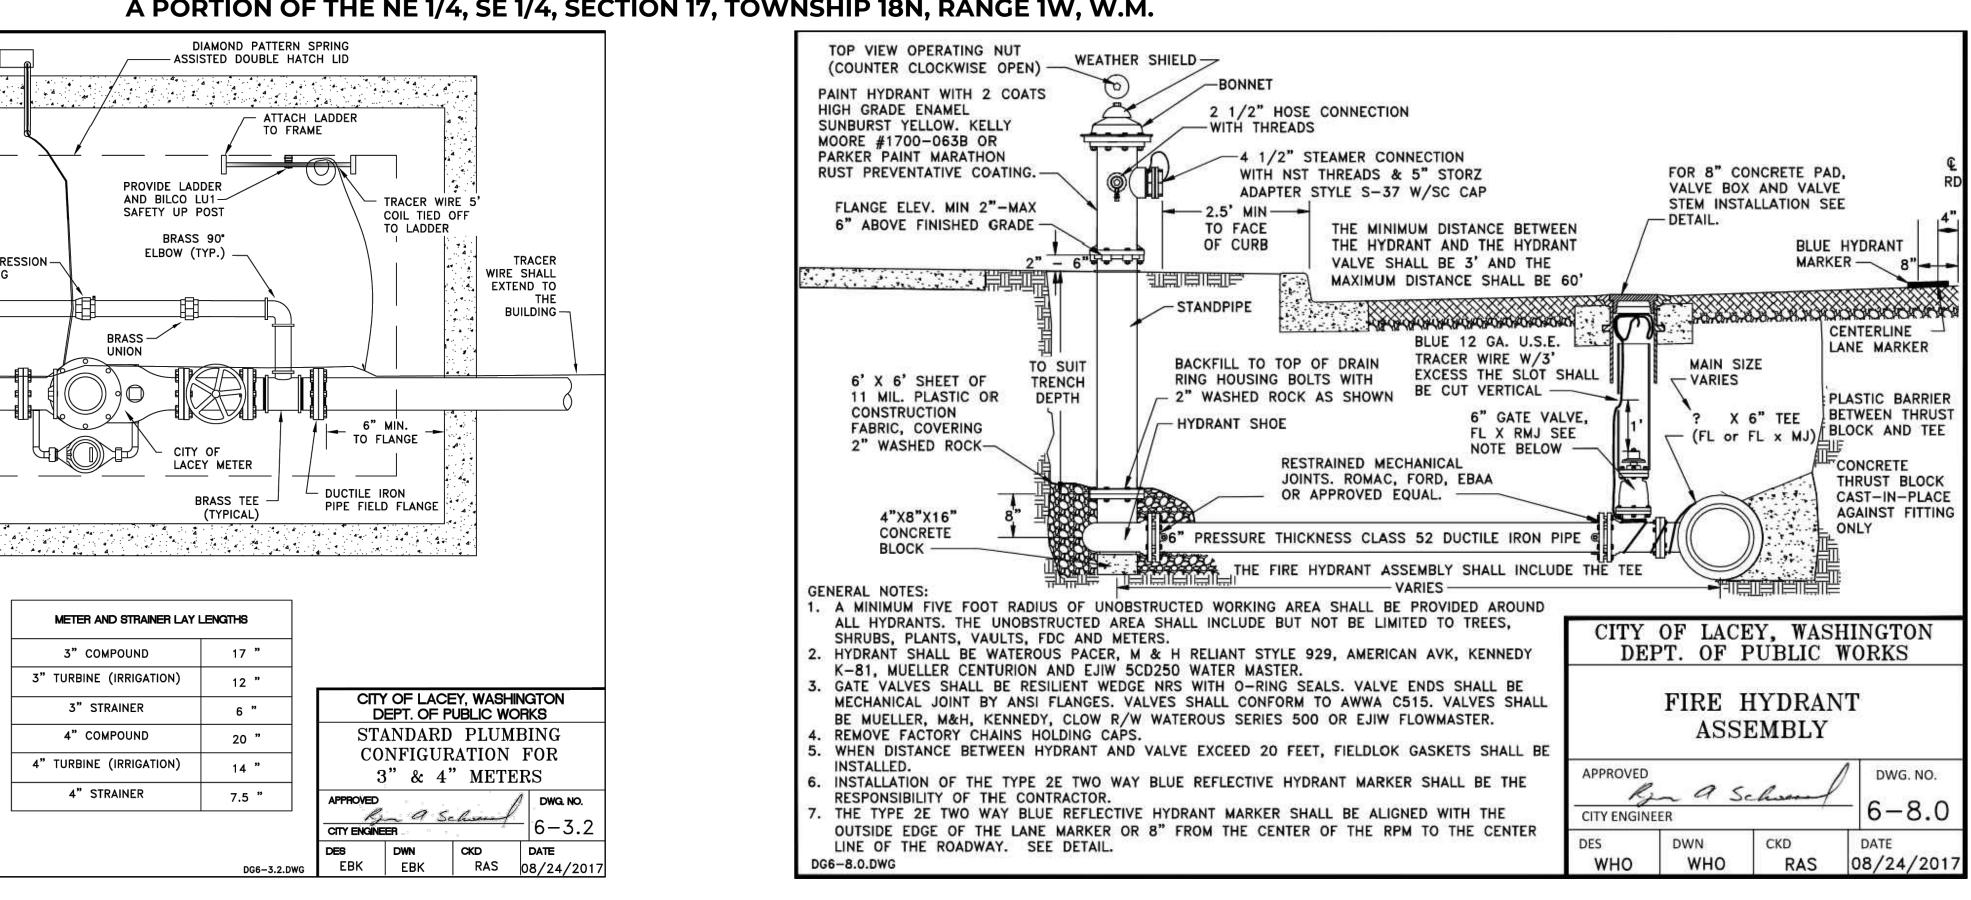


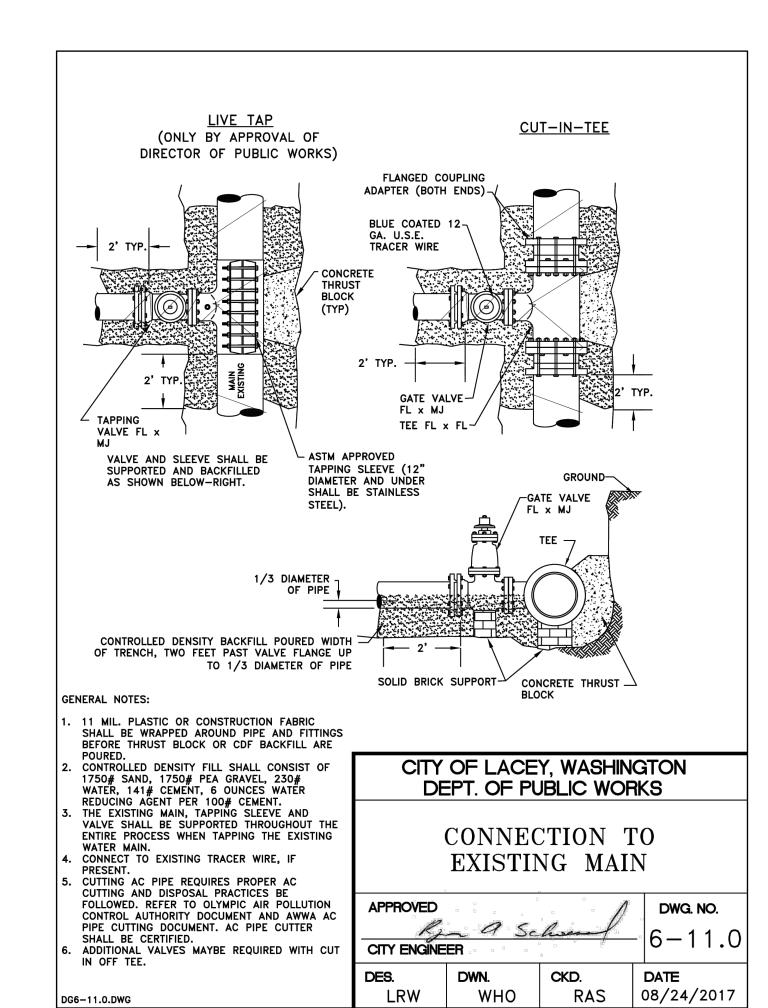


ate: 3/13/2024 5:10 PM By: Jazmin Santos Date: 3/13/2024 12:16 PM By: JazminSantosFile:P:\B\BROG001-Studio 39\0400CAD\Sheets\SDE\\UT - BROG

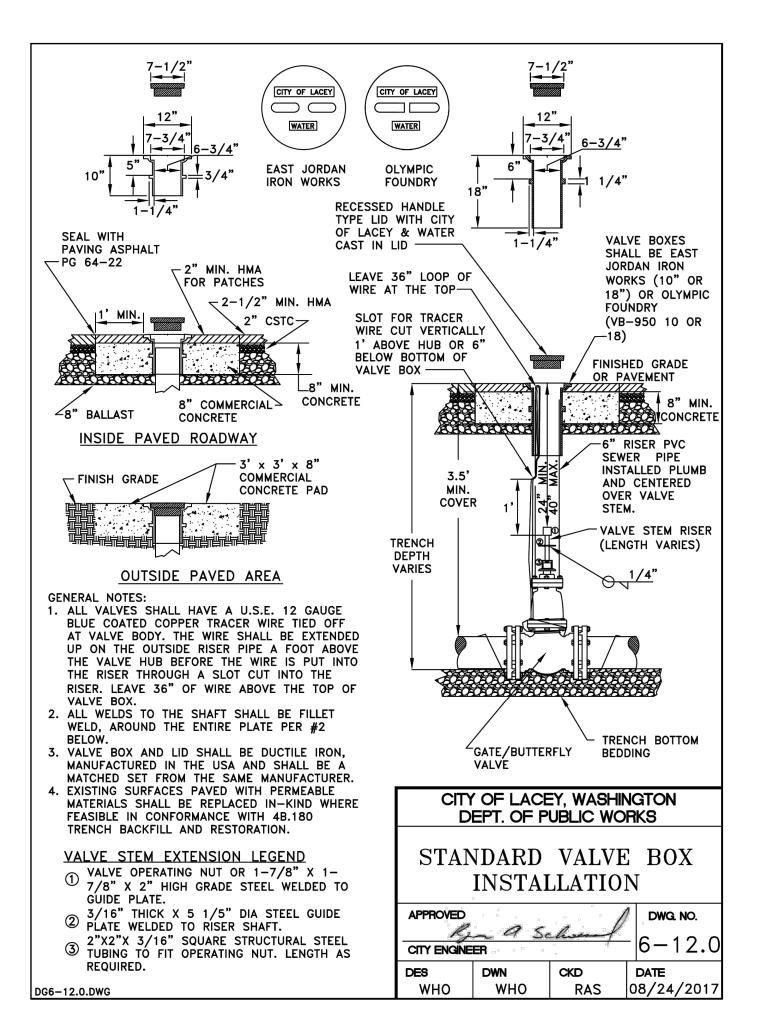


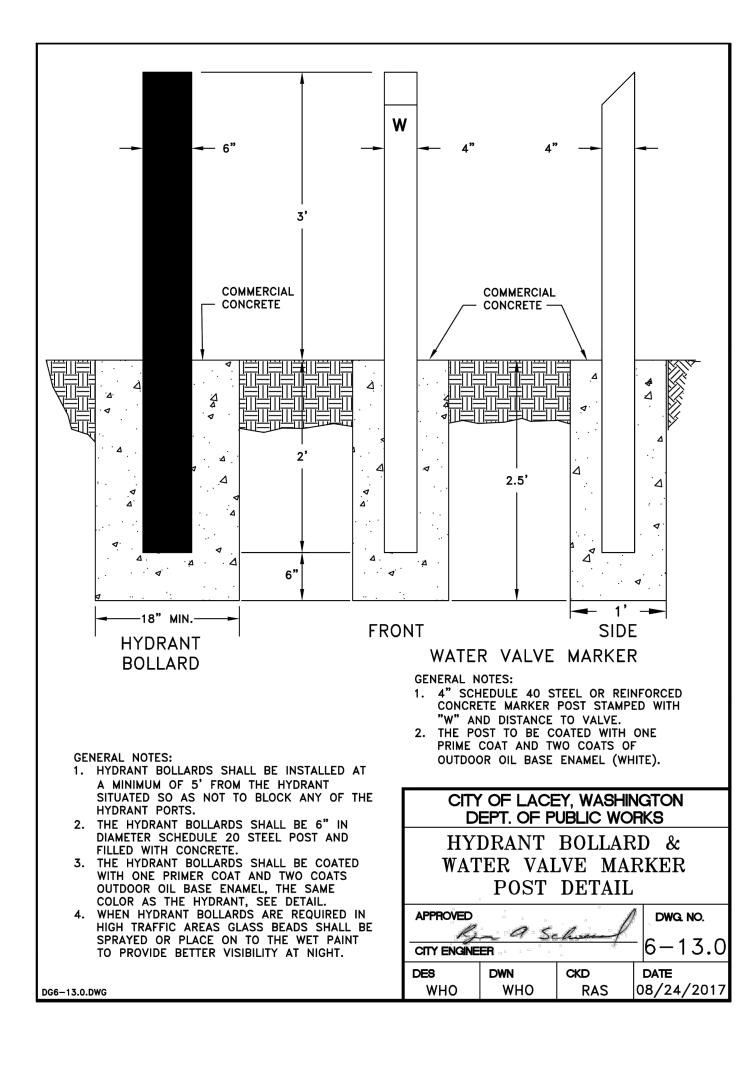




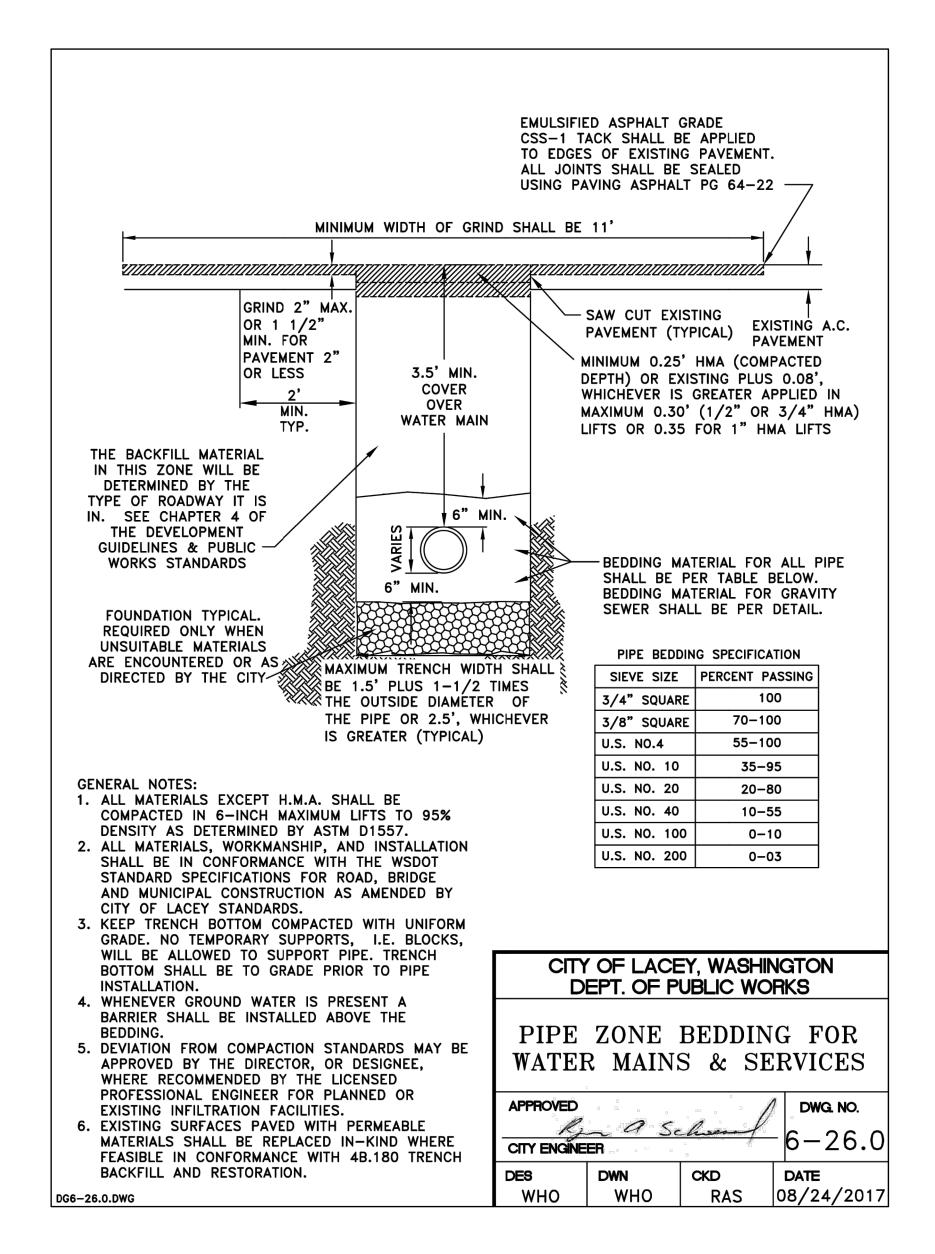


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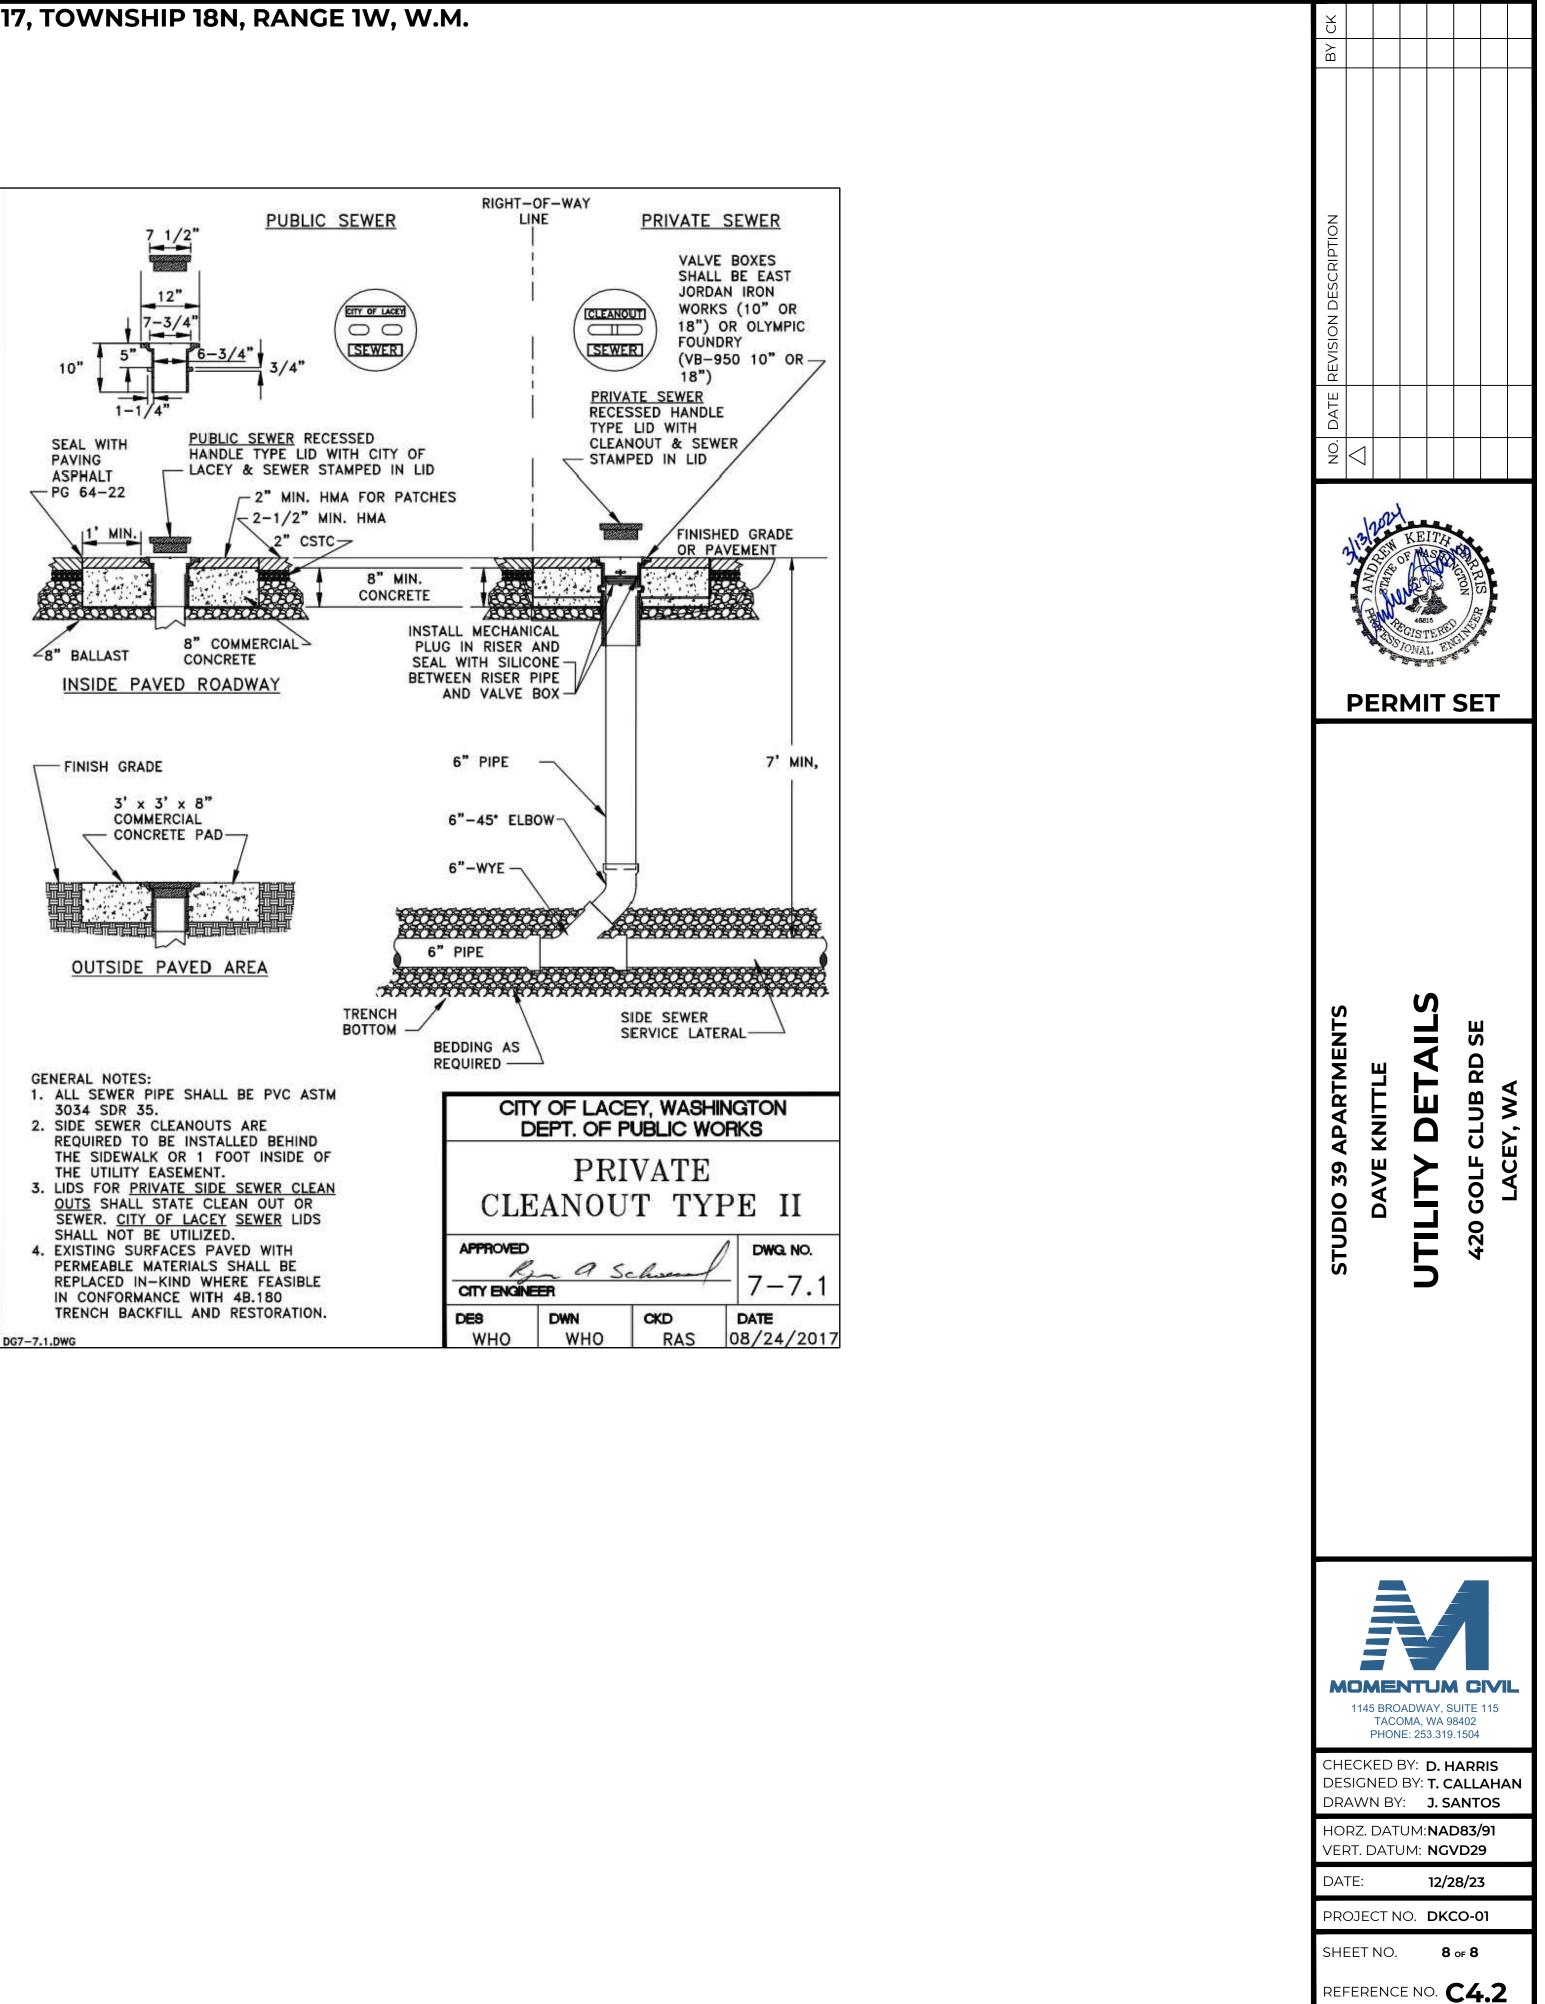


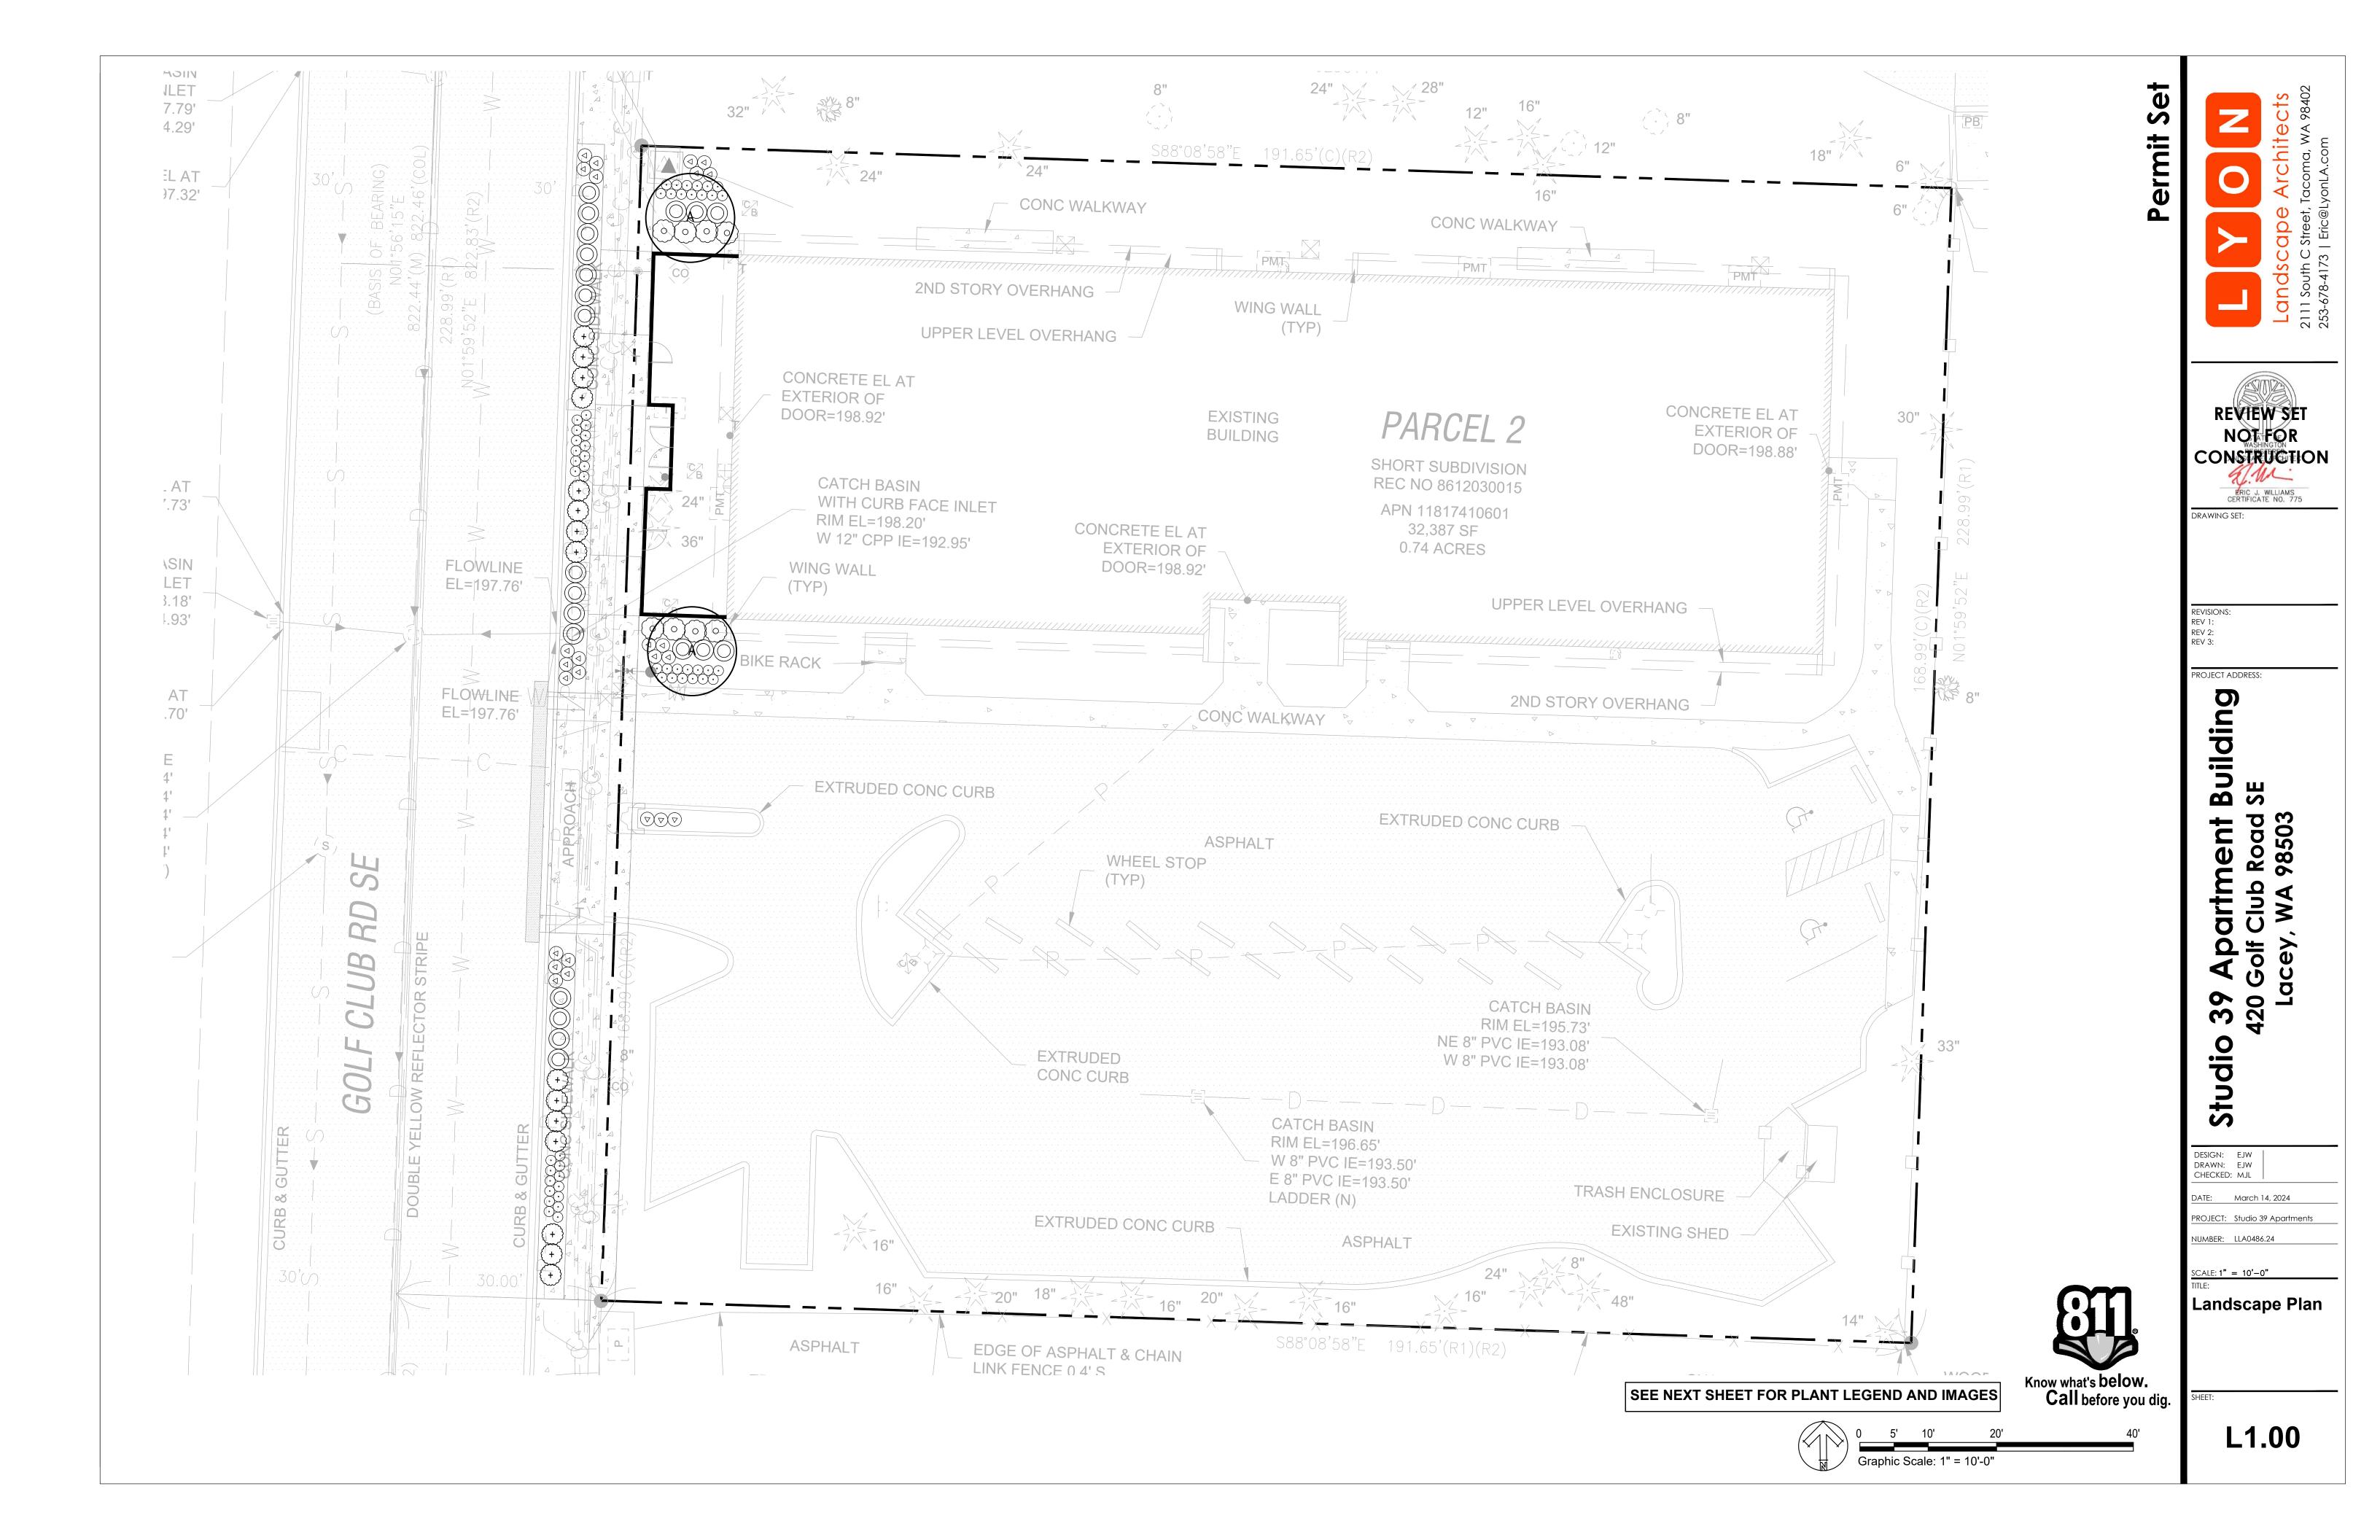


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A PORTION OF THE NE 1/4 OF THE SE 1/4 OF SECTION 17, TOWNSHIP 18N, RANGE 1W, W.M.





TREES PLANTED WITHIN 6 FEET OF CURBS OR SIDEWALK MUST HAVE A ROOT BARRIER

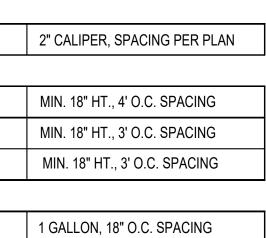
PLANT LEGEND

\frown	QTY	BOTANICAL NAME	COMMON NAME			
$\langle \rangle$	TR	TREES				
A —	2	PRUNUS 'AMANOGAWA'	AMANOGAWA FLOWERING CHERRY			
	SHR	SHRUBS				
(+)	15	CALAMAGROSTIS ACUTIFLORA 'KARL FOERSTER'	KARL FOERSTER REED GRASS			
~~~~~~~~~~~~~~~~~~~~~~~~~~~~~~~~~~~~~~	8	WEIGELA FLORIDA 'ALEXANDRA'	WINE AND ROSES WEIGALA			
<u> </u>	21	PENNISETUM SETACEUM 'RUBRUM'	KELSEY DOGWOOD			
	GRO	GROUNDCOVERS				
•	52	ARCTOSTAPHYLOS UVA-URSI	VANCOUVER JADE KINNIKINNICK			
(d) ————————————————————————————————————	25	GAULTHERIA SHALLON	DWARF PURPLE FOUNTAIN GRASS			

#### LANDSCAPE NOTES AND SOIL QUALITY

- 1. LANDSCAPE AREAS SHOULD BE DEEP-TILLED TO A DEPTH OF AT LEAST TWELVE (12) INCHES TO FACILITATE DEEP WATER PENETRATION AND SOIL OXYGENATION. PROVIDE SOIL AMENDMENTS ENCOURAGED TO IMPROVE WATER DRAINAGE, MOISTURE PENETRATION OR WATER-HOLDING CAPACITY. FOR ALL NEWLY LANDSCAPED AREAS ORGANIC MATTER SHOULD BE INCORPORATED TO A DEPTH OF FOUR (4) TO SIX (6) INCHES TO FACILITATE DEEP WATER PENETRATION AND SOIL OXYGENATION.
- 2. CONTRACTOR SHALL PROVIDE 9" DEPTH IMPORTED TOPSOIL AT ALL LANDSCAPE PLANTING AREAS.
- 3. IMPORTED TOPSOIL SHALL BE 3-WAY MIX.
- 4. CONTRACTOR SHALL PROVIDE 2" DEPTH FINE COMPOST MULCH THROUGHOUT LANDSCAPE PLANTING AREAS.
- 5. CONTRACTOR SHALL GUARANTEE ALL PLANT MATERIALS FOR A PERIOD OF (1) ONE YEAR AFTER APPROVAL BY OWNER OR OWNER'S REPRESENTATIVE.
- 6. TREES PLANTED FIVE FEET OR LESS FROM PAVED SURFACES SHALL BE PLANTED WITH ROOT CONTROL BARRIER.

	PLANT	IMAGES



SIZE & SPACING

1 GALLON, 24" O.C. SPACING

AMANOGAWA FLOWERING CHERRY



KARL FOERSTER REED GRASS





DWARF KELSEY DOGWOOD

WINE AND ROSES WEIGALA

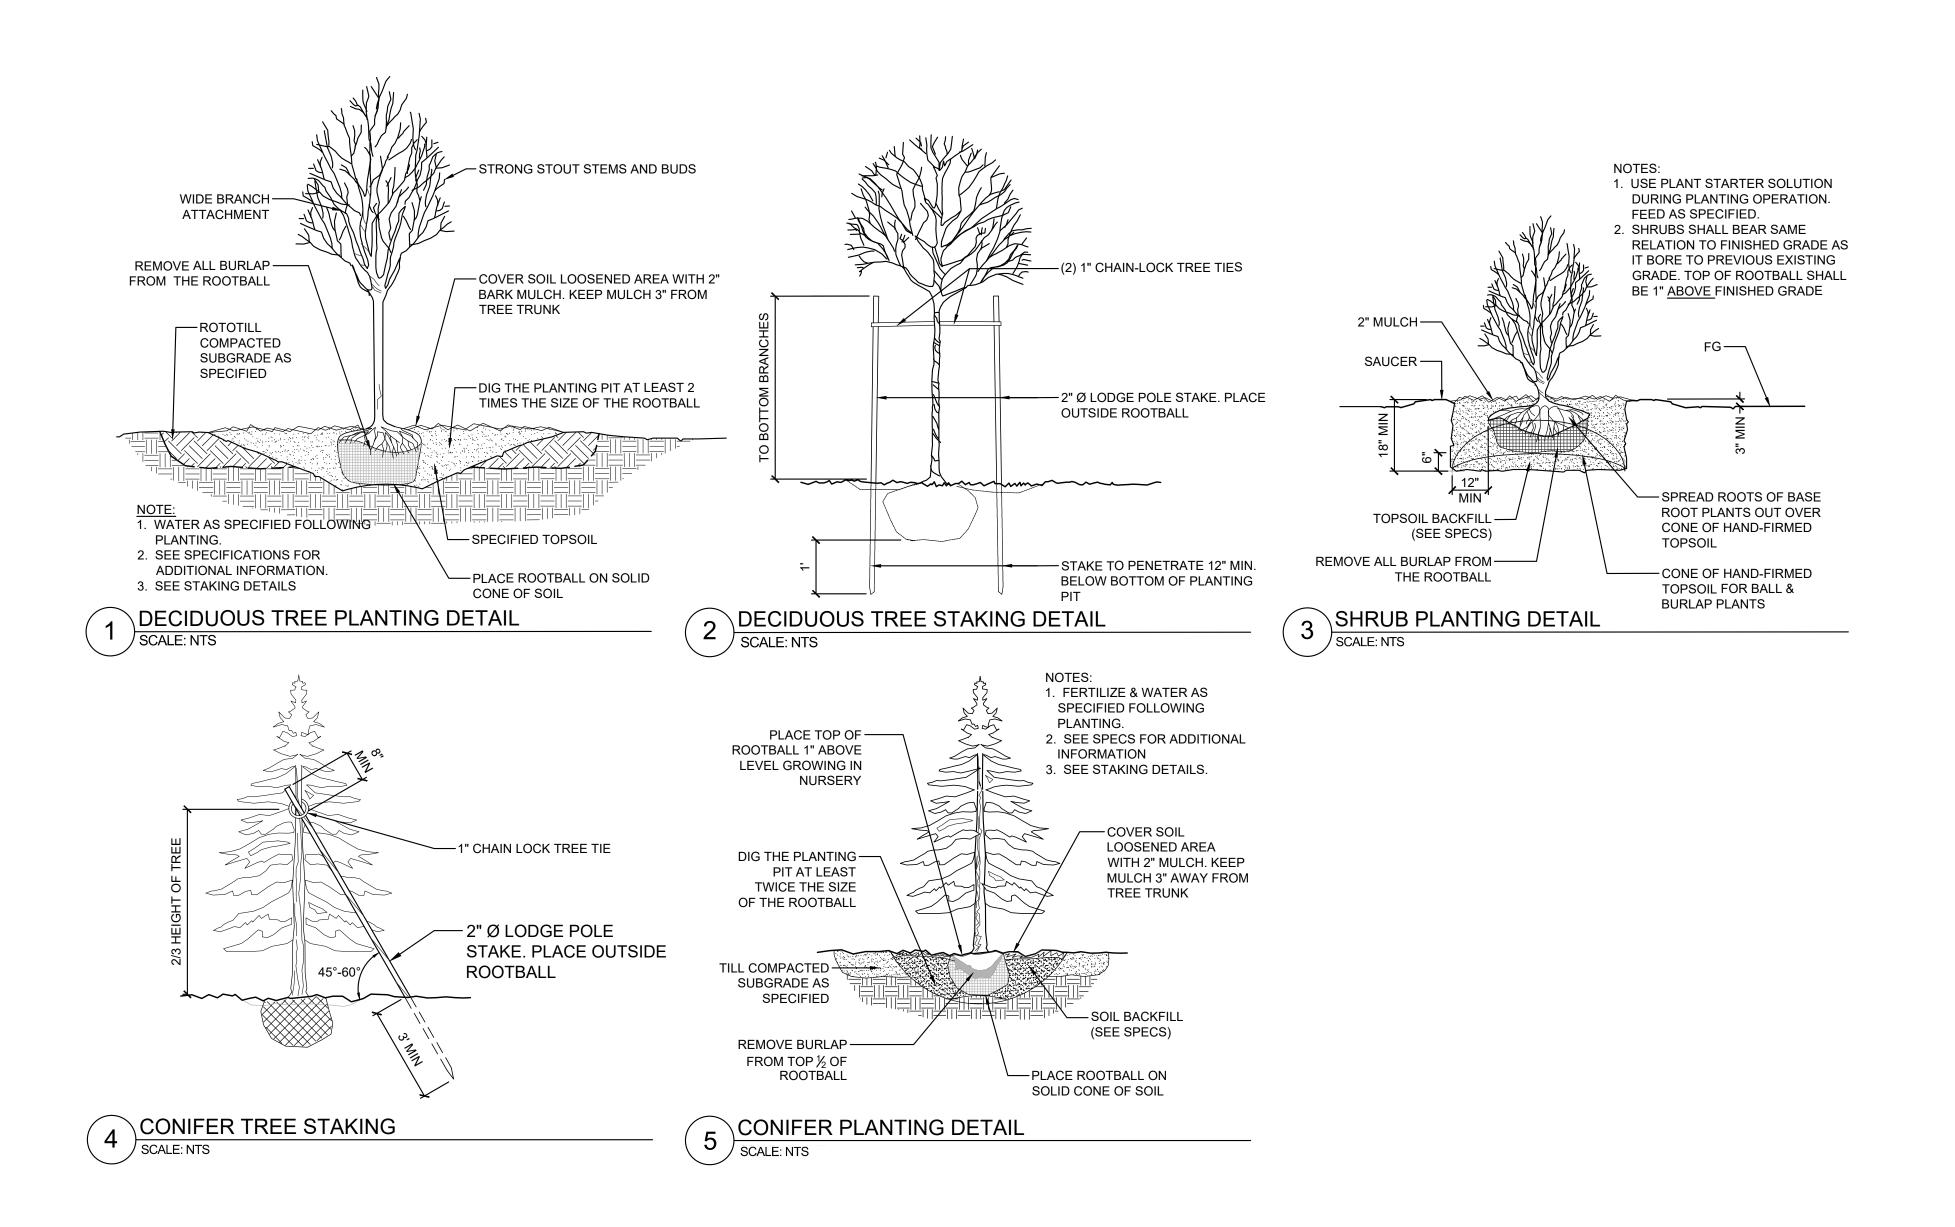
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KINNIKINNICK

DWARF PURPLE FOUNTAIN GRASS

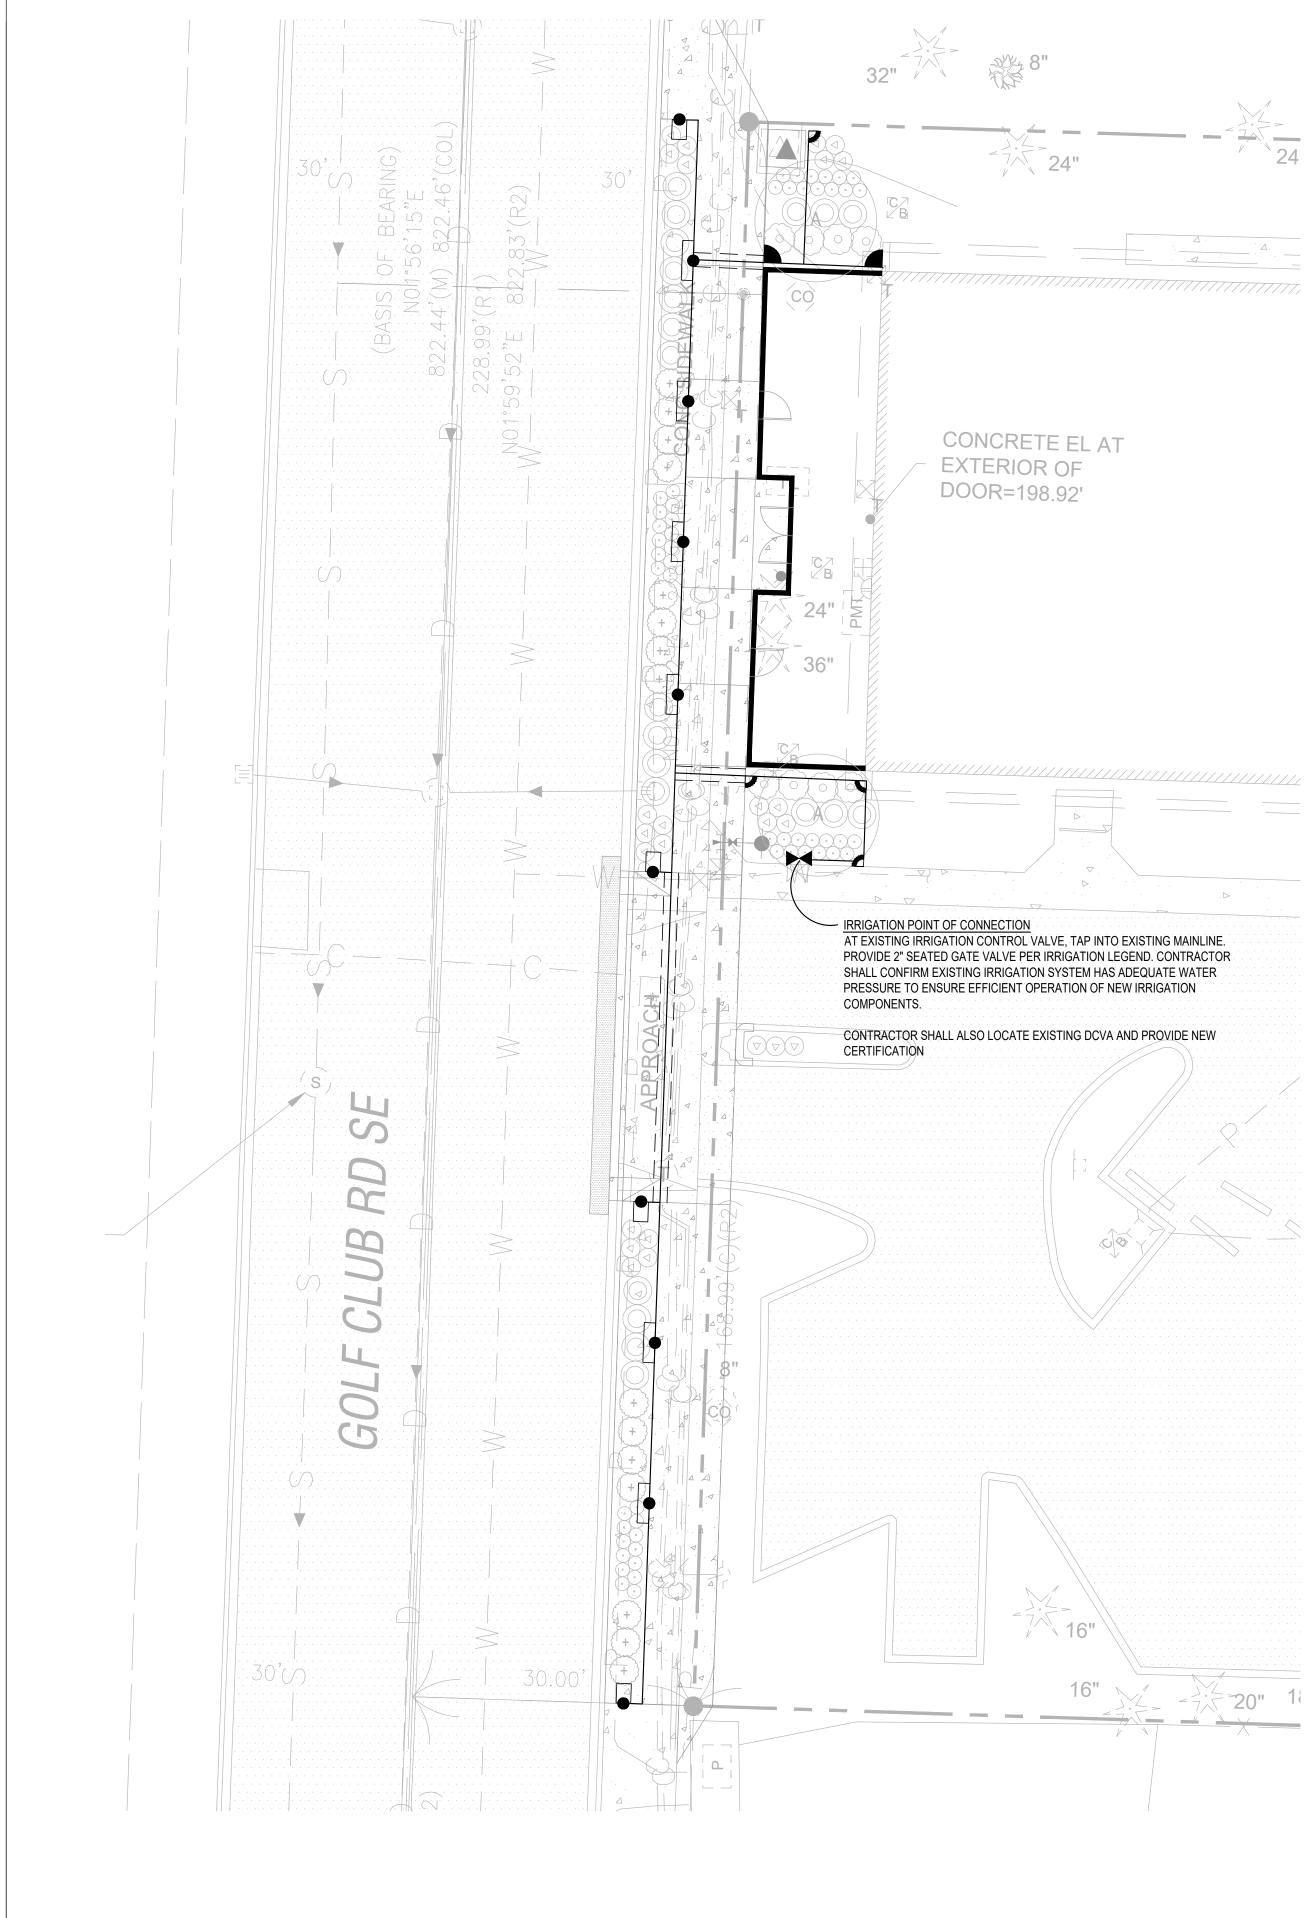
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	REVISIONS: REV 1: REV 2: REV 3:
	Studio 39 Apartment Building 420 Golf Club Road SE Lacey, WA 98503
	DESIGN: EJW DRAWN: EJW CHECKED: MJL DATE: March 14, 2024 PROJECT: Studio 39 Apartments NUMBER: LLA0486.24
	SCALE: 1" = 10'-0" TITLE: Plant Legend and Images
lig.	SHEET: L1.01





Permit Set	L N O N Landscape Architects 2111 South C Street, Tacoma, WA 98402 253-678-4173   Eric@LyonLA.com
	REVIEW SET NOT FOR NOT FOR WASHINGTON CONSTRUCTION WILLIAMS CERTIFICATE NO. 775
	REVISIONS: REV 1: REV 2: REV 3:
	PROJECT ADDRESS: Stodio 39 Apartment Building 420 Golf Club Road SE Lacey, WA 98503
	DESIGN: EJW DRAWN: EJW CHECKED: MJL DATE: March 14, 2024 PROJECT: Studio 39 Apartments NUMBER: LLA0486.24
	SCALE: TITLE: Planting Details
dig.	SHEET: L1.02





# IRRIGATION LEGEND

SYMBOL	MFG.	MODEL #	DESCRIPTION	
DCV	NOT SHOWN -DOUBLE CHECK VALVE ASSEMBLY W/ UNIONS, CONTRACTOR TO FIELD LOCATE AND PROVIDE NEW CERTIFICATION			
$\square$	KENNEDY	8561ASS	2" RESILIENT SEATED GATE VALVE	
С	NOT SHOWN - EXISTING IRRIGATION CONTROLLER, CONTRACTOR TO ENSURE PROPER OPERATION BEFORE, AFTER AND DURING CONSTRUCTION			
SCHEDULE 200 PVC LATERAL LINES, SIZE TO NOT EXCEED 7 FPS @ 12" DEPTH				
$arphi = = = \Rightarrow$ class 200 PVC sleeves @ 24" depth, Min. 4" diameter, size to accomodate mainline, lateral lines				

### IRRIGATION HEAD SCHEDULE

SYM.	CATALOG NUMBER	RADIUS	GPM	PSI	
	SPRAY HEADS				
ь	RAINBIRD 1800-MPR-10Q	10	0.39	30	
	RAINBIRD 1800-MPR-15Q	15	0.95	30	
	RAINBIRD 1800-MPR-15EST	4'X15'	0.61	30	
•	RAINBIRD 1800-MPR-15SST	4'X30'	1.21	30	

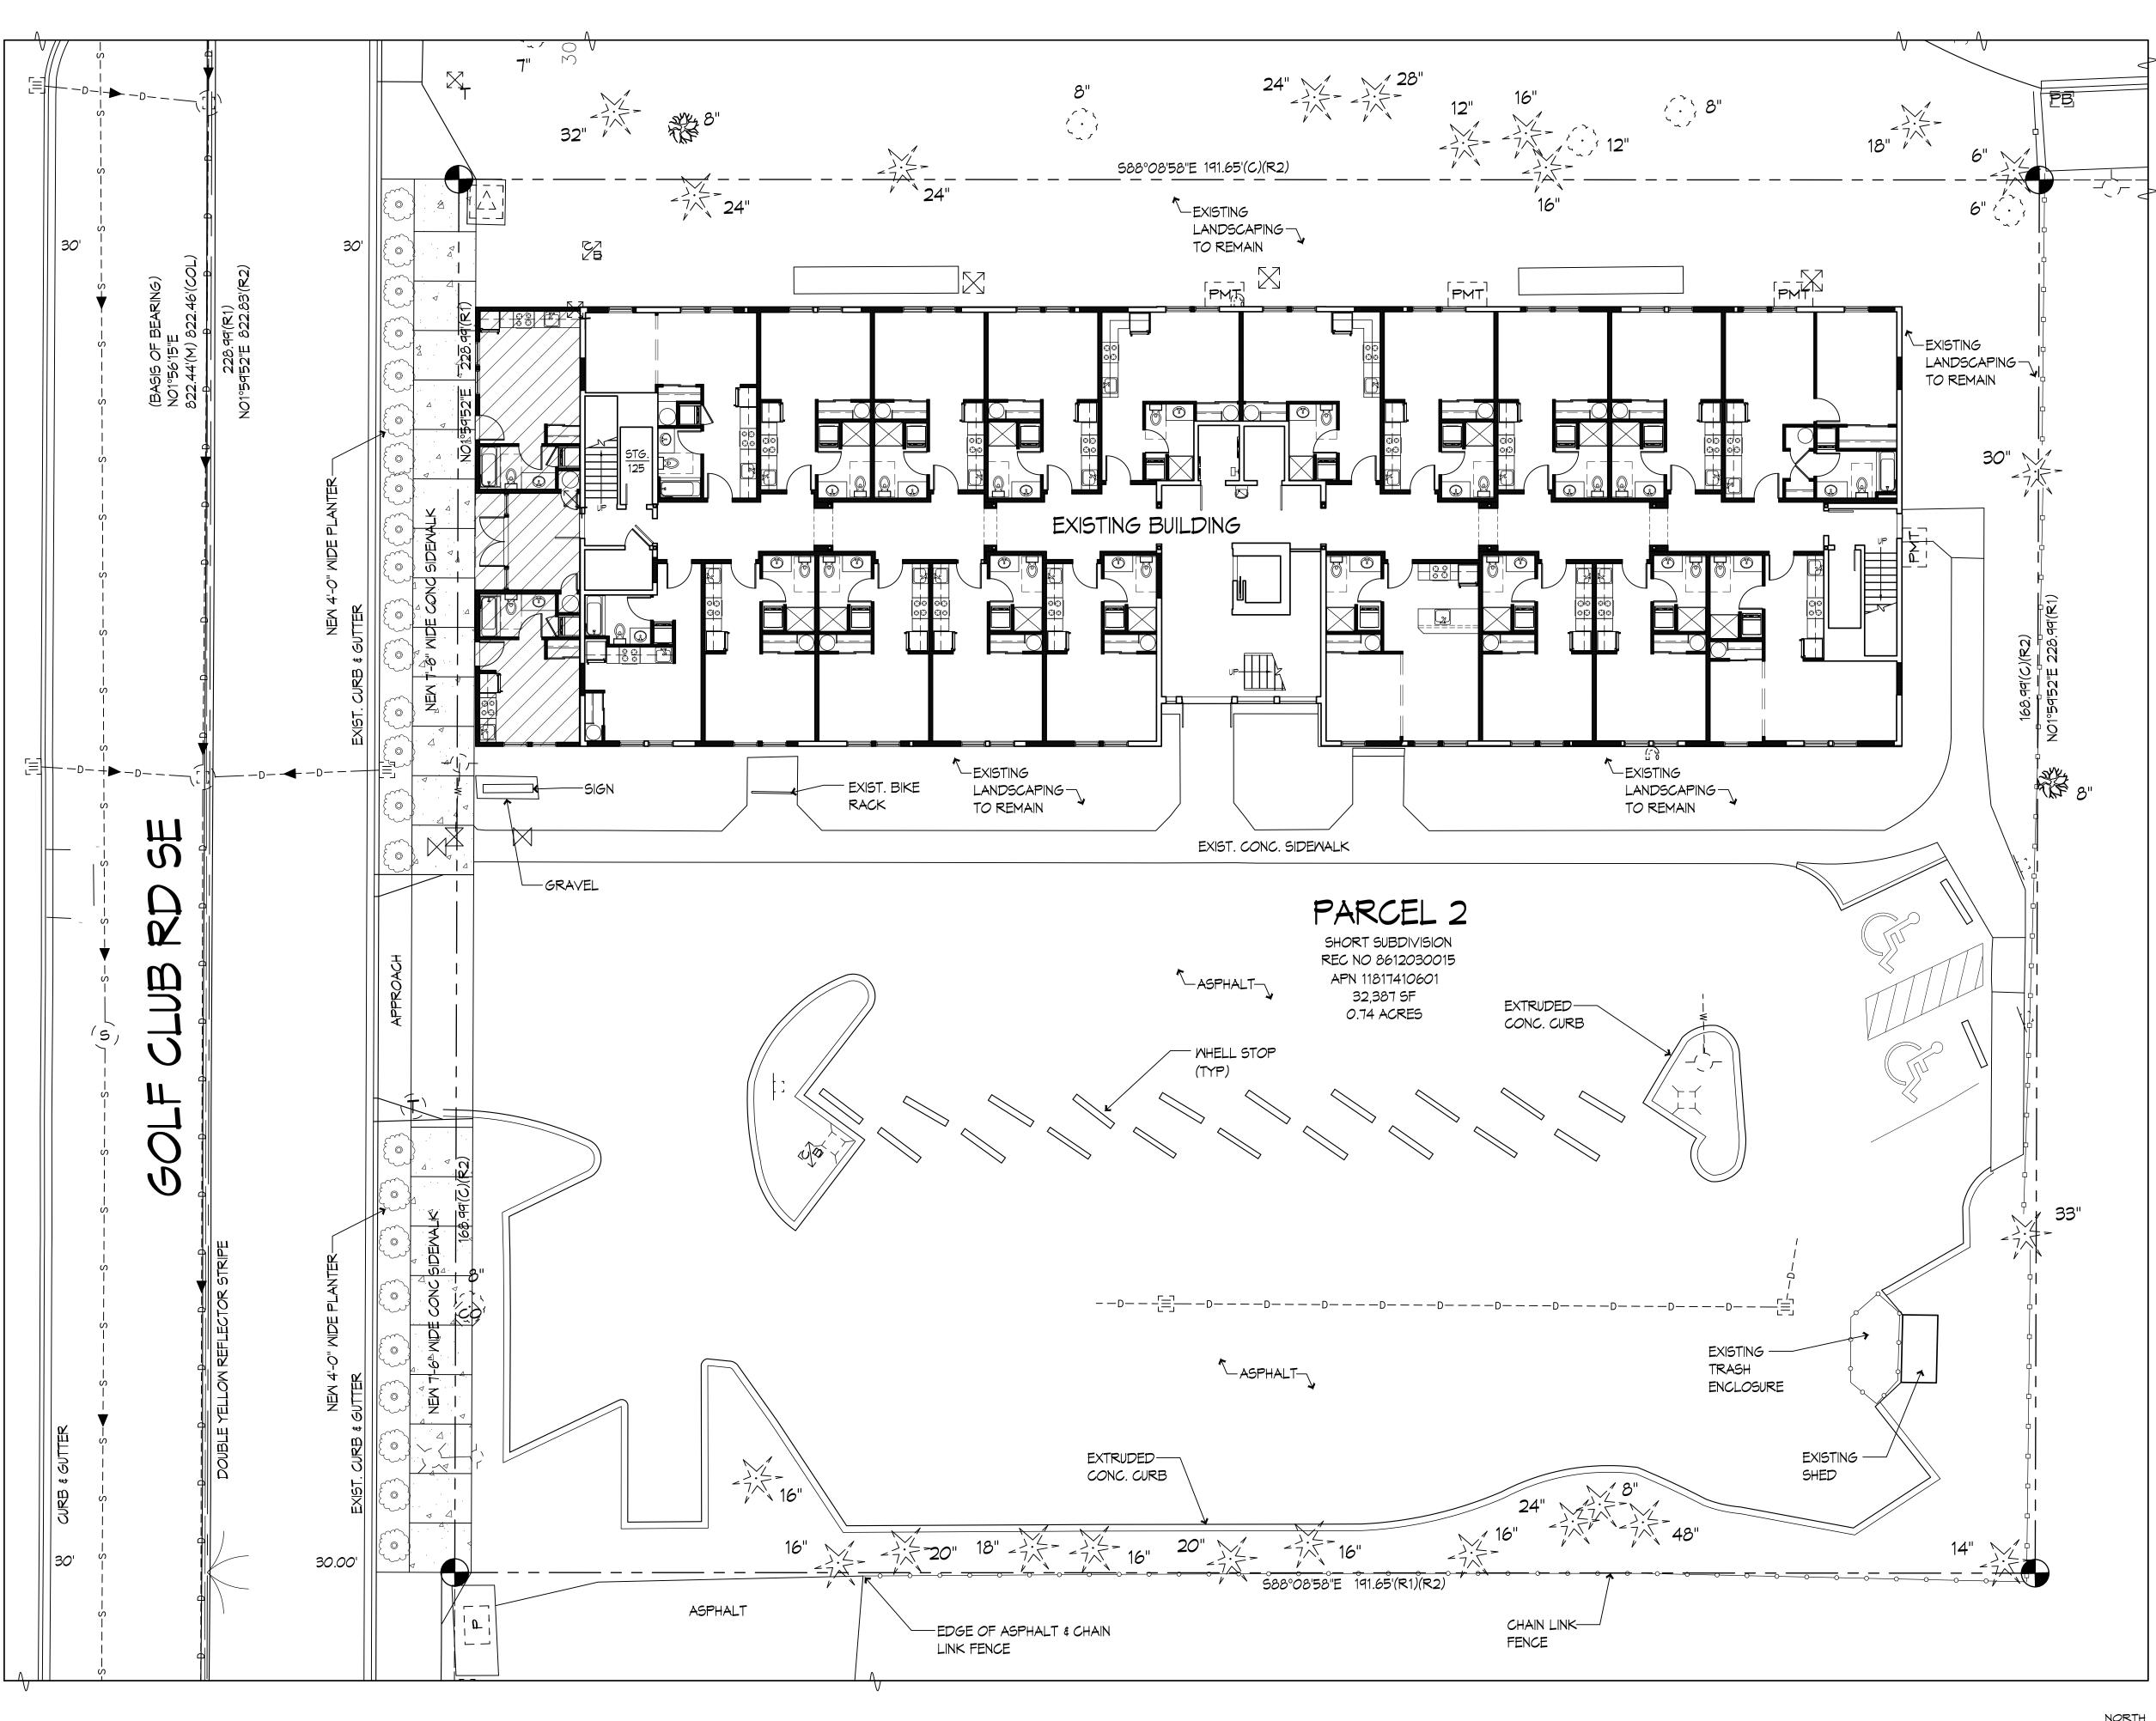
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Permit Set	L X O N Landscape Architects 2111 South C Street, Tacoma, WA 98402 253-678-4173   Eric@LyonLA.com
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	<b>Studio 39 Apartment Building</b> <b>A20 Golf Club Road SE</b> Lacey, WA 98503
Know what's below.	DESIGN: EJW DRAWN: EJW CHECKED: MJL DATE: March 14, 2024 PROJECT: Studio 39 Apartments NUMBER: LLA0486.24 SCALE: 1" = 10'-0" TITLE: Irrigation Plan
Call before you dig.	SHEET: L2.00

10'

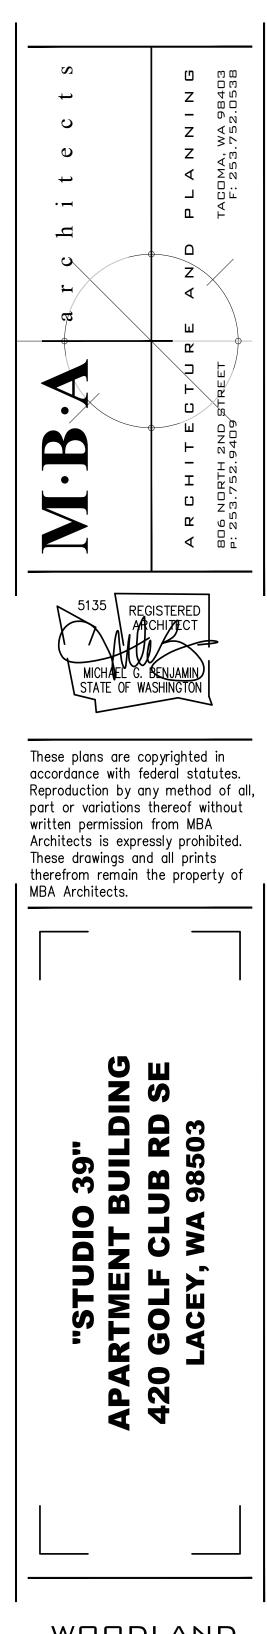
20'

5'



1 ARCHITECTURAL SITE PLAN SCALE: 1:10



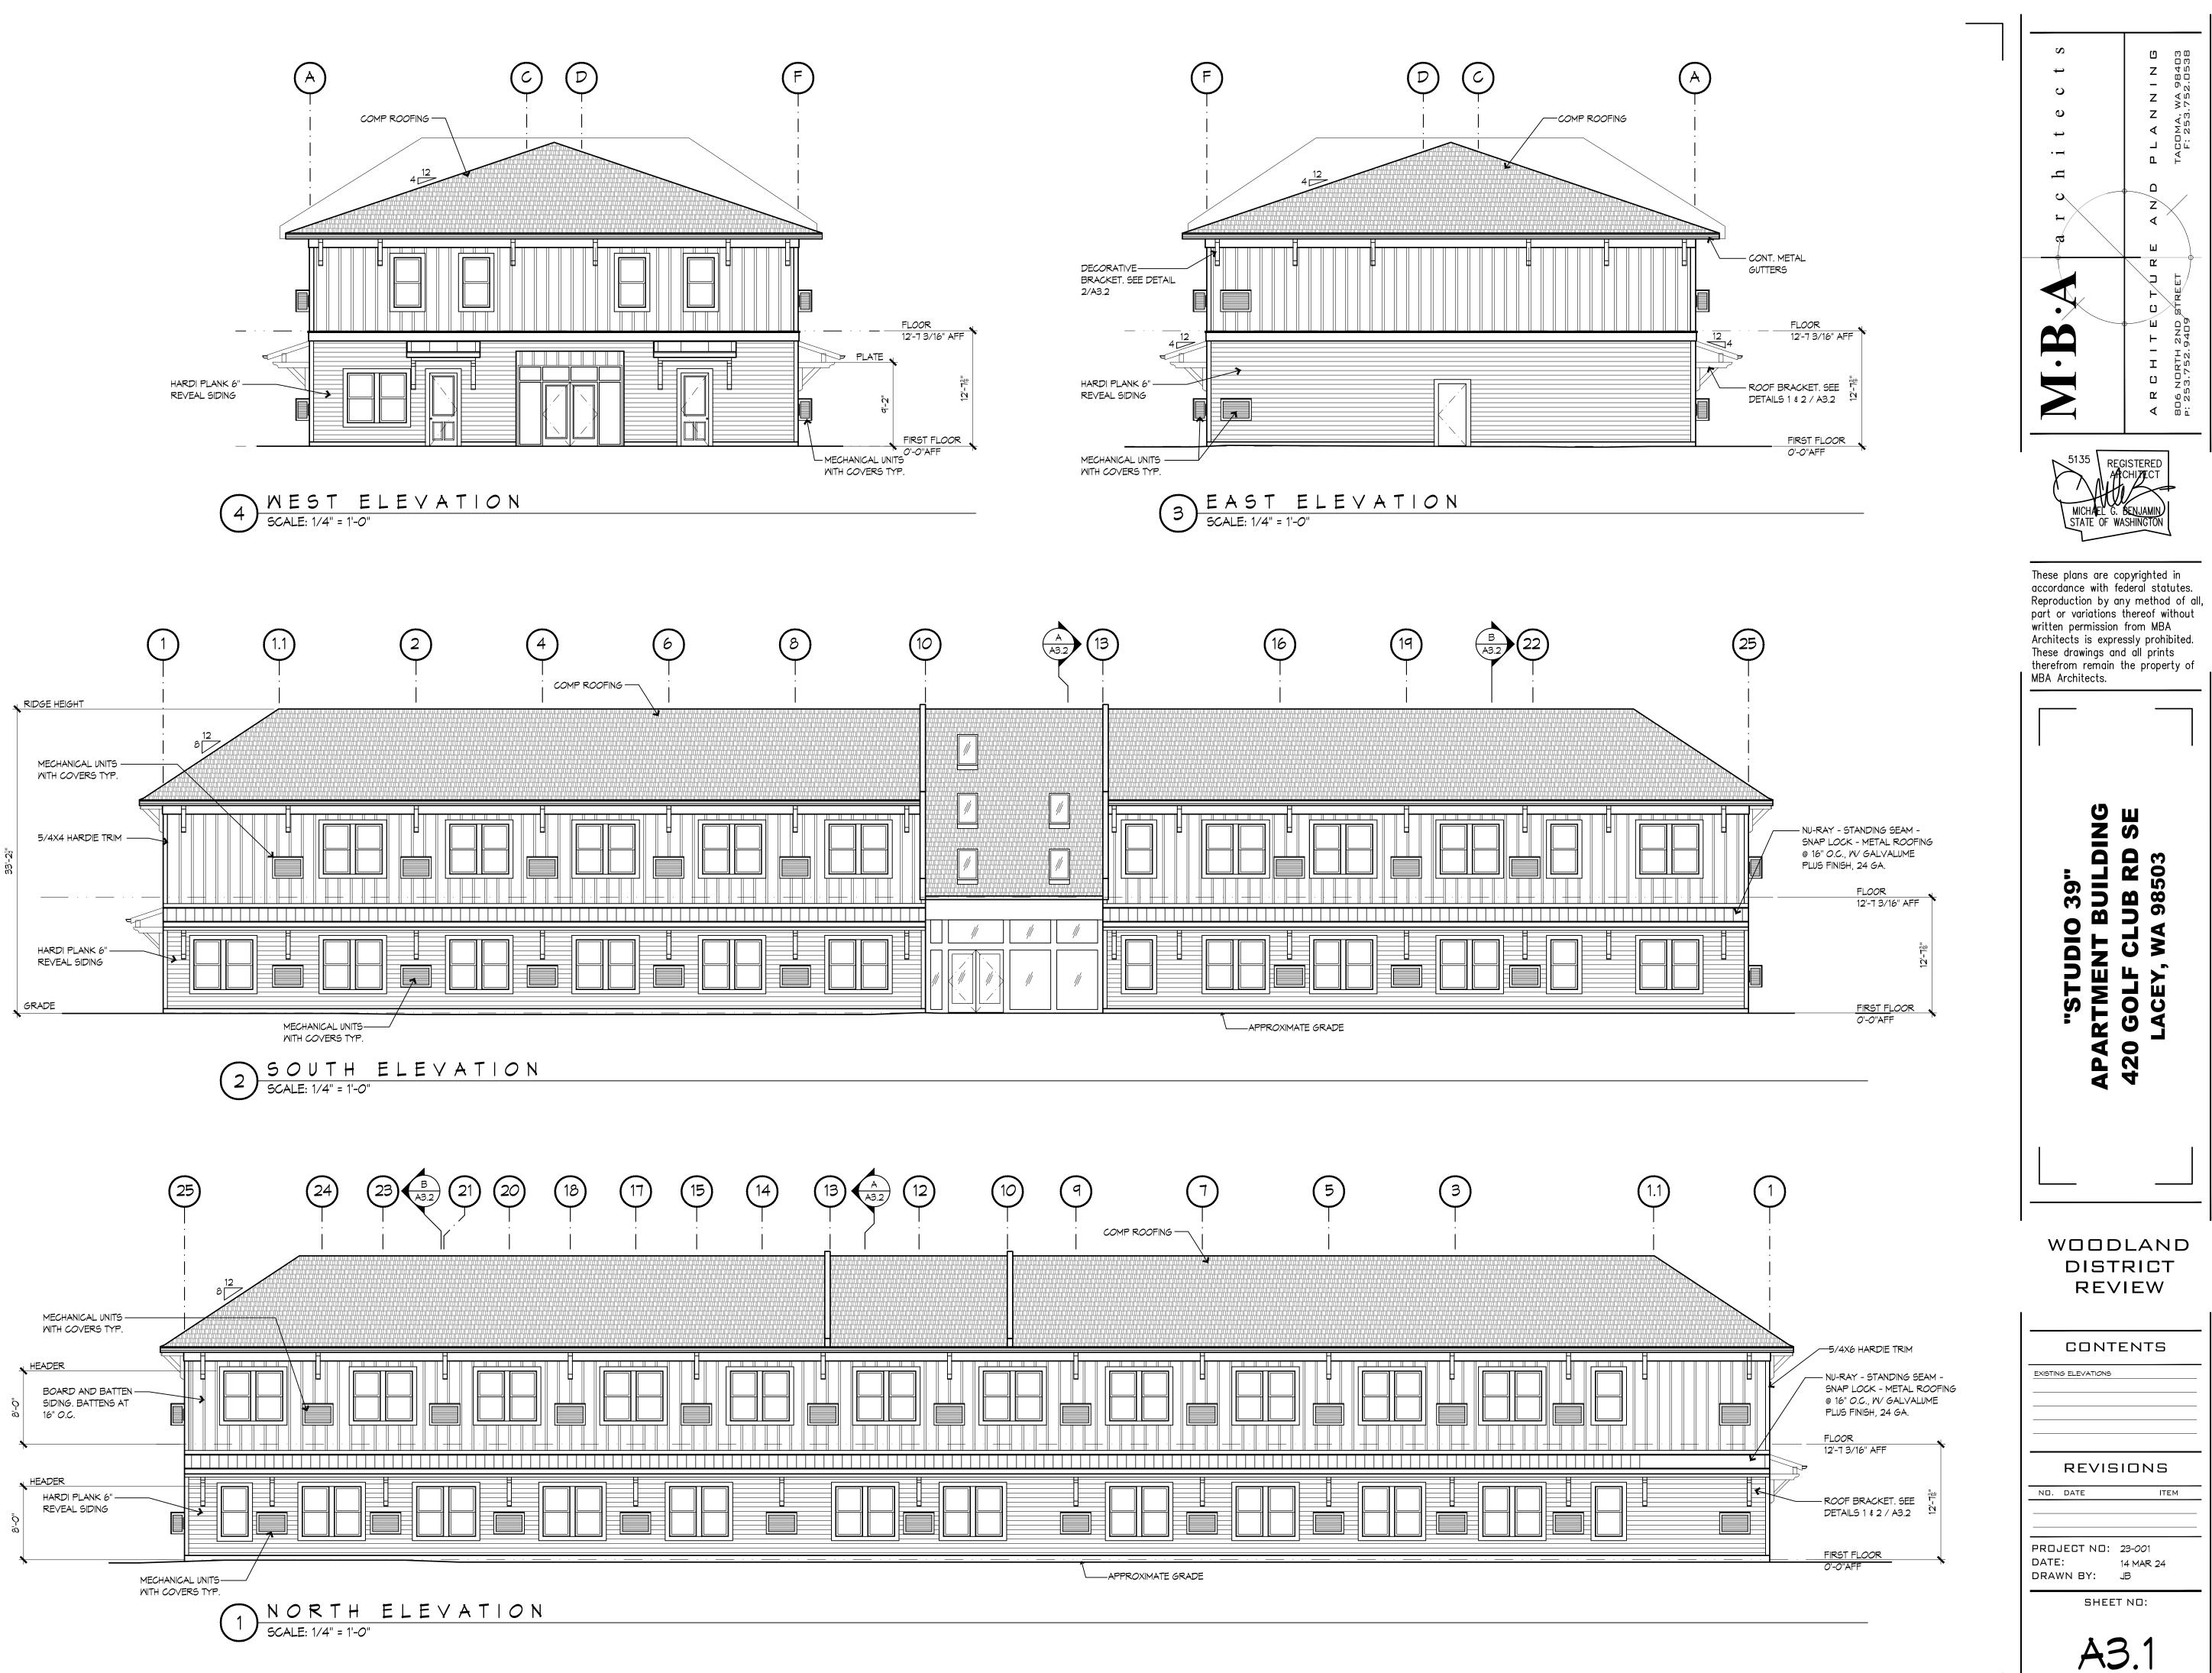


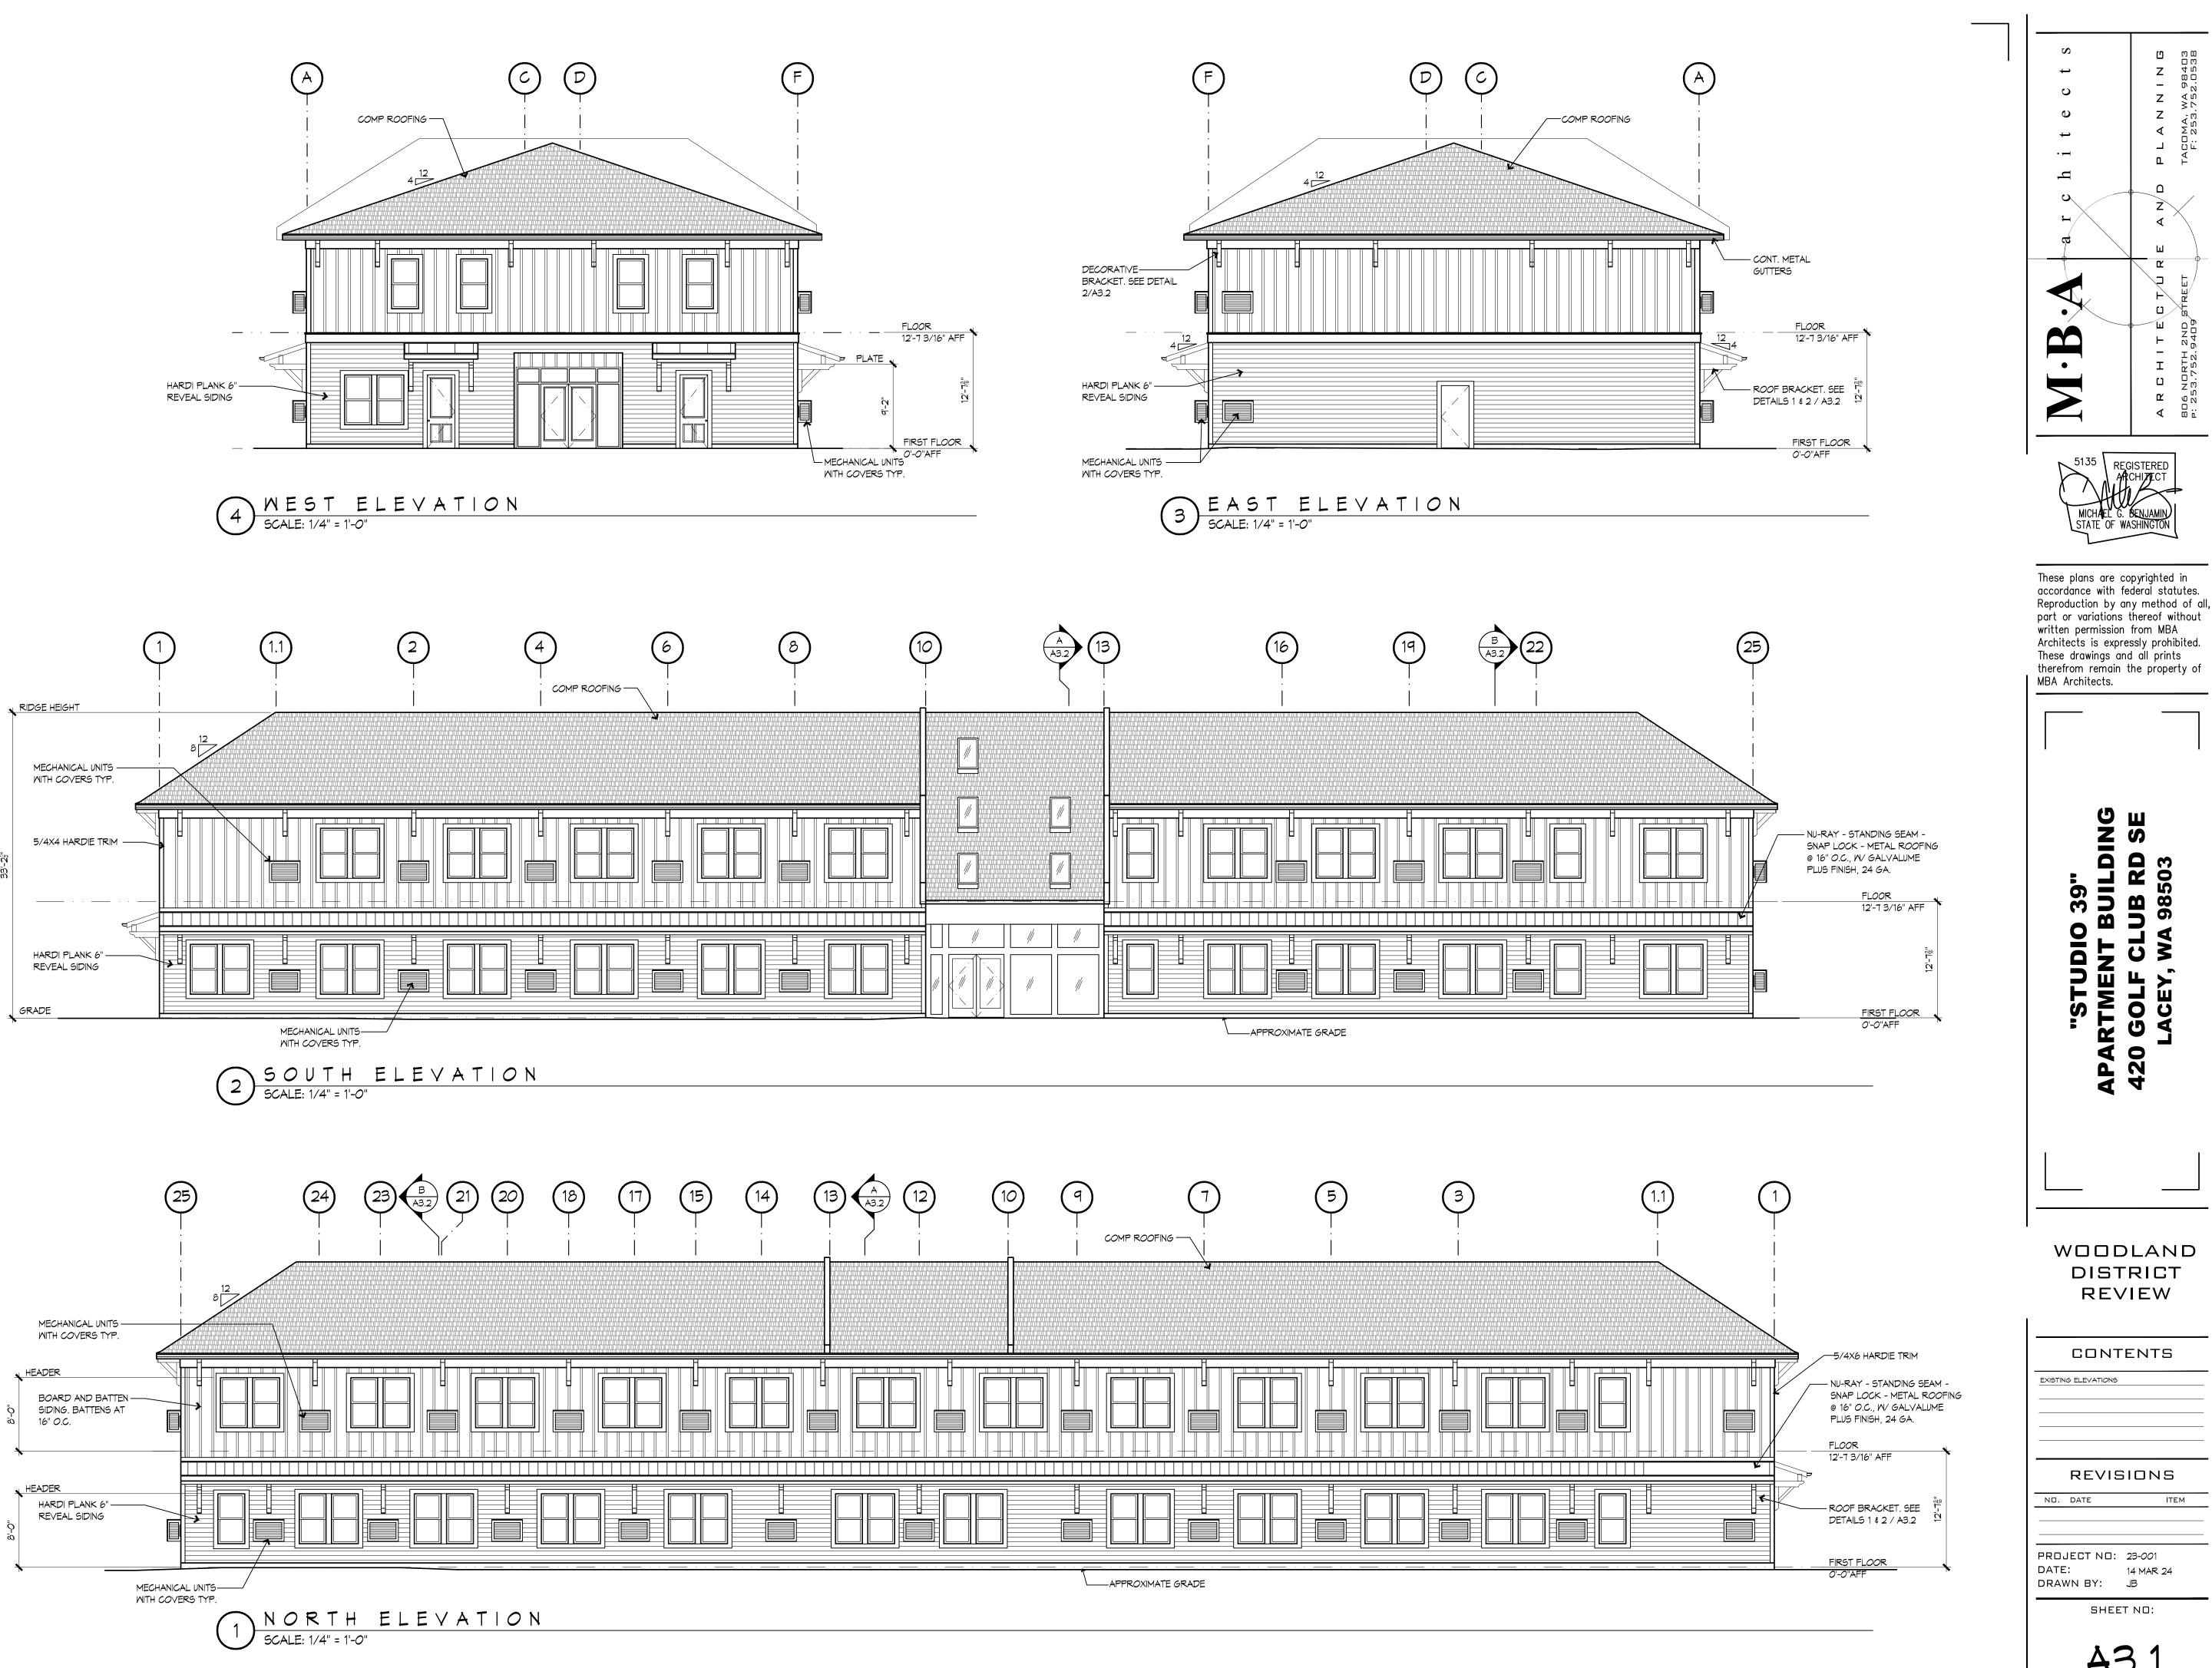
WOODLAND DISTRICT REVIEW

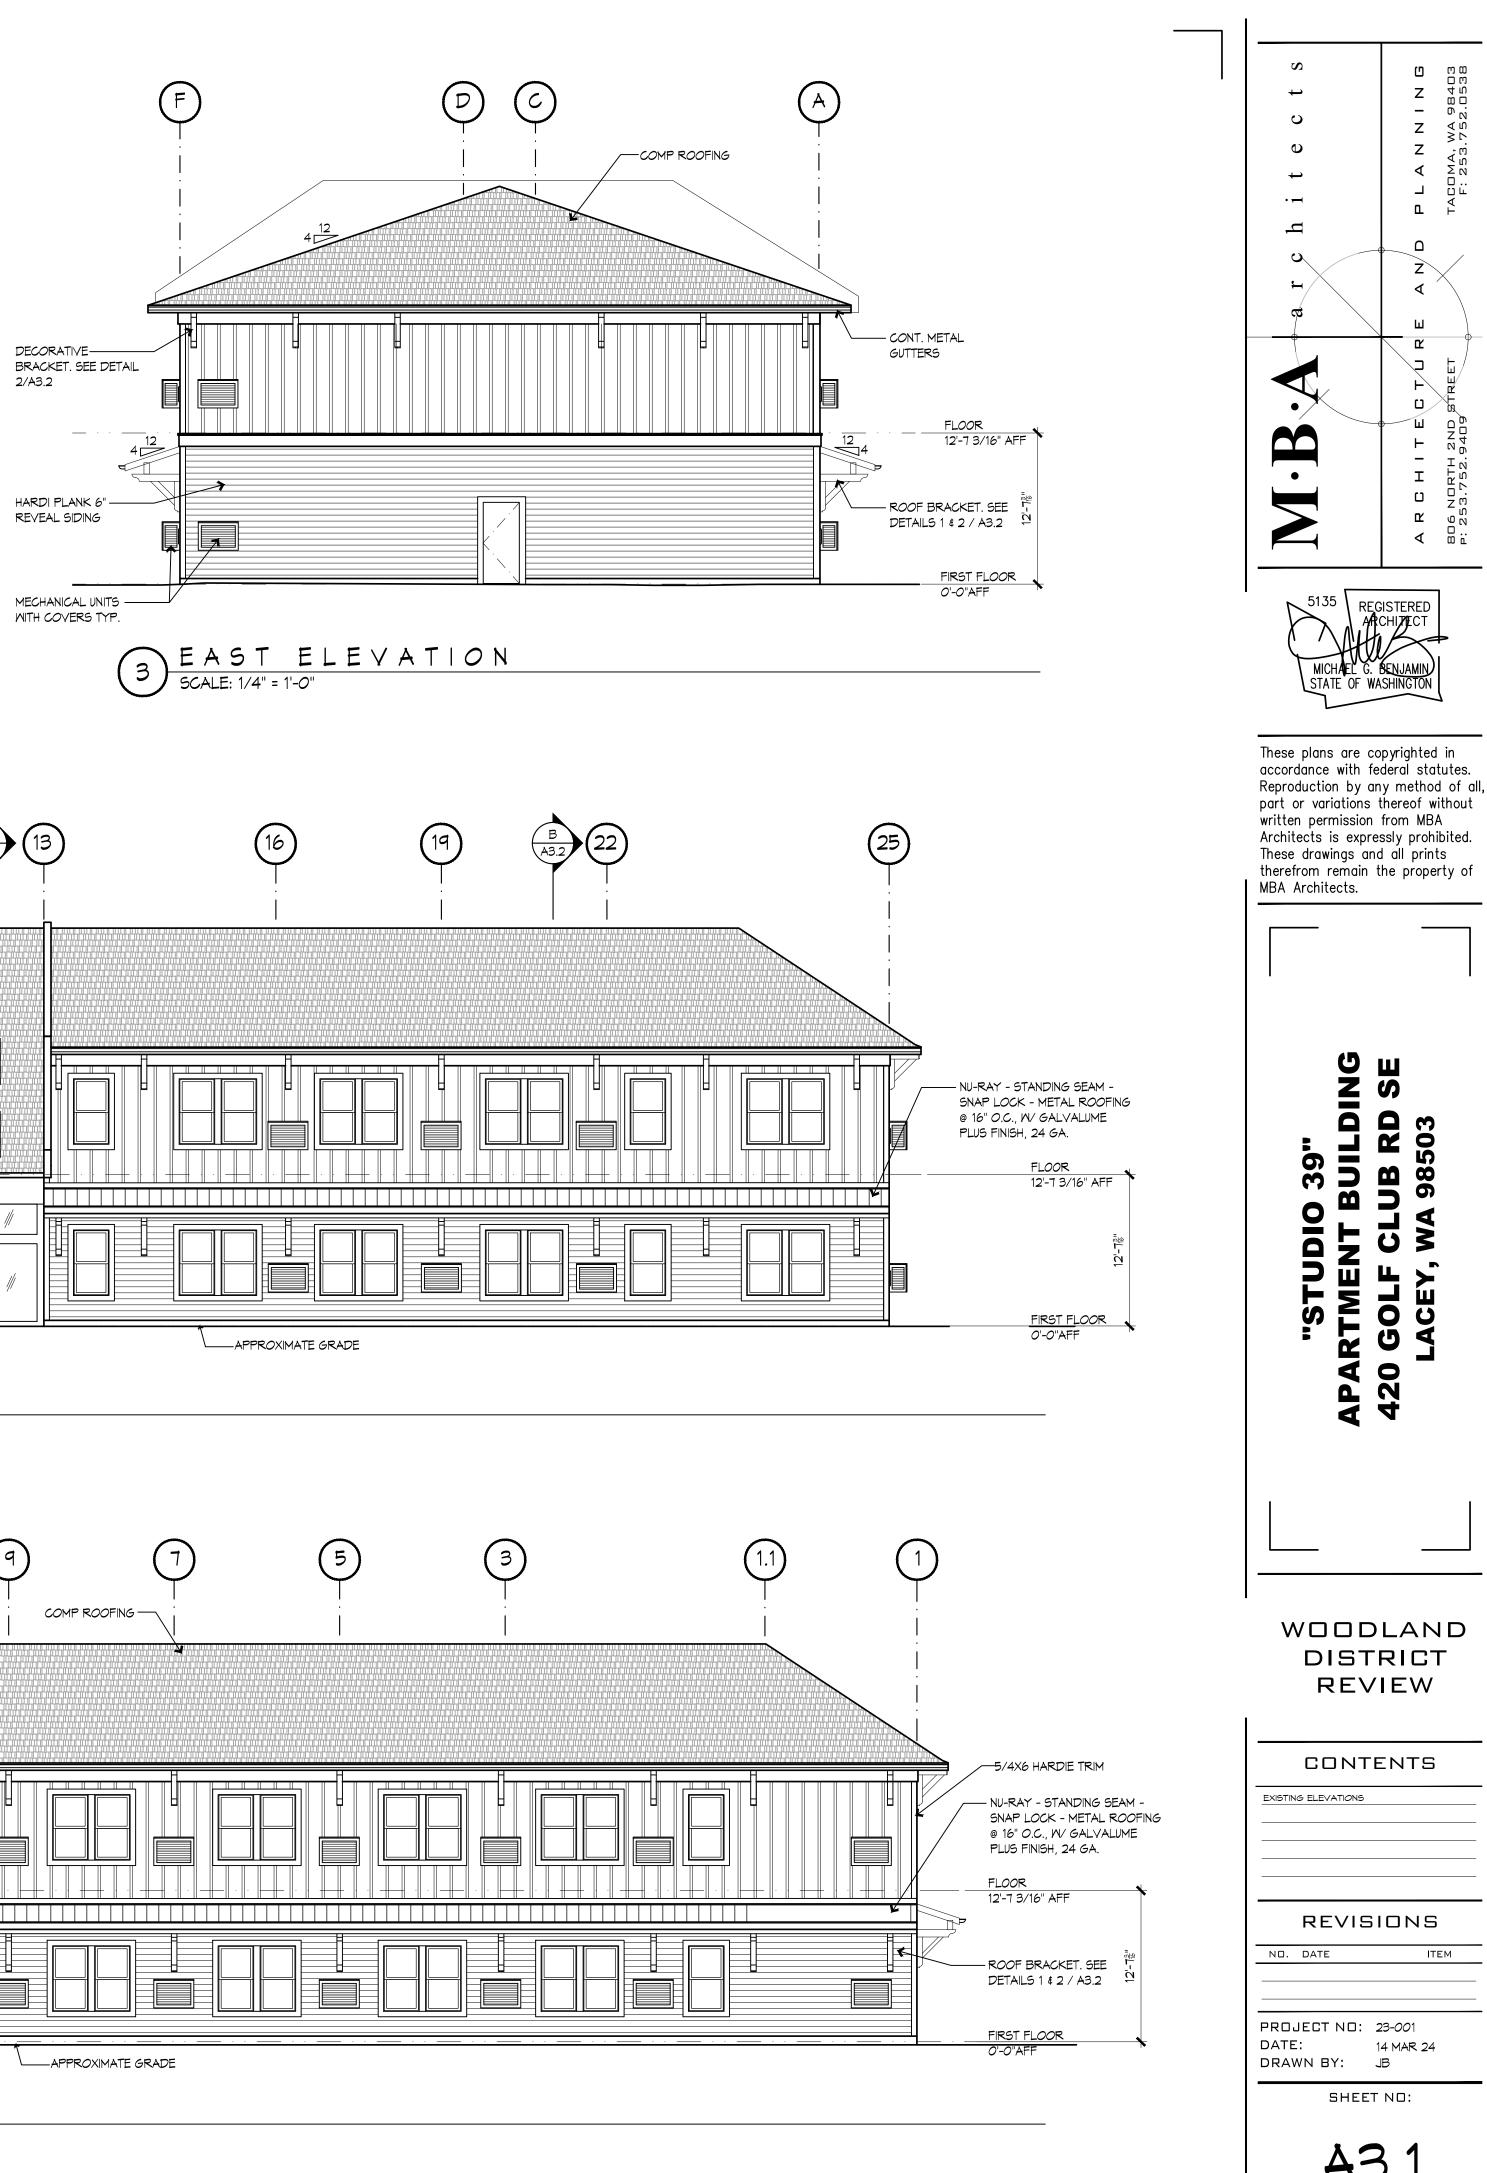
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SHEET NO:				
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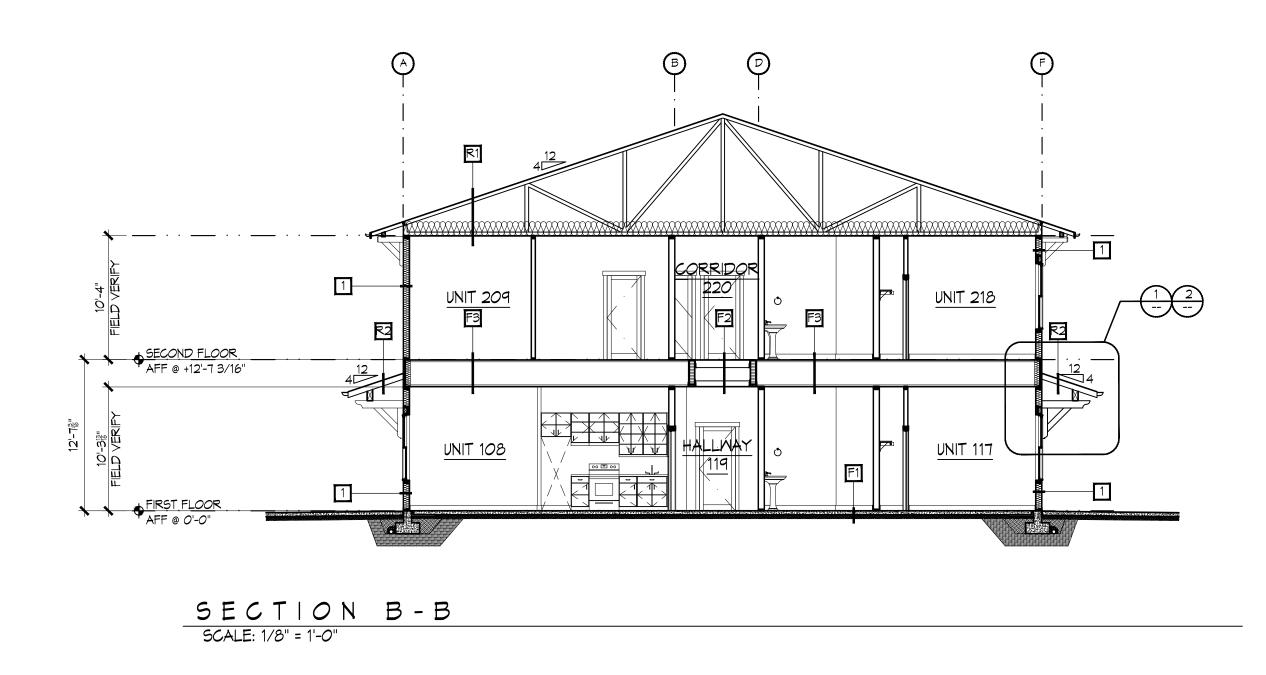


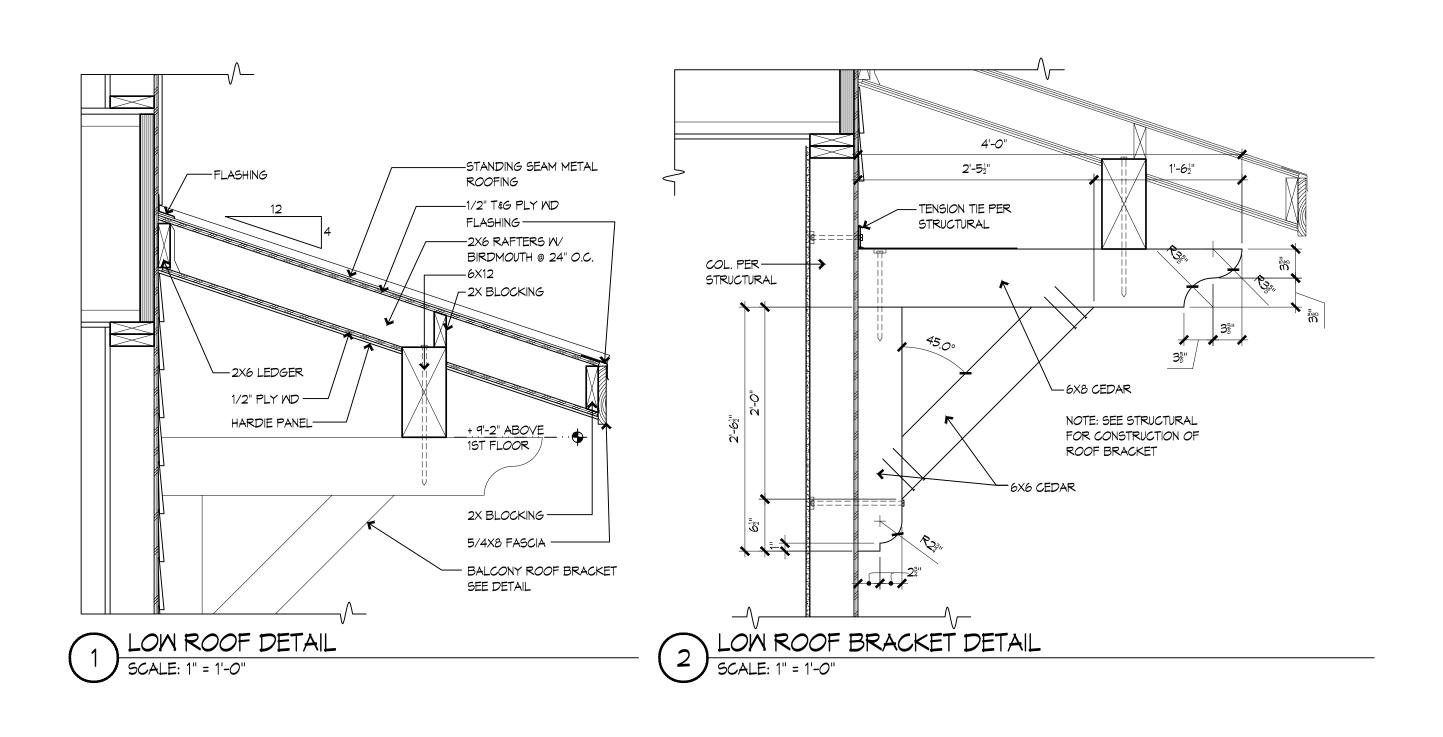


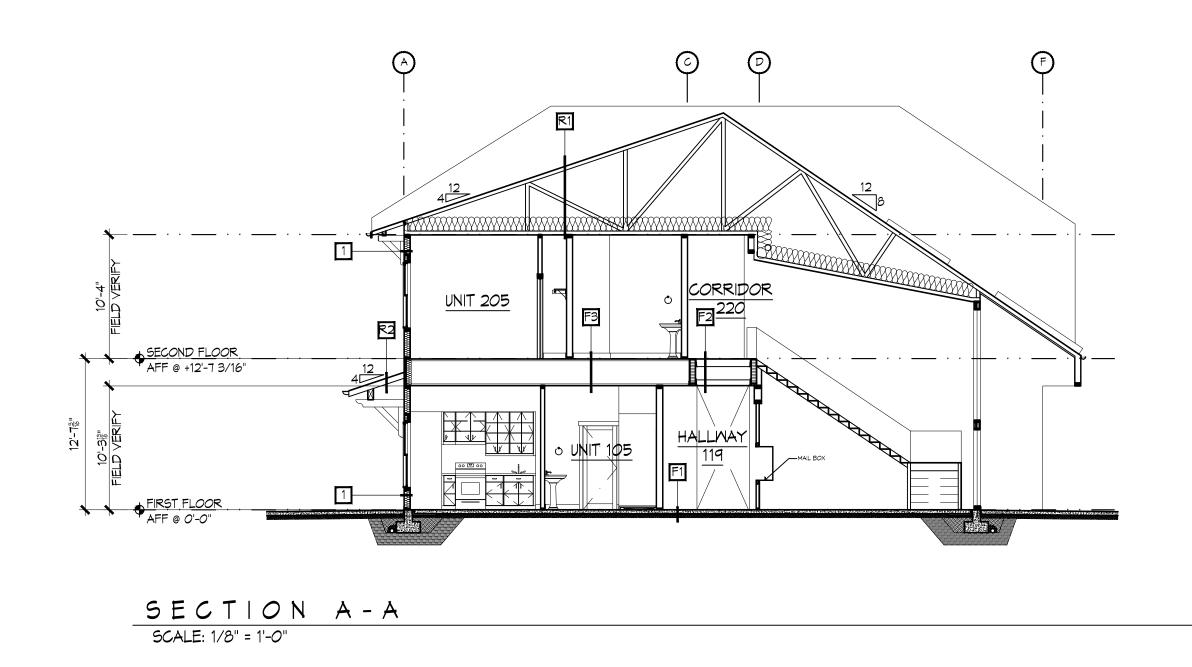


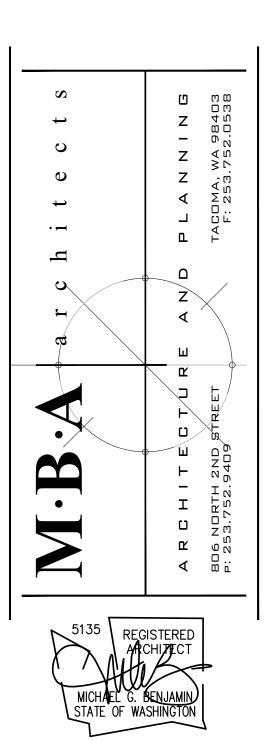




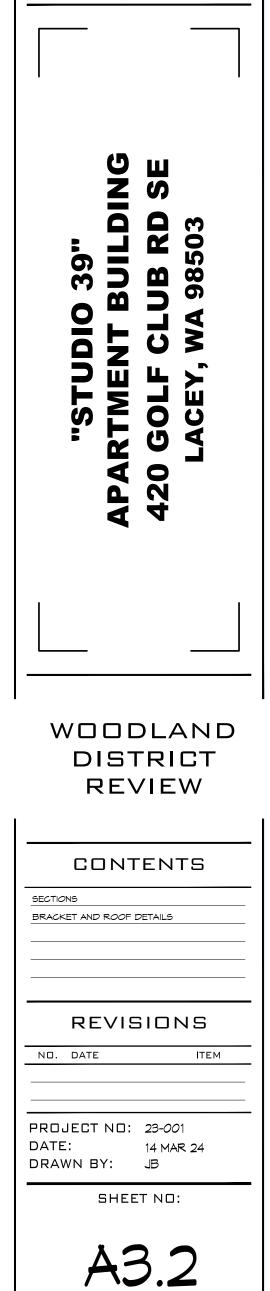




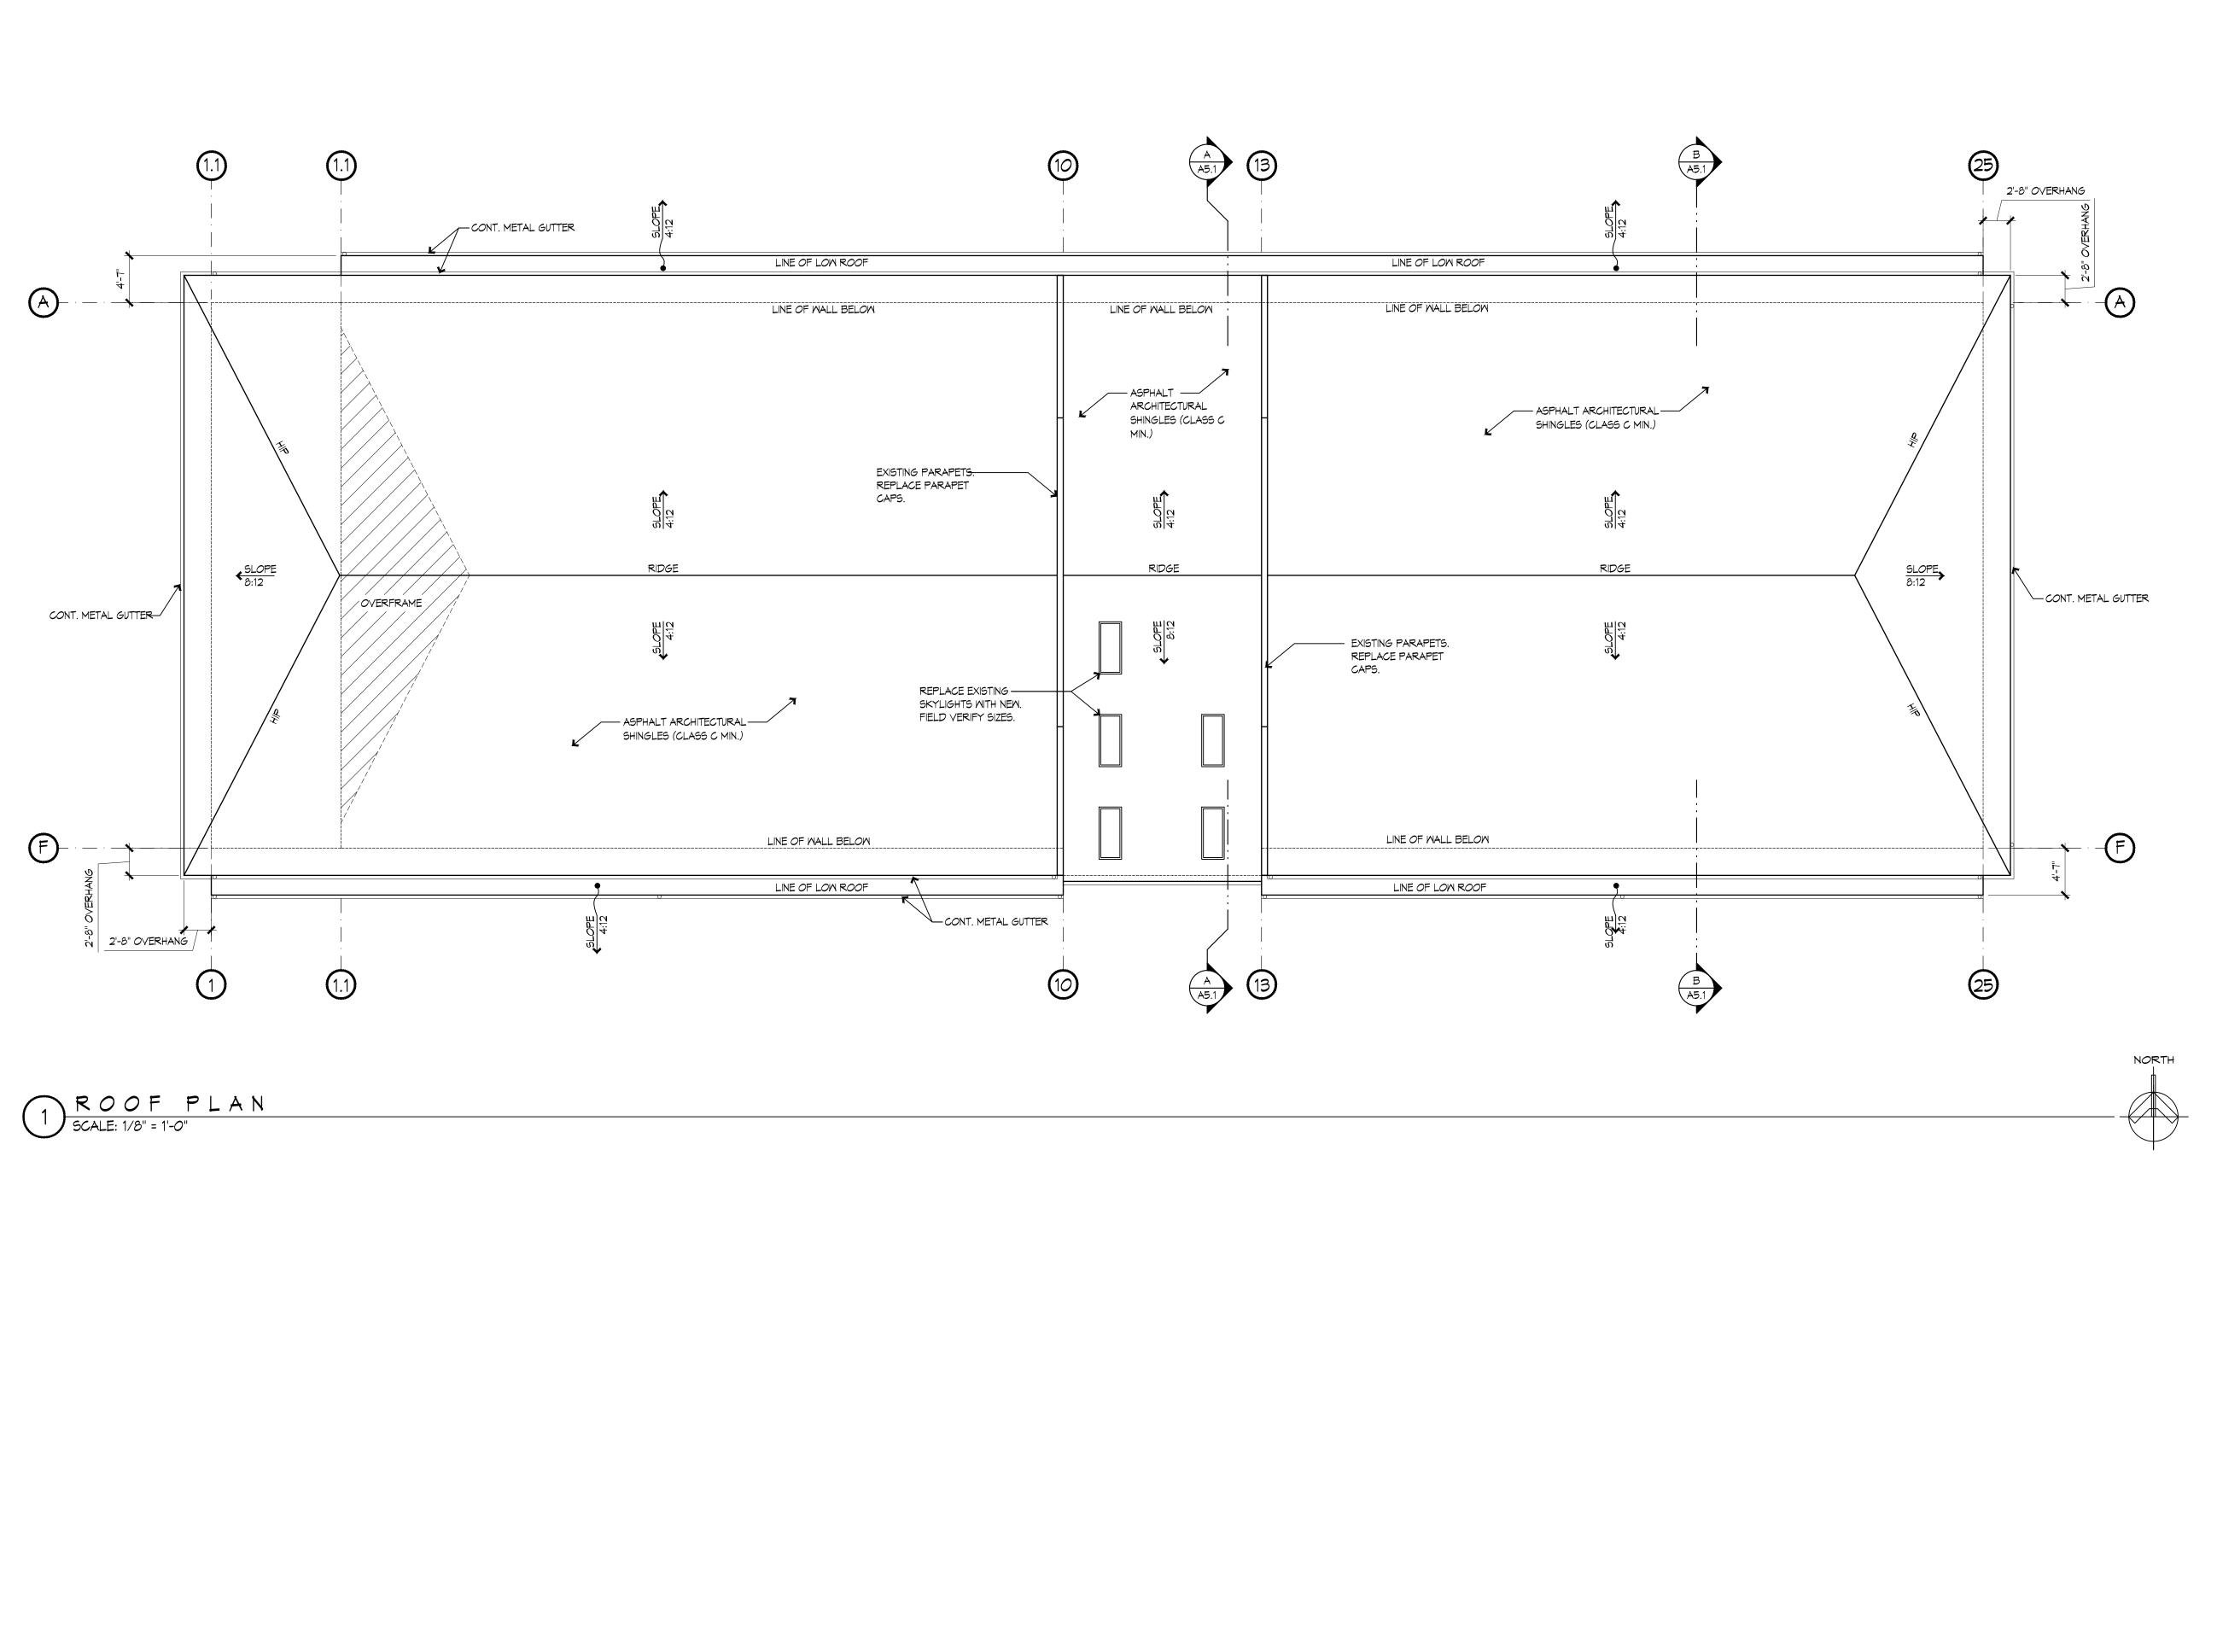


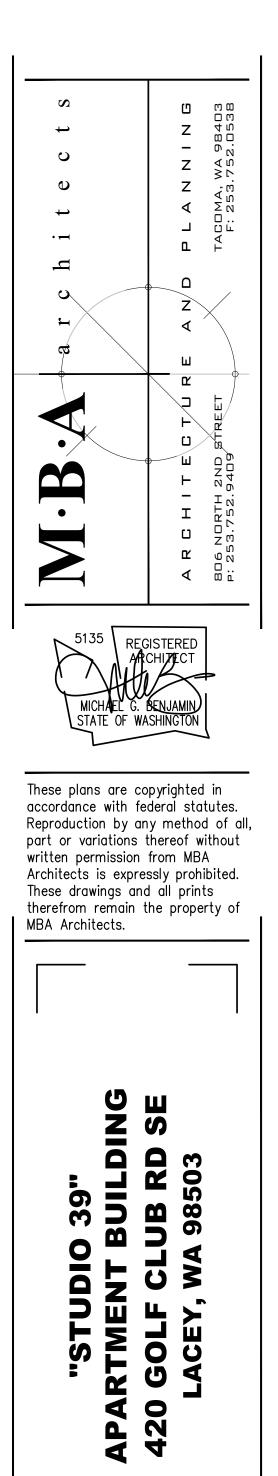


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WOODLAND DISTRICT REVIEW

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