

2024 WATER ANNUAL VALVES

LACEY CONTRACT # PW 2022-30
SECTION 8, 11, 17, 23, 32, 33, AND 34, T18N, R1W, W.M.

LACEY CITY OFFICIALS

MAYOR:

Andy Ryder

DEPUTY MAYOR:

Malcom Miller

CITY COUNCIL:

Lenny Greenstein Michael Steadman

Carolyn Cox Robin Vazquez Nicolas Dunning

CITY MANAGER:

Rick Walk

CITY ATTORNEY:

David S. Schneider

CITY ENGINEER:

Aubrey Collier, P.E., S.E.

DIRECTOR OF

PUBLIC WORKS:

Scott Egger, P.E.

DIRECTOR OF PUBLIC WORKS

6/5/20 DATE

CITY OF LACEY, WASHINGTON DEPARTMENT OF PUBLIC WORKS

420 COLLEGE STREET SE LACEY, WA 98503-1238

LACEY

(360) 491-5600



DESIGNED:
DRAFTED:
CHECKED:
HORZ. SCA
VERT. SCA
FILE:

URBAN GROWTH AREA

DESIGNED: NME
DRAFTED: NME
CHECKED: NME
HORZ. SCALE:
VERT. SCALE:
FILE: VA24AV_CS

2024 WATER ANNUAL VALVES COVER SHEET

	REVISION BLOCK	PAGE NO.	SHEET NO.
DATE	DESCRIPTION	aa	4
_		CS	1
		DWG NO.	OF
		5 04 00	1
		D-24-08	4

SHEET INDEX

Sheet Title

COVER SHEET

GENERAL NOTES

WATER PLANS


DETAILS SHEET

Sheet Number

Sheet Title

WA1

DT1

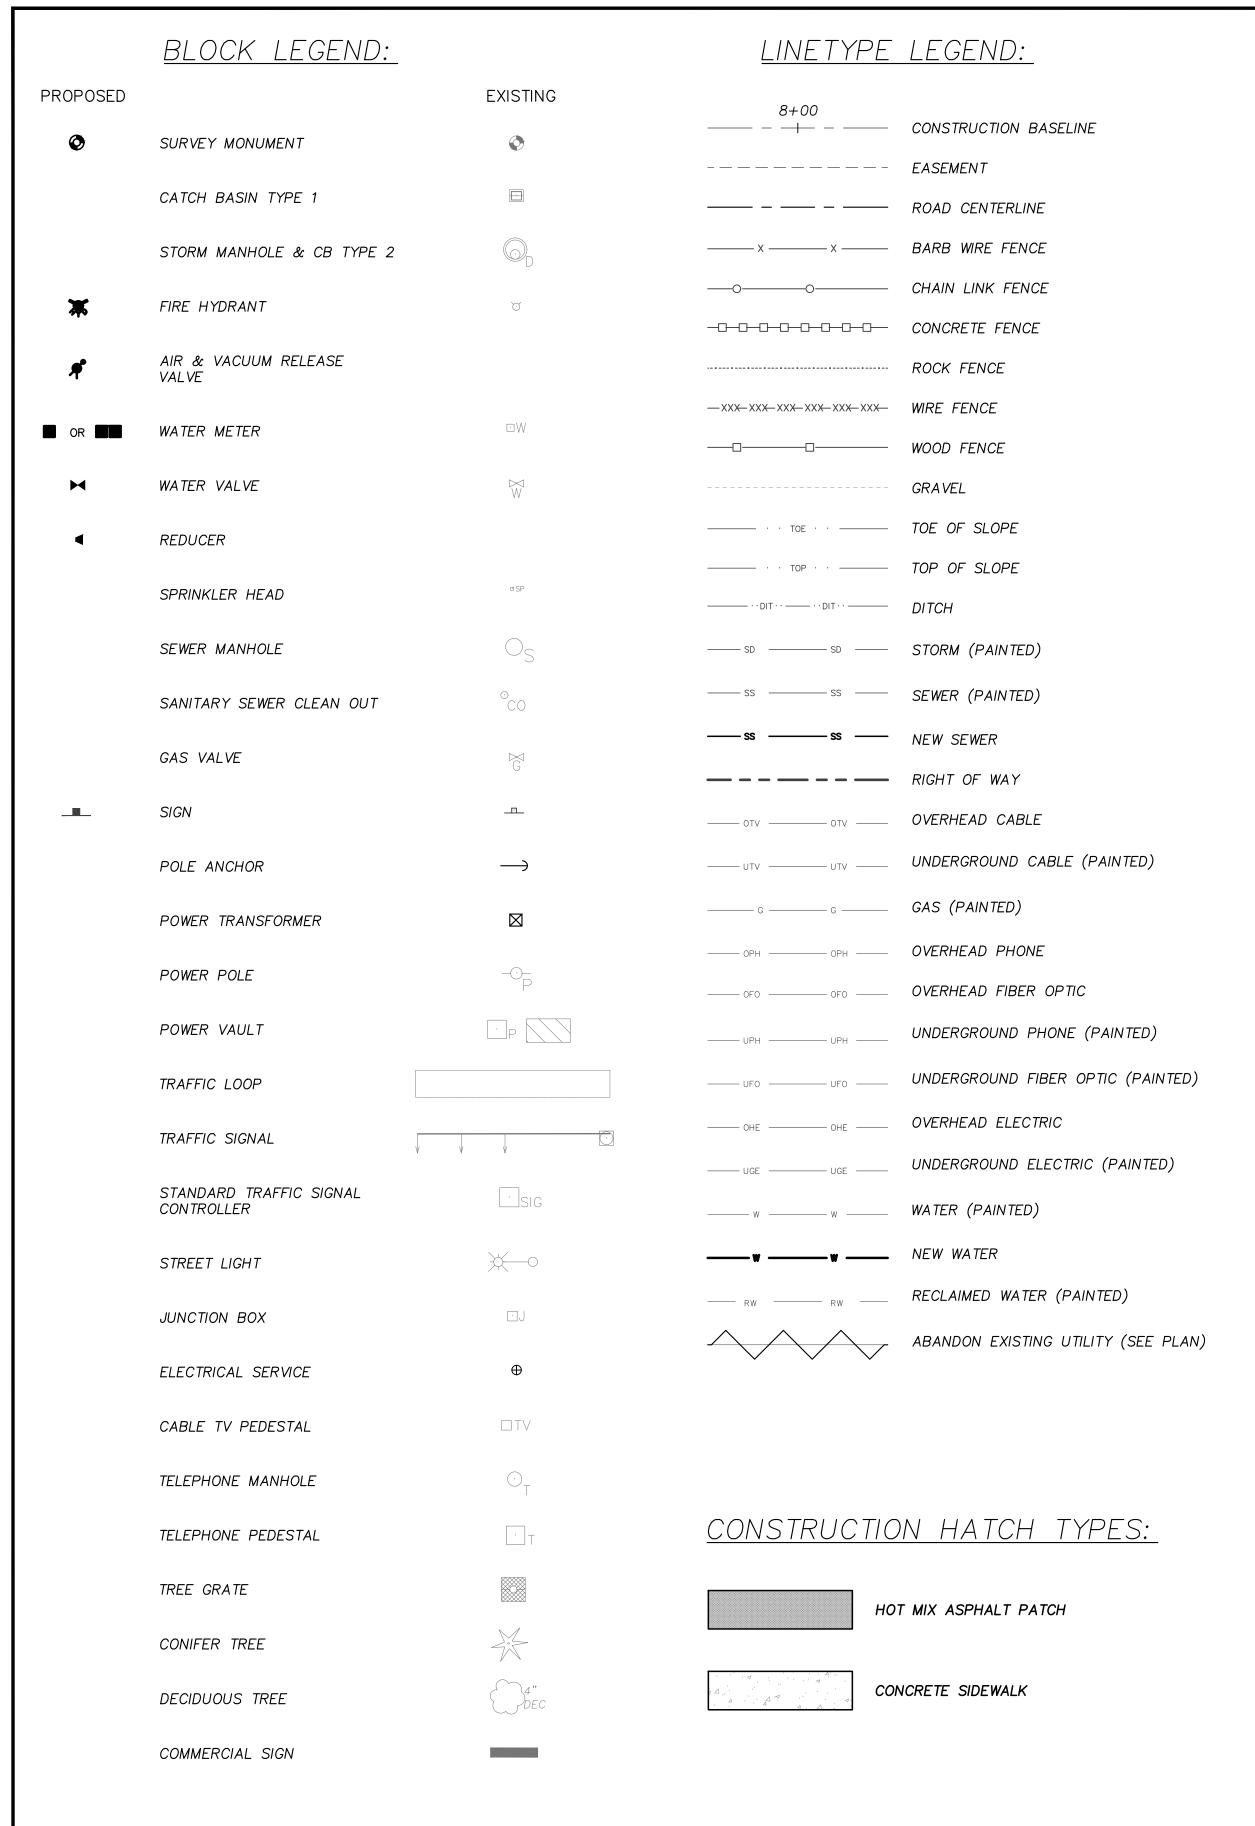

(360) 491-5600

ABBREVIATIONS:

\triangle	DEFLECTION ANGLE
EP	EDGE OF PAVEMENT
RT	RIGHT
LT	LEFT
I.E.	INVERT ELEVATION
P.C.	POINT OF CURVATURE
P.I.	POINT OF INTERSECTION
P.T.	POINT OF TANGENCY
R.	RADIUS
R.P.	RADIUS POINT
R/W	RIGHT-OF-WAY
ROW	RIGHT-OF-WAY
EX.	EXISTING
EXIST.	EXISTING
STA	STATION
S/W	SIDEWALK
C.S.B.C.	CRUSHED SURFACING BASE COURS
C.S.T.C.	CRUSHED SURFACING TOP COURSE
CL, Q	CENTERLINE
CB	CATCH BASIN
N/A	NOT APPLICABLE
A/C	ASPHALT CONCRETE
ACP	ASPHALT CONCRETE PAVEMENT
D.I.	DUCTILE IRON
SD	STORM DRAIN
SS	SANITARY SEWER
RPBA	REDUCED PRESSURE BACKFLOW ASSEMBLY
DIA, Ø	DIAMETER
A.P.	ANGLE POINT
V.P.I.	VERTICAL POINT OF INTERSECTION
V.P.C.	VERTICAL POINT OF CURVATURE
V.P.T.	VERTICAL POINT OF TANGENCY
EL.	ELEVATION
S. Y.	SQUARE YARD
C. Y.	CUBIC YARD
TYP.	TYPICAL
LUM.	LUMINAIRE
L.F.	LINEAR FEET
RD.	ROAD
DR.	DRIVE
PKWY.	PARKWAY
CONST.	CONSTRUCTION
FT.	FOOT
D/W	DRIVEWAY
APPROX.	APPROXIMATELY
U.O.N.	UNLESS OTHERWISE NOTED

CHANNELIZATION NOTES:

- CONTRACTOR SHALL REFRESH ALL EXISTING STRIPING AS DIRECTED BY THE ENGINEER.
- WHERE NEW CHANNELIZATION IS BEING INSTALLED ON EXISTING PAVEMENT, CONTRACTOR SHALL PREPARE EXISTING ROADWAY SURFACE PRIOR TO INSTALLATION AS DIRECTED BY
- 3. CONTRACTOR SHALL REMOVE EXISTING STRIPING OUTSIDE THE PAVING LIMITS AS DIRECTED BY THE ENGINEER. ANY EXISTING THERMOPLASTIC LINES IN CONFLICT WITH THE PROPOSED CHANNELIZATION SHALL BE REMOVED PRIOR TO PLACING NEW CROSSWALK LINES AND/OR STOP
- 4. FOR PROFILED PLASTIC LINE SEE WSDOT STANDARD PLAN M-20.20-01.

NME

NME

WA24AV_CS

CONSTRUCTION NOTES:

- 1. CALL 48 HOURS BEFORE YOU DIG 1-800-424-5555 OR 811.
- 2. THE CONTRACTOR SHALL FIELD VERIFY UTILITY LOCATIONS PRIOR TO CONSTRUCTION.
- 3. THE CONTRACTOR SHALL NOT REMOVE ANY TREES UNLESS INDICATED ON PLANS OR DIRECTED BY ENGINEER.
- 4. THE CONTRACTOR SHALL MATCH OVERLAY TO EXISTING PAVEMENT AND DRIVEWAYS AS DIRECTED BY THE ENGINEER.
- 5. GRINDING LIMITS AND PAVEMENT REPAIR LIMITS SHALL BE IDENTIFIED BY THE ENGINEER IN THE FIELD AND MAY VARY FROM THOSE SHOWN ON THE PLANS.
- 6. THE CONTRACTOR SHALL VERIFY QUANTITIES OF VALVE BOX, CATCH BASINS, AND MANHOLE COVERS TO BE RAISED OR ADJUSTED PRIOR TO PAVING OPERATIONS.
- 7. THE CONTRACTOR SHALL VERIFY VALVE BOX, CATCH BASIN, AND MANHOLE COVER DIMENSIONS AS WELL AS REQUIRED ADJUSTMENT HEIGHTS OF THE PAVING RISERS TO MATCH FINAL OVERLAY GRADES.
- 8. THE CONTRACTOR SHALL RESTORE ALL LANDSCAPING TO EQUAL OR BETTER THAN ORIGINAL CONDITIONS AS DIRECTED BY THE ENGINEER.
- 9. THE CONTRACTOR SHALL PROTECT ALL EXISTING SURVEY MONUMENTS AND PROPERTY CORNERS. THE CONTRACTOR SHALL BE RESPONSIBLE FOR ALL COSTS ASSOCIATED WITH RESTORING MONUMENTS OR PROPERTY CORNERS OUTSIDE OF THE CONSTRUCTION LIMITS.
- 10. ALL PAVEMENT REPAIR EXCAVATION AND DIGOUTS SHALL BE COMPLETED PRIOR TO PAVEMENT PLANING.
- 11. PAVEMENT REPAIR AREAS MAY REQUIRE EXTRA EXCAVATION AS DIRECTED BY THE ENGINEER.

EROSION CONTROL NOTE:

CONTRACTOR IS RESPONSIBLE FOR ESTABLISHING MAINTAINING EROSION CONTROL BMP'S IN ACCORDANCE WITH DEPARTMENT OF ECOLOGY REQUIREMENTS WHERE APPLICABLE TO MITIGATE SEDIMENT-LADEN RUNOFF FROM LEAVING THE WORK AREAS. REFER TO SECTION 8-01 OF THE PROJECT SPECIFICATIONS FOR INFORMATION RELATED TO WORK DESCRIPTION AND PAYMENT.

CITY OF LACEY, WASHINGTON DEPARTMENT OF PUBLIC WORKS 420 COLLEGE STREET SE

98503-1238

LACEY, WA

LACEY





DRAFTED: CHECKED: HORZ. SCALE: VERT. SCALE:

FILE:


NME 2024 WATER ANNUAL VALVES GENERAL NOTES

REVISION BLOCK		PAGE NO.	SHEET NO.	
NO.	DATE	DESCRIPTION	GN	2
			DWG_NO	OF
			D-24-08	4

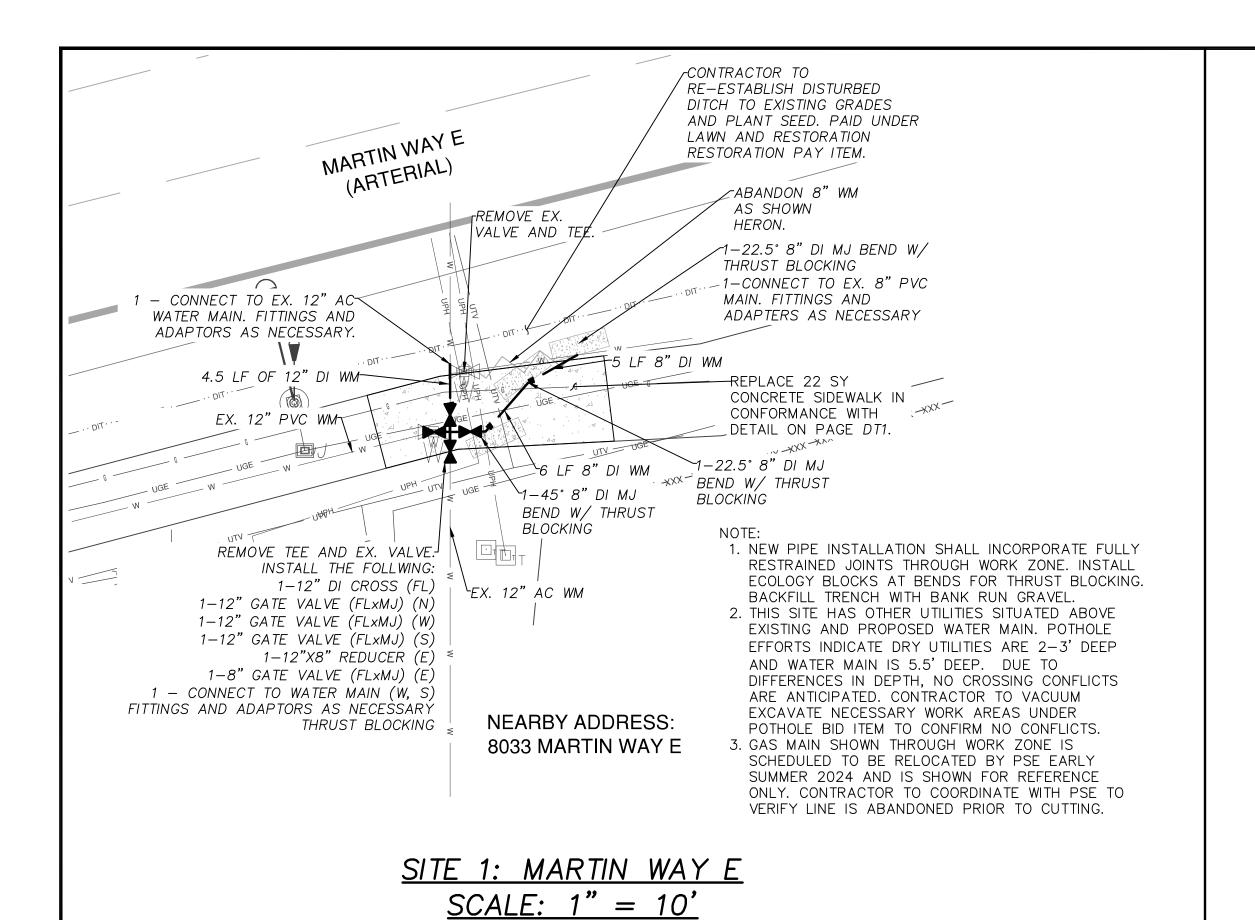


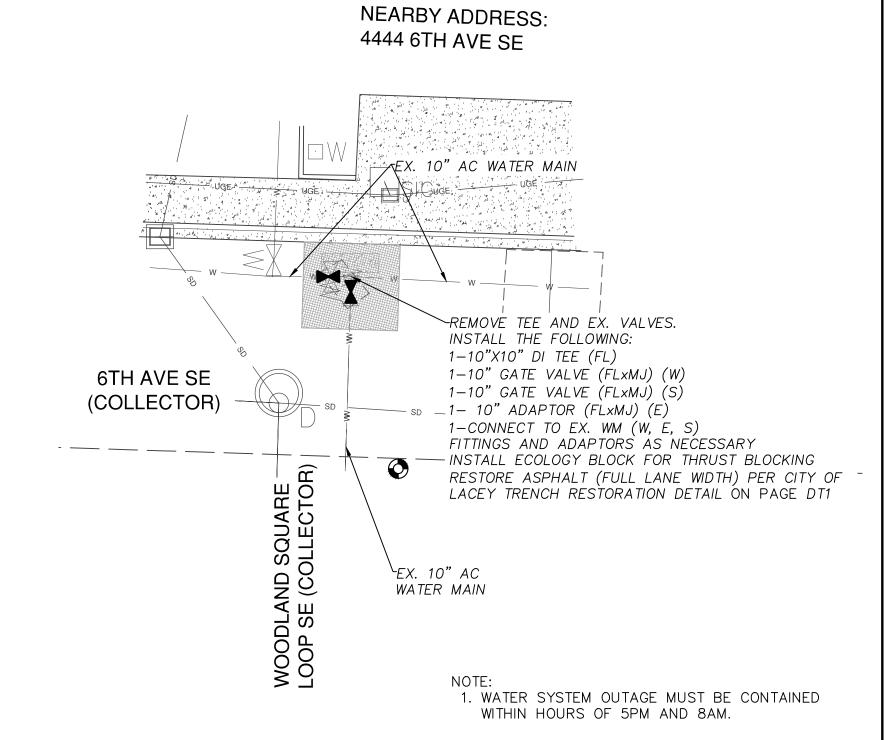

SITE 2: WOODLAND SQUARE LOOP AND 6TH AVE SE SCALE: 1" = 10' BID SCHEDULE A

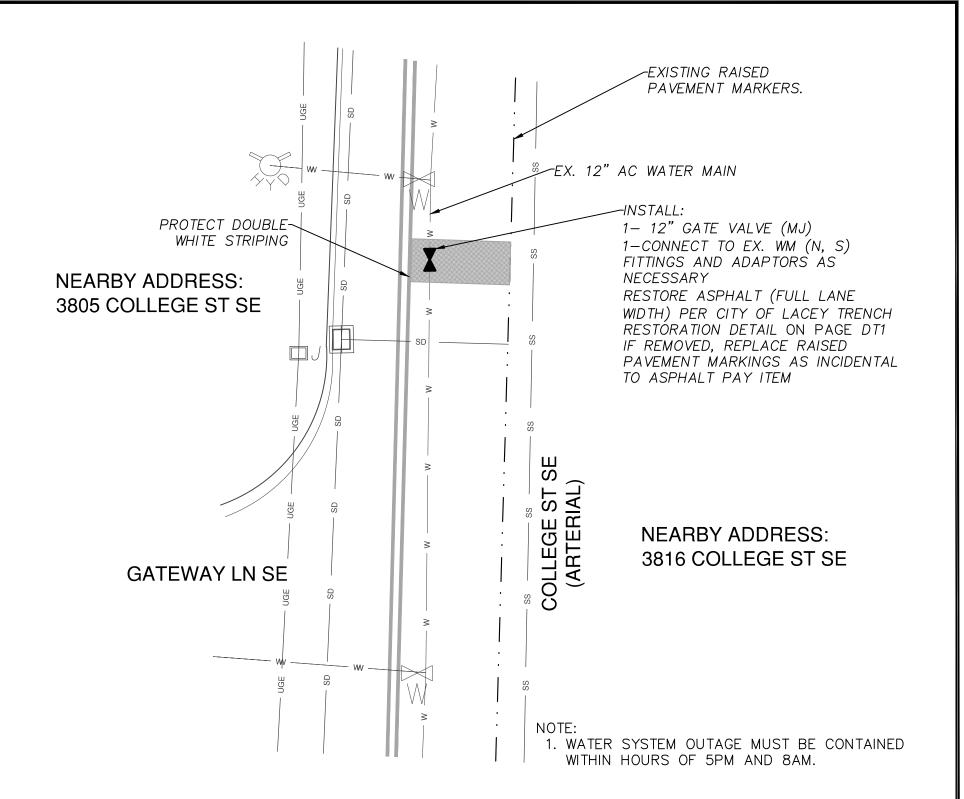


SITE 3: COLLEGE ST SE AND GATEWAY LN SE SCALE: 1" = 10' BID SCHEDULE A

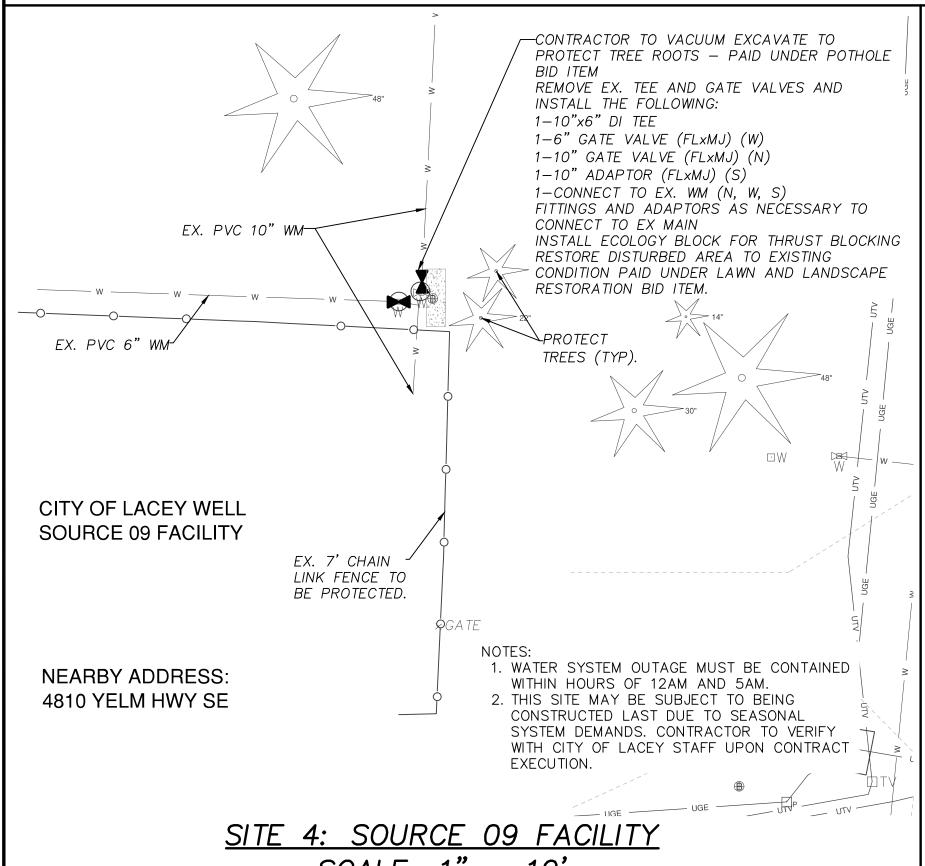


BID SCHEDULE A

SCALE: 1" = 10' BID SCHEDULE A

(360) 491-5600

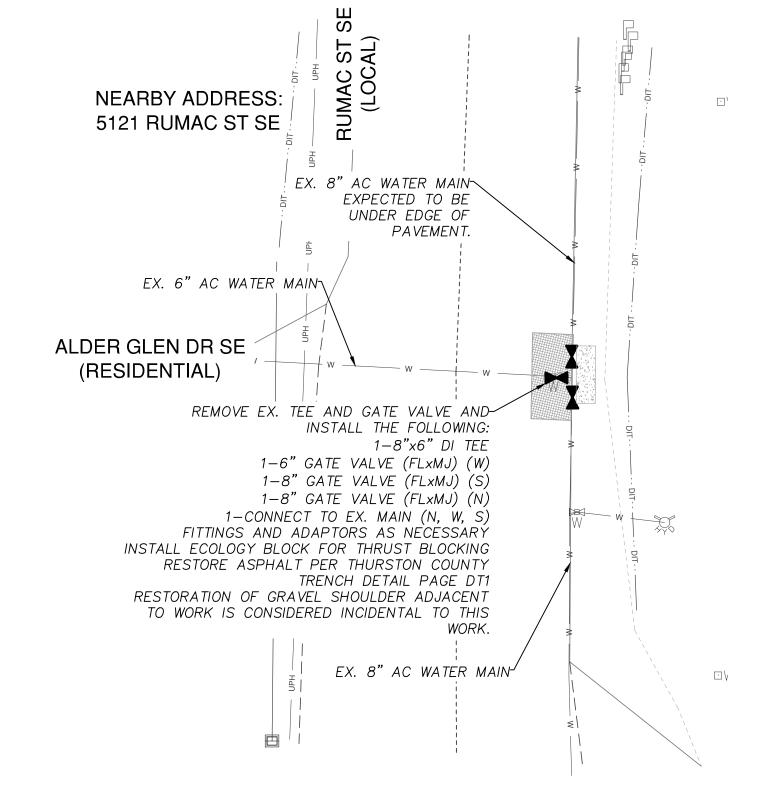

SITE 5: RUMAC ST SE & ALDER GLEN DR SE SCALE: 1" = 10'

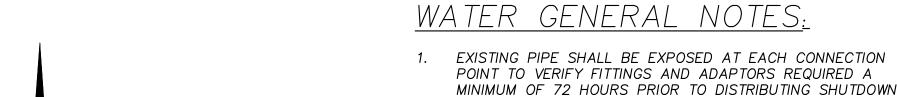

NOTICES. ALL FITTINGS REQUIRED TO COMPLETE THE CONNECTION SHALL BE ONSITE PRIOR TO SHUTDOWN. 2. THE CONTRACTOR SHALL POTHOLE ALL UTILITY CROSSING CONFLICTS. THE CONTRACTOR SHALL INFORM THE ENGINEER OF ALL CONFLICTS WITH THE PROPOSED PIPE

3. UNLESS OTHERWISE NOTED ON PLAN OR DIRECTED BY THE ENGINEER ALL NEW WATER MAIN SHALL HAVE A MINIMUM OF 42" OF COVER.

EROSION CONTROL NOTE:

PRIOR TO PIPE INSTALLATION.

CONTRACTOR IS RESPONSIBLE FOR ESTABLISHING MAINTAINING EROSION CONTROL BMP'S IN ACCORDANCE WITH CITY OF LACEY AND DEPARTMENT OF ECOLOGY REQUIREMENTS WHERE APPLICABLE TO MITIGATE SEDIMENT-LADEN RUNOFF FROM LEAVING THE WORK AREAS. REFER TO SECTION 8-01 OF THE PROJECT SPECIFICATIONS FOR INFORMATION RELATED TO WORK DESCRIPTION AND PAYMENT. IF THE CITY INSPECTOR OR ENGINEER REQUIRES SITE-SPECIFIC BMP'S NOT SPECIFICALLY CALLED OUT, THIS WILL BE PAID UNDER THE EROSION CONTROL PAY ITEM.

BID SCHEDULE B

CITY OF LACEY, WASHINGTON DEPARTMENT OF PUBLIC WORKS 420 COLLEGE STREET SE

98503-1238

LACEY, WA

LACEY





NME DRAFTED: NME **NME** CHECKED: HORZ. SCALE: 1"=10' **VERT. SCALE:** WA24AV_UT


2024 WATER ANNUAL VALVES WATER PLANS


CITY OF LACEY COORDINATE SYSTEM


REVISION BLOCK		REVISION BLOCK	PAGE NO.	SHEET NO.
NO.	DATE	DESCRIPTION		
			WA1	3
				0
			DWG NO.	OF
				0.
			D-24-08	1

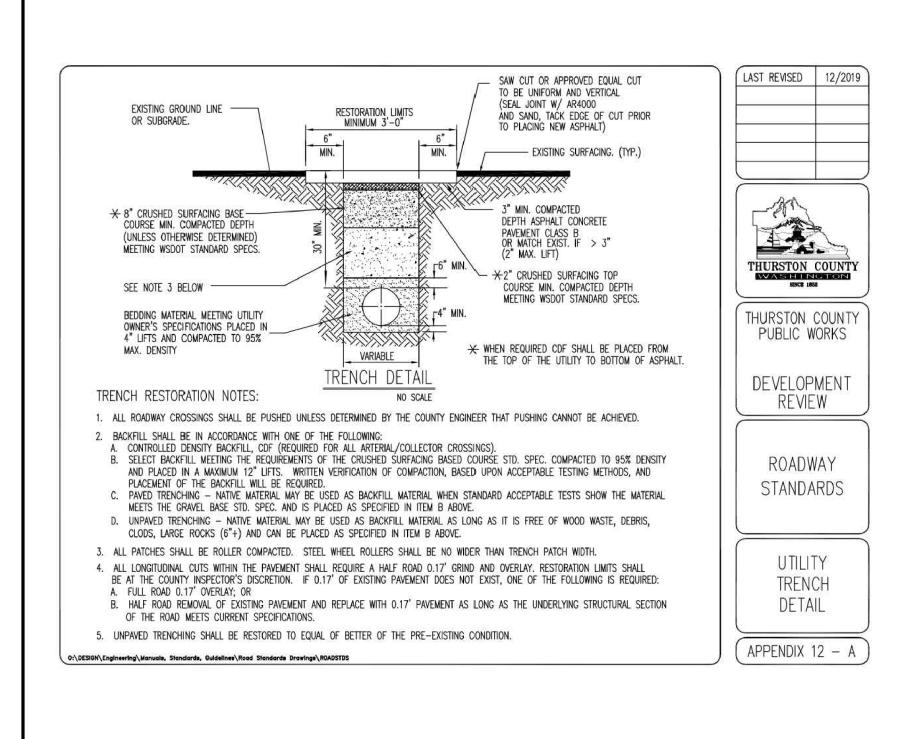


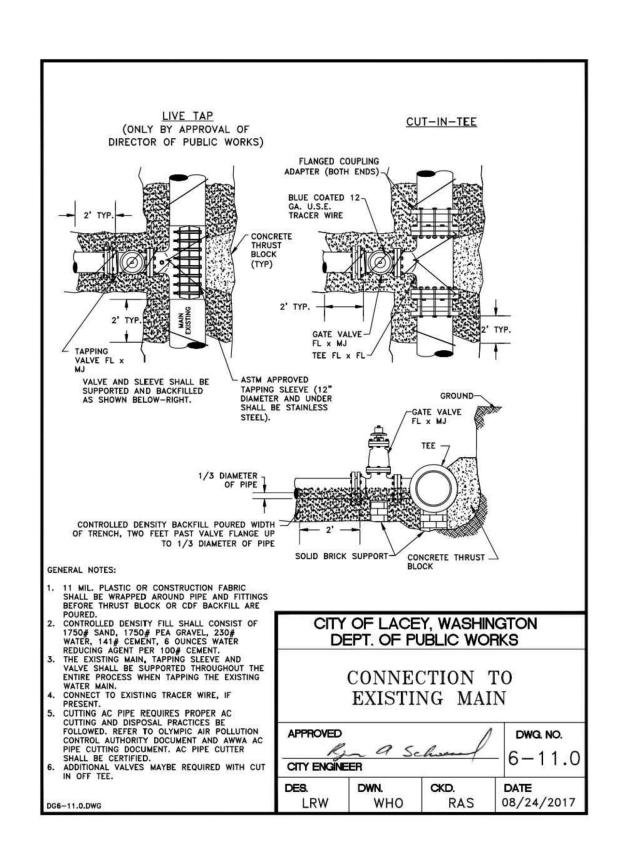

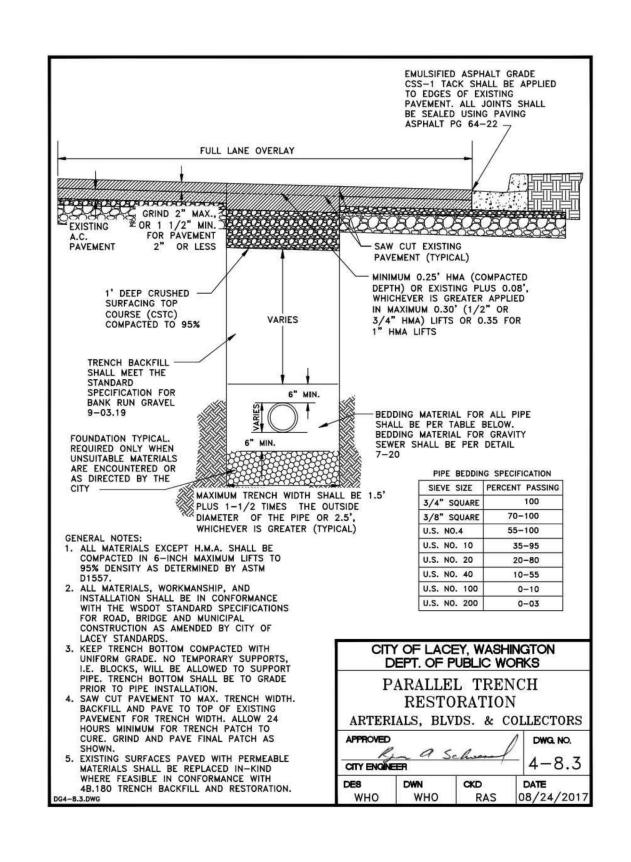

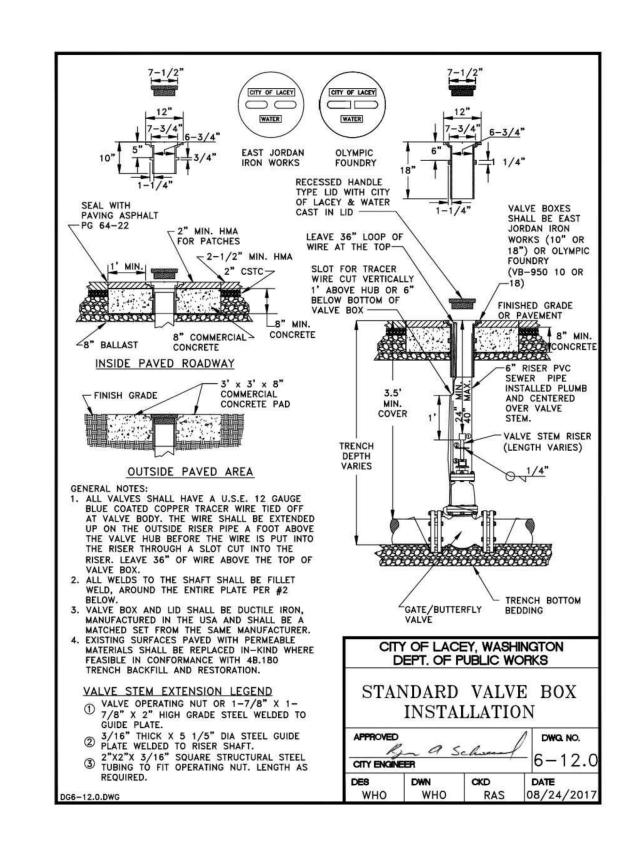

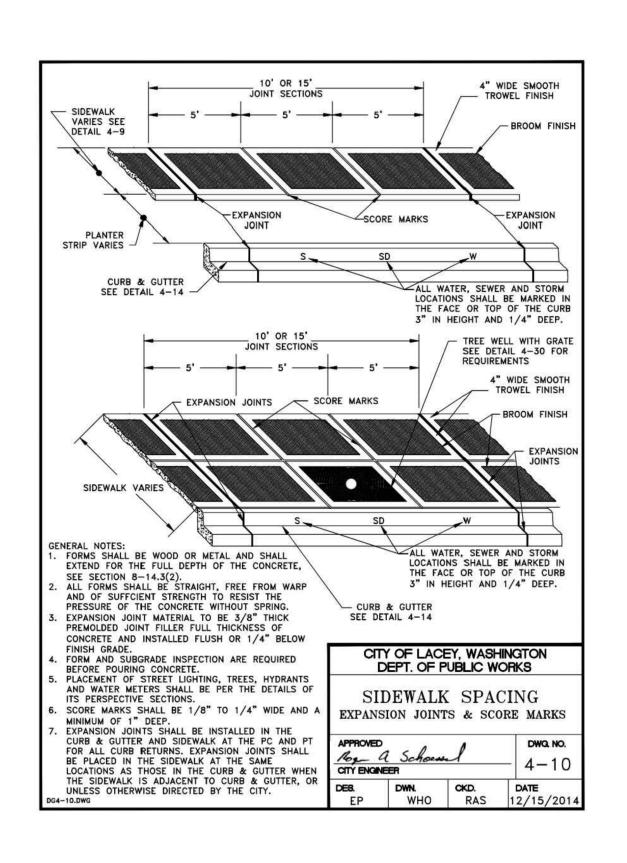


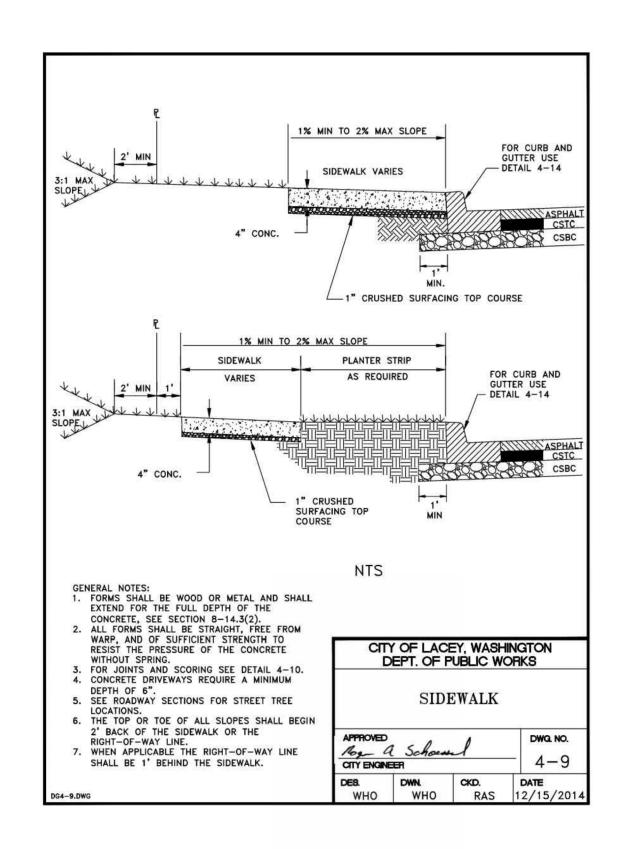

CITY OF LACEY, WASHINGTON DEPARTMENT OF PUBLIC WORKS 420 COLLEGE STREET SE

98503-1238

(360) 491-5600

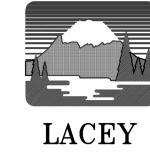

MARK
OF WASHINGTON

PROJECTION

6/5/20

DESIGNED: NME
DRAFTED: NME
CHECKED: NME
HORZ. SCALE: 1*=10'
VERT. SCALE: WA24AV_UT

2024 WATER ANNUAL VALVES
DETAILS SHEET

	RE	VISION BLOCK	PAGE NO.	SHEET NO.
NO.	DATE DESCRIPTION		DT1	4
			DWG NO.	OF
			D-24-08	4